Lower Hill - Curtain Call

Pittsburgh, Allegheny County, Pennsylvania

100% Construction Documents April 28, 2023





Project Location Map

Lower Hill - Curtain Call Location Plans

NTS

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Lower Hill-Curtain Call

Project Number: 21020:1

Drawn by: DM | CT

FB | DM April 28, 2023

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Sheet Name:

Cover Sheet

Submission:

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GENERAL & PROJECT SPECIFIC REQUIREMENT NOTES:

- 1. Contractor to provide material samples, product cut sheets, product mockups, etc. for all site and landscape related improvements per the specifications.
- 2. Contractor to supply the source of all landscaping materials.
- 3. Contractor to supply unit cost for all site and landscape improvements required by the drawings and specifications. Unit costs to include material cost, transportation cost, labor and installation cost, and warranty.
- 4. Contractor to coordinate with Landscape Architect for tree tagging at the selected nursery prior to approval.

SURVEY/PRIOR TO CONSTRUCTION NOTES:

- 1. Existing boundary line, topographic and site utility information is based upon PAR provided survey plans with additional spot elevations provided by Urban Terrain, actual conditions may have changed since survey was performed. Contractor shall verify existing conditions in the field and report any discrepancies to landscape architect.
- 2. Contractor shall obtain and review all relevant drawings, details and specifications prior to beginning construction. Any discrepancies shall be brought to the attention of the Landscape Architect immediately.
- 3. Parking of all non-construction vehicles to be directed by the PAR.
- 4. Contractor shall protect all existing utilities and site improvements that are noted to remain and shall coordinate with Pennsylvania One Call System, Inc. to verify location of all utilities.
- Contractor is responsible for installing and maintaining a construction fence around the perimeter of work for the duration of the construction.
- 6. Contractor shall coordinate locations of alternate walks with the PAR.
- 7. Contractor is responsible for maintaining access to all buildings during the course of this project. The Contractor shall coordinate with the PAR to determine a construction schedule.
- 8. All fuel storage tanks need to be double walled and in a containment bed.
- Protect all trees in and near the limit of work per the detail shown below. However, it is understood that some trees are closer to the existing and/or proposed walks and it will be difficult to remain outside the of the dripline during construction. In these instances protect the tress to the greatest extents possible.

DEMOLITION NOTES:

- 1. Erosion and sediment control measures around areas of demolition shall be installed prior to initiation of demolition activities. Refer to E&S plan for details.
- 2. Contractor shall remove and properly dispose off-site all items noted to be removed. All items become the property of the contractor unless otherwise noted.
- Saw cut all pavement prior to excavation. Saw cut pavement full depth where pavement is to be removed and where it abuts pavement to remain. Pavement removal includes subbase materials. Saw cut concrete pavement to the next nearest existing joint.
- 4. Conduits and wiring required for the continuity of lighting, outlets, systems, and equipment that is to remain shall remain undisturbed or to be reconnected as required to maintain service.
- Contractor to protect all features that are to remain.
- Remove trees and shrubs indicated on the demolition plan in their entirety, including the root ball.

SITE NOTES

- 1. The existence and locations of underground utilities indicated on the drawings are not guaranteed. Locate and identify existing underground and overhead services and utilities within contract limit work areas. Notify PAR and landscape architect immediately of any conflict with utilities or existing site elements including those shown and not shown on survey. Provide adequate means of protection of utilities and services designated to remain. Repair utilities damaged during site work operations at Contractors expense.
- 2. Control dust caused by the work. Dampen surfaces as required. Comply with pollution control regulations of governing authorities.
- 3. Protect existing buildings, paving, and other services or facilities on site and adjacent to the site from damage caused by site work operations. Cost of repair and restoration of damaged items at Contractor's expense.
- 4. All proposed site improvements are to be staked in field for approval by PAR and landscape architect prior to construction. Any discrepancies or conflicts with existing conditions or other drawings shall be reported to the landscape architect immediately for proper clarification or adjustment.
- 5. Verify all dimensions and elevations in field prior to installation.
- 6. Contractor is responsible for pedestrian safety and circulation during construction of each area including but not limited to all signage, barriers, and temporary work.
- 7. All disturbed areas to be regraded to ensure positive drainage away from building and seeded if not in
- 8. Concrete Mixes: Prepare and submit design mixes, proportioned according to ACI 211.1 and ACI 301, with the following properties:
- a. Compressive Strength (28 Days): 3500 psi (24.1 MPa).
- b. Slump: 4 inches (100 mm).
- c. Air Content: 4.5 to 7.0 percent.
- 10. Leave formwork, for beam soffits, joists, slabs, and other structural elements, that supports weight of concrete in place until concrete has achieved 28-day design compressive strength.
- 11. Vapor Retarder: Place, protect, and repair vapor-retarder sheets according to ASTM E 1643.
- 12. Concrete Placement: Deposit concrete continuously and avoid segregation. Deposit concrete in forms in horizontal layers no deeper than 24 inches (600 mm), avoiding cold joints. a. Consolidate concrete with mechanical vibrating equipment.
- b. Screed and initial-float concrete floors and slabs using bull floats or darbies to form a uniform and open-textured surface plan, free of humps or hollows, before excess moisture or bleed water appears on the surface. Do not disturb slab surfaces before starting finishing operations.
- c. Comply with ACI 306.1 for cold-weather concrete placement.
- d. Place concrete according to recommendations in ACI 305R when hot-weather conditions exist.
- e. Broom Finish: Apply a broom finish to exterior concrete, brooming with fiber-bristle broom perpendicular to main traffic route, to platforms, steps, and ramps, and elsewhere as indicated.
- f. Exposed Aggregate: Selected, hard, and durable; washed; free of materials with deleterious reactivity to cement or that cause staining; from a single source, with gap-graded coarse aggregate as follows: f.a. Aggregate Sizes: 3/8 to 5/8 inch (10 to 16 mm) nominal.
- f.b. Aggregate Source, Shape, and Color: TBD.
- 13. Cross slope on walks to be a maximum of 2% ensuring proper drainage across all walks.
- 14. Apply evaporation retarder to unformed concrete surfaces if hot, dry, or windy conditions cause excessive moisture loss.
- 15. Begin curing after finishing concrete but not before free water has disappeared from concrete surface.
- 16. Cure formed and unformed concrete for at least seven days by moisture curing, moisture-retaining-cover curing, or curing compound.
- 17. Testing Agency: Contractor will engage a qualified independent testing and inspecting agency to sample materials, perform tests, and submit test reports during concrete placement. Tests shall be performed according to ACI 301.
- 18. Defective Concrete: Repair and patch defective areas when approved by landscape architect. Remove and replace concrete that cannot be repaired and patched to landscape architect's approval.
- 19. Install Expansion Joints where new concrete meets existing concrete and at locations shown on plan, approximately 20'-0" o.c. Scorelines and expansion joints in all new concrete to be tooled. All expansion joints to be caulked. Submit product data sheet and color selections for approval prior to installation.
- 20. Seal concrete with Prosoco Saltguard WB or approved equal. Submit product data sheet for approval prior
- 21. Coordinate all utilities with engineering and landscape architectural drawings.
- Contractor to verify electrical feed for relocated light fixtures.
- 23. Install conduit 2'-0" minimum below finished grade.

GRADING NOTES:

- 1. Contractor shall verify all existing grades in the field and report any discrepancies to the landscape architect. Contractor shall stake all elevations to be approved by the landscape architect before construction.
- 2. All lines and grade work not presently established at the site shall be laid out by a registered land surveyor or professional civil engineer employed by the contractor in accordance with the contract documents. Contractor shall establish permanent benchmarks and bounds and replace any which are destroyed or disturbed.
- 3. Spot elevations shall govern over proposed contours.
- 4. Contractor shall ensure consistent slope between spot elevations.
- 5. At ridge lines, high points and low points, contractor shall transition grade to avoid a point or sharp edge.
- 6. Contractor shall not perform work outside the designated site boundary, if field conditions warrant off-site grading, permission shall be obtained by contractor from the affected property owners.
- 7. All sidewalks, stoops, terraces and other paved areas shall slope away from building(s) at 2.0%.
- 8. For slope construction 3:1 and steeper the contractor shall coordinate with a geotechnical engineer on the suitability of soils planned for these slopes and follow recommendations set forth by the geotechnical engineer for slope construction. Top soil placement on slopes shall be installed in a benched pattern.
- 9. Contractor to coordinate topsoil required or to be removed for the project with owner. Owner to supply topsoil or location of topsoil to be used, contractor is responsible for amending the soil as required to meet the specification.



Pittsburgh, Pennsylvania 15203 www.laquatrabonci.com 412.488.8822

95 South Tenth Street



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Lower Hill-Curtain Cal Pittsburgh, PA

Project Number: 21020:1

Drawn by DM | CT

FB | DM

Checked by:

April 28, 2023

Revisions:

Sheet Name:

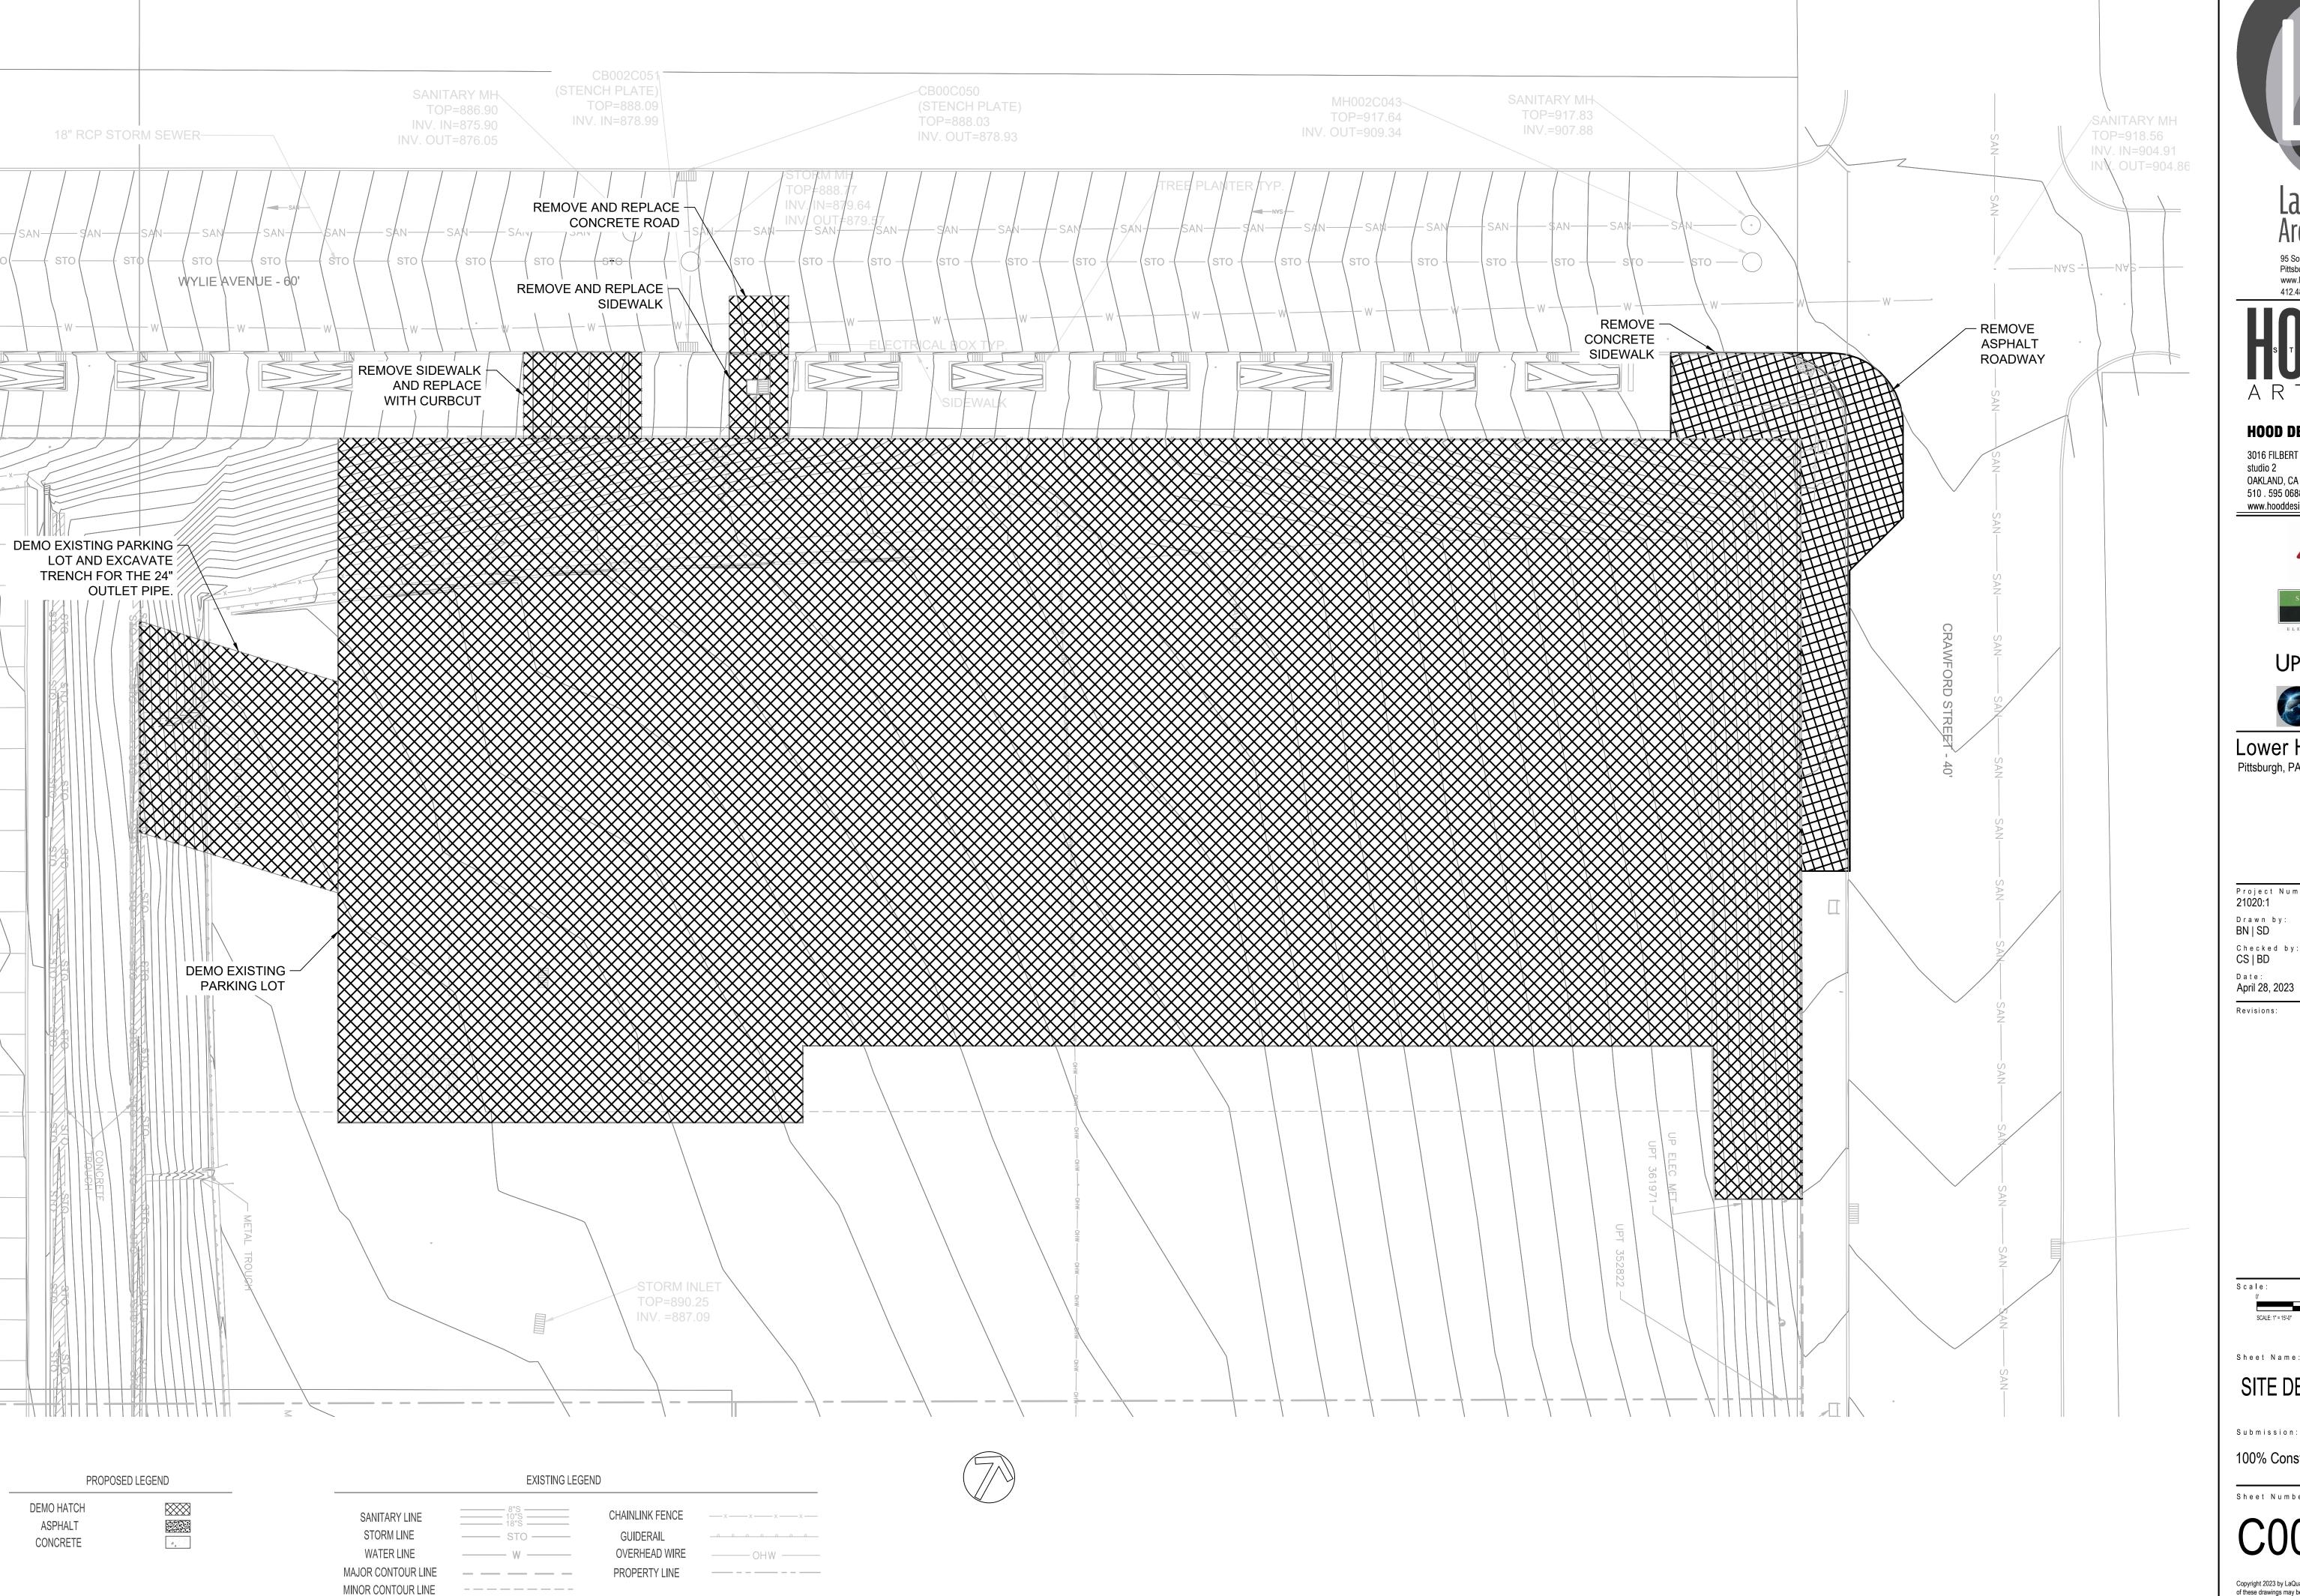
Construction Notes

Submission:

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Pittsburgh, PA

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Drawn by: BN | SD

CS | BD

Revisions:

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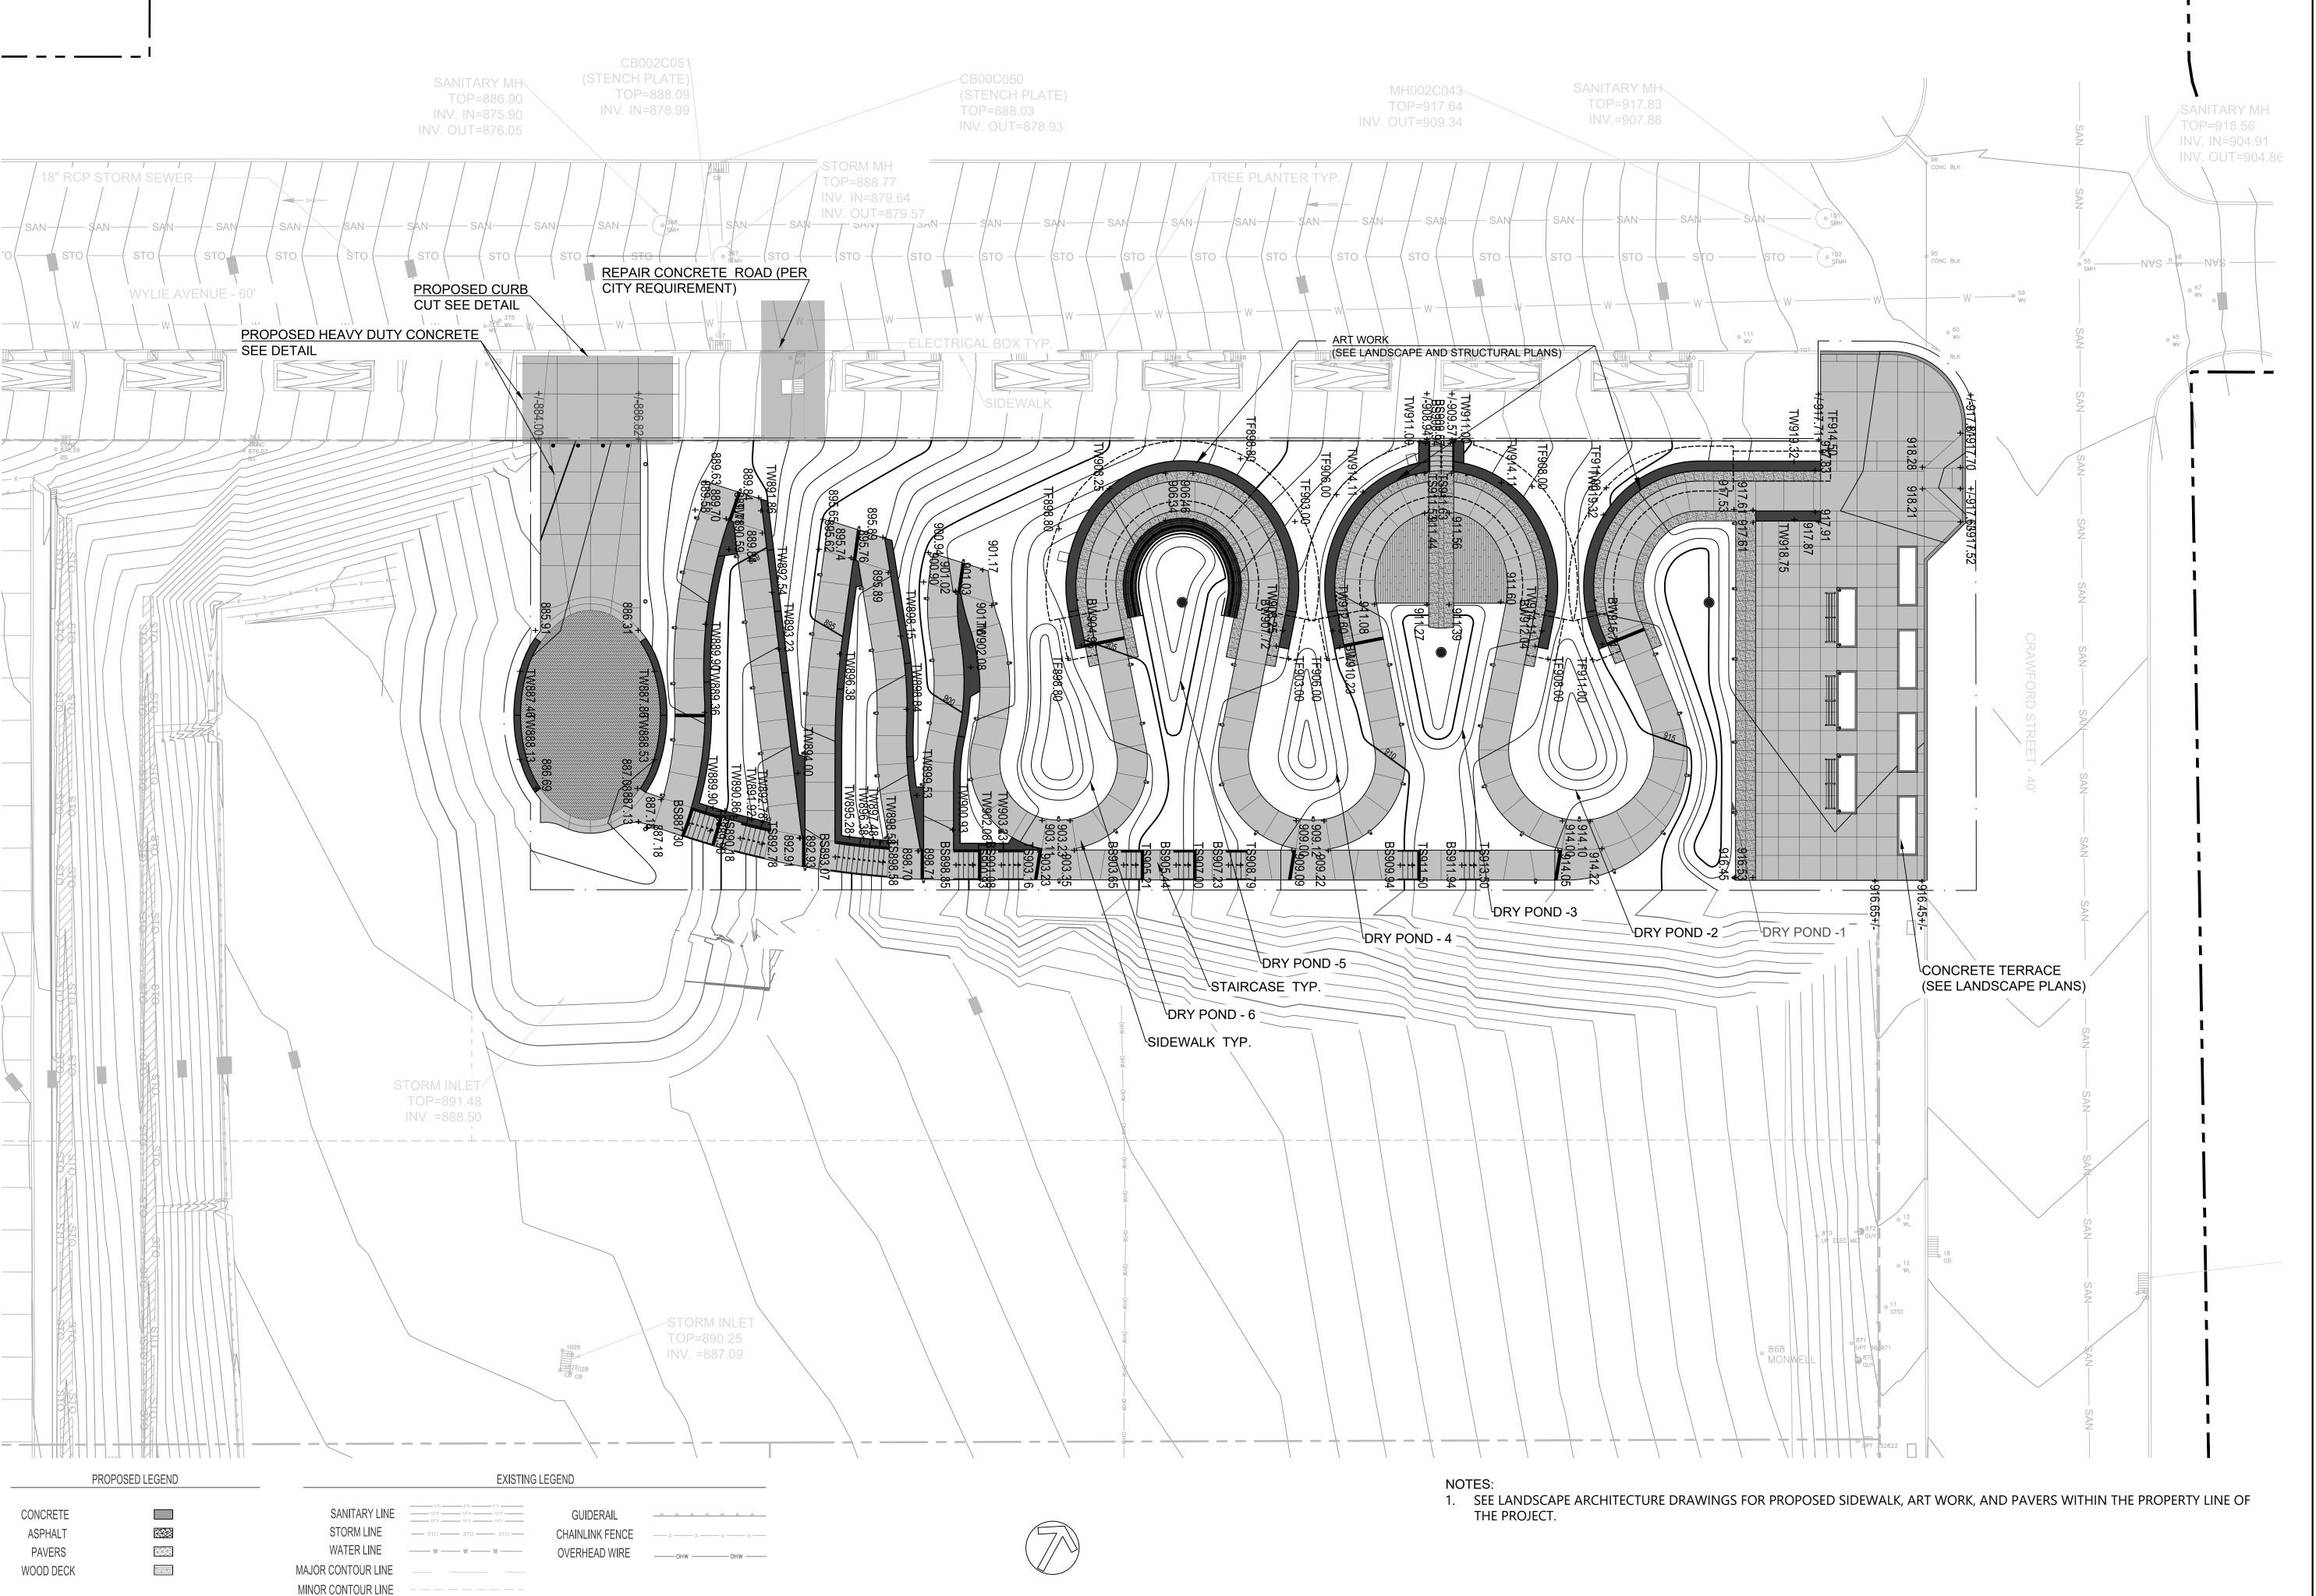
SITE DEMOLITION PLAN

Submission:

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MAJOR CONTOUR LINE

MINOR CONTOUR LINE ——————



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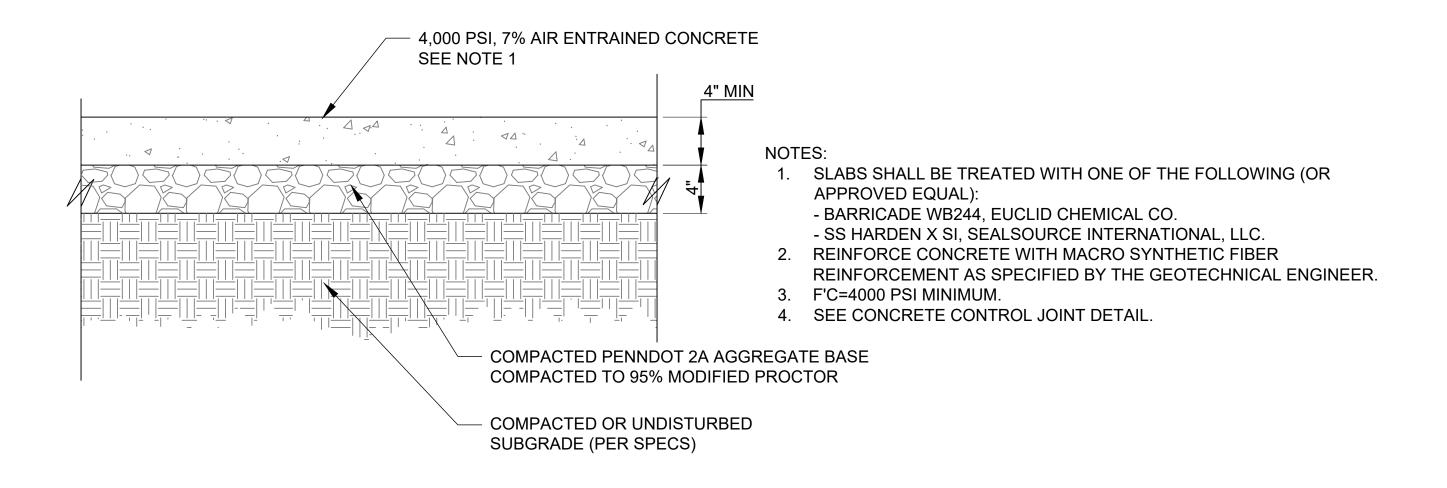
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SITE IMPROVEMENTS PLAN

Submission:

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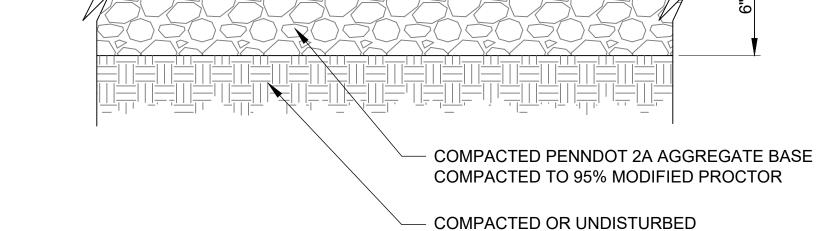
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STANDARD DUTY CONCRETE PAVEMENT PAD SECTION

SCALE:NT



NOTES

- SLABS SHALL BE TREATED WITH ONE OF THE FOLLOWING (OR APPROVED EQUAL):
 BARRICADE WB244, EUCLID CHEMICAL CO.
 - SS HARDEN X SI, SEALSOURCE INTERNATIONAL, LLC.
- 2. REINFORCE CONCRETE WITH MACRO SYNTHETIC FIBER REINFORCEMENT AS SPECIFIED BY THE GEOTECHNICAL ENGINEER.

SUBGRADE (PER SPECS)

SEE NOTE 1

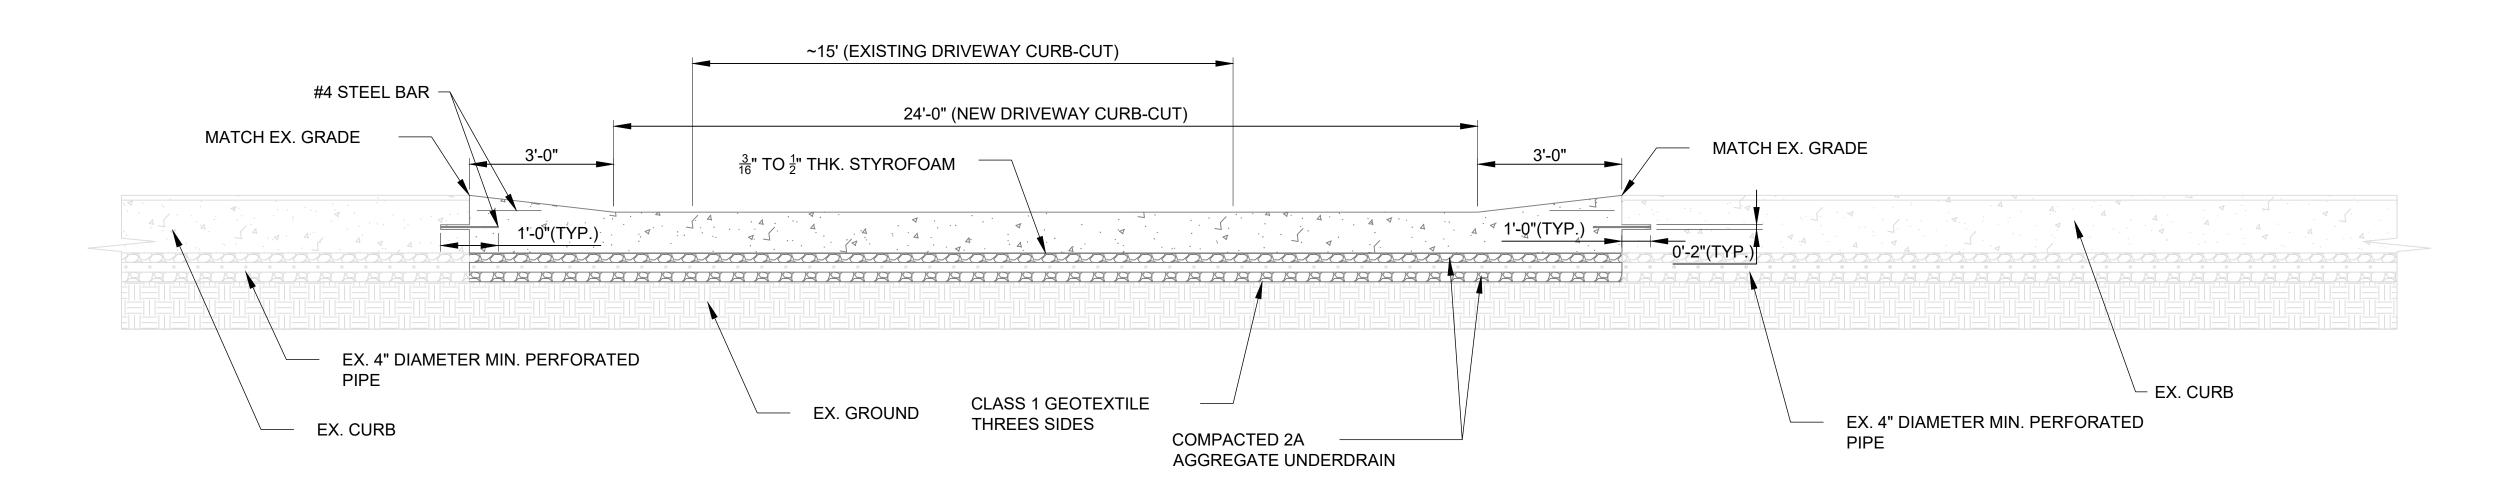
4,000 PSI, 7% AIR ENTRAINED CONCRETE

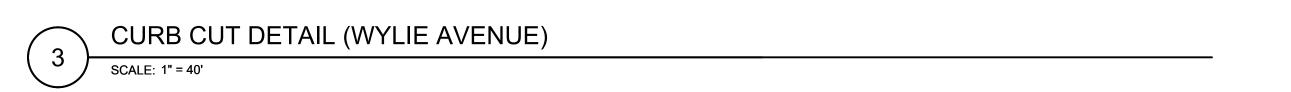
- 3. F'C=4000 PSI MINIMUM.
- 4. SEE CONCRETE CONTROL JOINT DETAIL.



SCALE: NTS

HEAVY DUTY CONCRETE PAVEMENT PAD SECTION







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S c a l e :

0' 10' 20

SCALE: 1" = 10'-0"


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SITE IMPROVEMENTS

100% Construction Documents


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C101



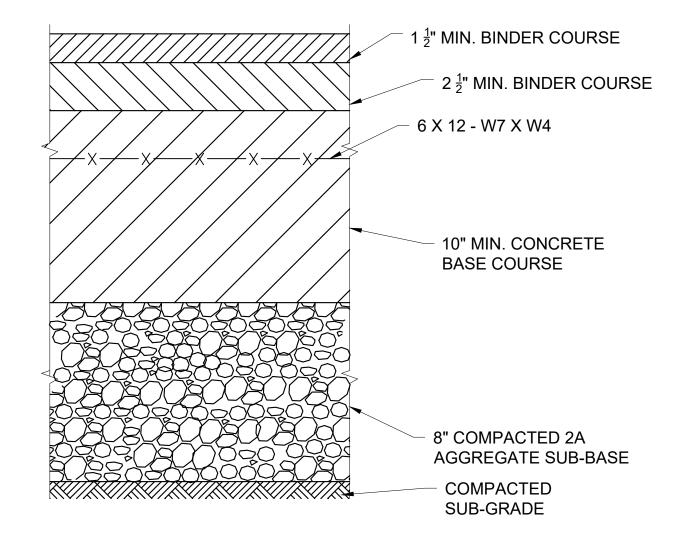BITUMINOUS PAVEMENT FOR PRIMARY (ARTERIAL AND COLLECTOR) STREETS CITY OF PITTSBURGH STANDARDS OF CONSTRUCTION


SCALE:NTS

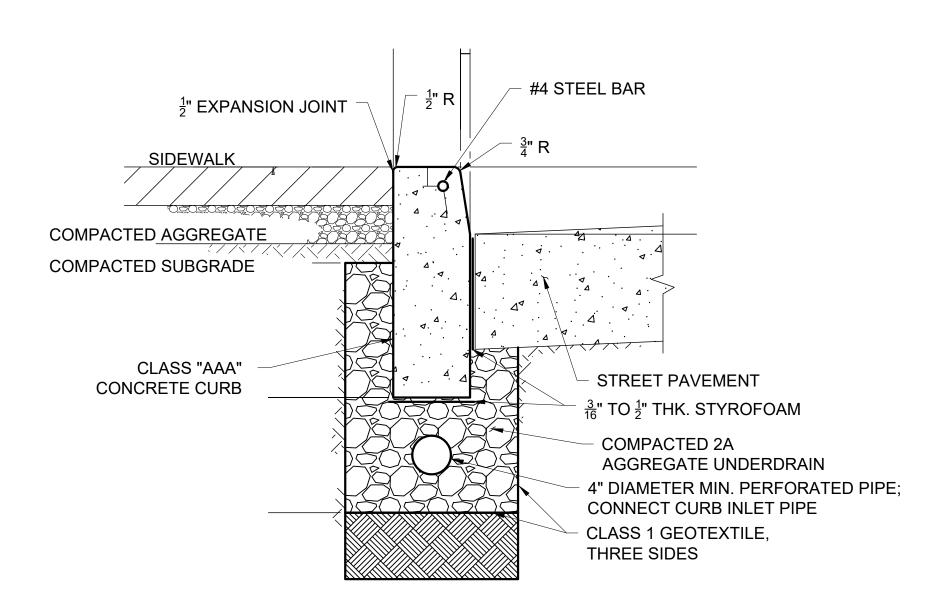

- 1. CURB CONSTRUCTION JOINTS SHALL BE SPACED AT A MAXIMUM OF 10'-0", AND SHALL COINCIDE WITH TRANSVERSE JOINTS IN PAVEMENT AND/OR BASE.
- 2. EXTEND ALL PAVEMENT JOINTS THROUGH CURB.
- 3. ALL CONCRETE CURB SHALL BE CURED BY THE SAME METHOD AS CONCRETE PAVEMENT OR BASE COURSE.
- 4. PERFORATED PIPE MAY BE OMITTED FROM UNDERDRAIN AS DIRECTED BY THE DPW.


CONCRETE DEEP CURB 7" REVEAL CITY OF PITTSBURGH STANDARDS OF CONSTRUCTION

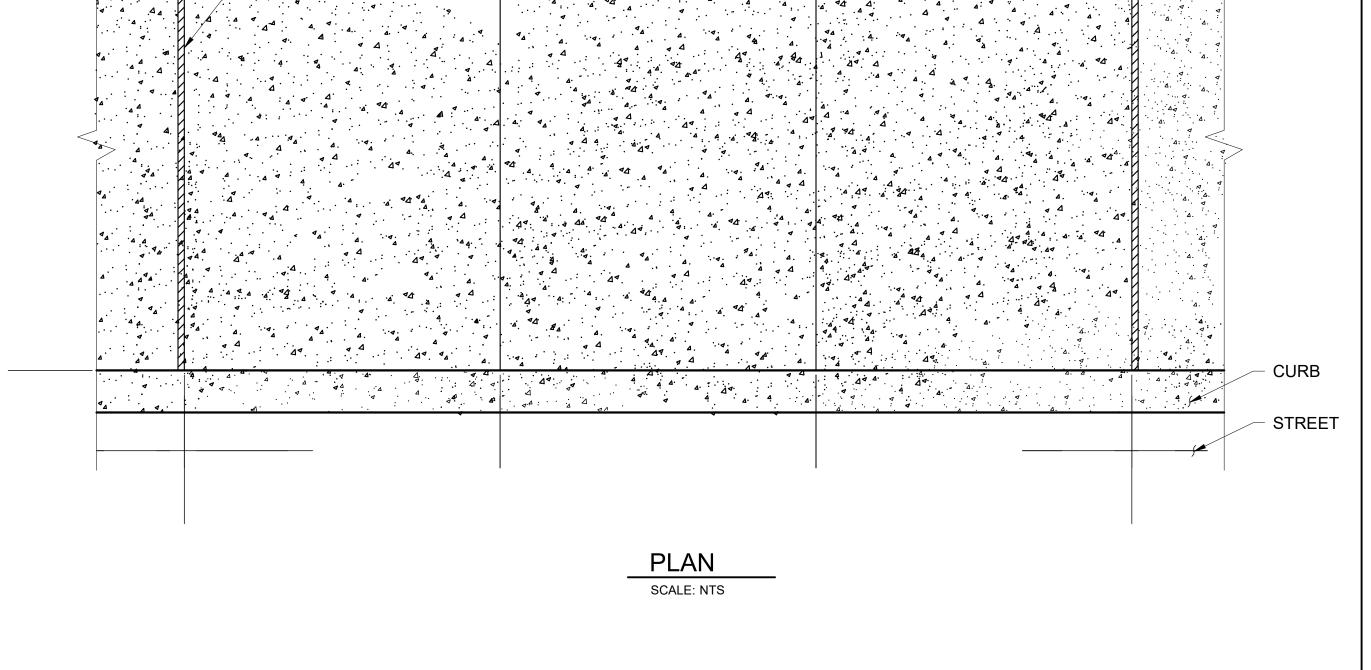SCALE:NTS




CONTROL

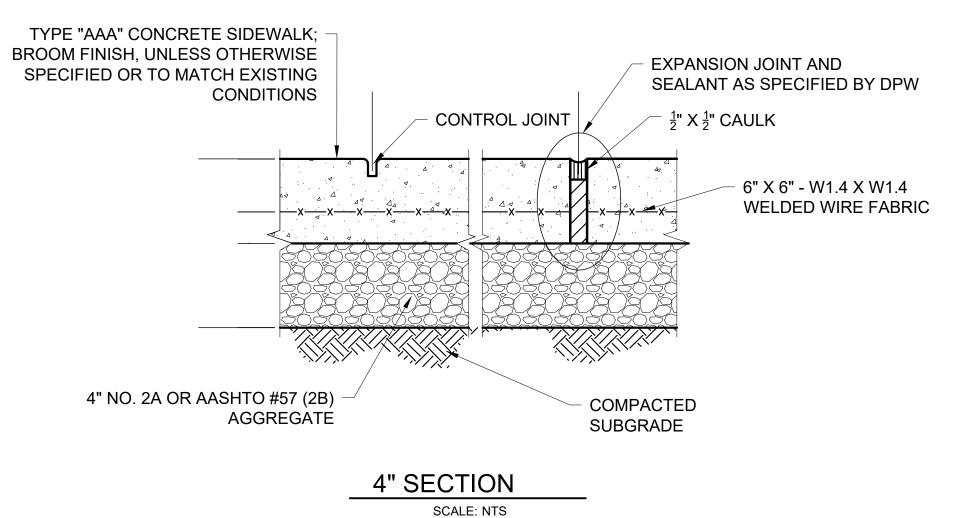JOINT



EXPANSION

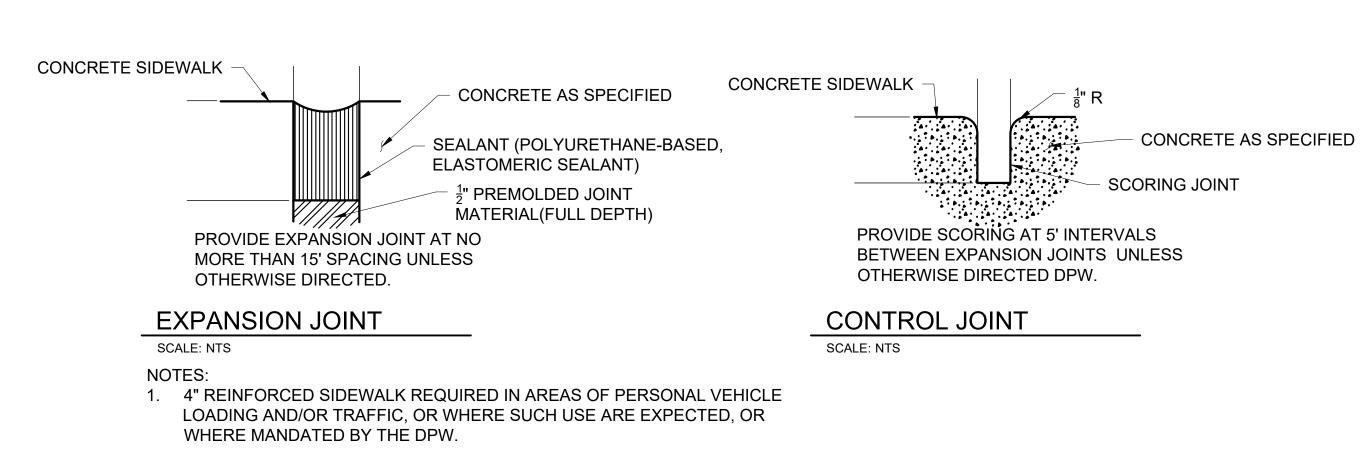JOINT



2. PADOT CLASS "AAA" SHALL HAVE COMPRESSIVE CAPACITY OF 4000 PSI AT 28 DAYS.

3. ALL PAVEMENT JOINT SHALL BE EXTENDED THROUGH CURB WHEN COINCIDENTAL WITH CURB JOINT.

4. EACH PAD SHALL NOT EXCEED 36.0 SF.

SCALE:NTS



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Lower Hill-Curtain Call Pittsburgh, PA

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Revisions:

Scale:


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SITE IMPROVEMENTS DETAILS Submission:

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Sheet Number:

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Point #	Northing	Easting	Point #																														
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7	34329.3494	112156.6729	28	34323.3141	112157.0954	48	34326.1513	112153.5591	69	34327.1200	112150.9439	89	34322.3238	112150.4519	109	34320.6552	112147.0005	129	34320.1658	112144.1416	149	34319.6733	112141.2486	169	34317.7342	112139.6605	189	34316.0259	112142.2320	209	34319.8527	112149.3089	229
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11	34328.3956	112156.3406	31	34331.1979	112156.7403	51	34327.6748	112152.2265	72	34327.1747	112148.9560	92	34321.3572	112148.5799	112	34322.4137	112145.8135	132	34318.3080	112146.2714	152	34316.8269	112143.1469	172	34315.6534	112140.3328	192	34317.1567	112144.0022	212	34320.5199	112150.5483	1
12	34327.5567	112156.7742	32	34329.8820	112154.9204	52	34327.6976	112152.0614	73	34326.8673	112149.1149	93	34322.7510	112148.1725	113	34322.6419	112145.6318	133	34318.5744	112146.7795	153	34320.3655	112135.7809	173	34315.0949	112140.3819	193	34316.6957	112144.1971	213	34320.5006	112150.5625	ĺ
13	34327.4289	112156.5270	33	34330.0301	112154.8438	53	34325.8074	112152.9356	74	34327.0586	112149.4851	94	34322.7973	112148.3326	114	34323.5914	112145.3713	134	34321.7063	112141.5574	154	34321.1311	112137.2622	174	34315.6088	112140.1163	194	34317.3888	112144.5220	214	34321.1694	112151.8565	Í
14	34327.0346	112156.7307	34	34330.1782	112154.7673	54	34325.6808	112152.8273	75	34325.5090	112151.2688	95	34323.1629	112148.3921	115	34321.5300	112145.2389	135	34321.5382	112140.5877	155	34322.0674	112139.0738	175	34317.6876	112137.1658	195	34317.3652	112144.4717	215	34320.7252	112152.0860	I
15	34327.1624	112156.9780	35	34329.2898	112155.2265	55	34325.5182	112153.0172	76	34324.7188	112150.6474	96	34325.1352	112147.1035	116	34321.6338	112145.3693	136	34321.1468	112141.2570	156	34322.2204	112139.3699	176	34317.5404	112137.1394	196	34317.6104	112144.9703	216	34321.6413	112152.7696	I
16	34326.1951	112157.1646	36	34329.1417	112155.3030	56	34325.6449	112153.1256	77	34324.5658	112150.3513	97	34324.9874	112147.0266	117	34321.3731	112145.5770	137	34321.1610	112141.3391	157	34321.3358	112139.4194	177	34317.5257	112137.2495	197	34317.1662	112145.1998	217	34321.1971	112152.9991	l
17	34326.3229	112157.4118	37	34328.7591	112154.5627	57	34325.3739	112153.4421	78	34324.9168	112150.1230	98	34325.1375	112145.3773	118	34321.4769	112145.7074	138	34320.4820	112143.0582	158	34321.1857	112138.5535	178	34317.0687	112137.2561	198	34317.8017	112145.3404	218	34321.8593	112154.2807	l
18	34325.8009	112157.3683	38	34328.6443	112154.3406	58	34325.5005	112153.5505	79	34323.1224	112151.9902	99	34323.7052	112144.5458	119	34320.3437	112146.6094	139	34319.2087	112143.6818	159	34320.7739	112139.1054	179	34315.6208	112138.0052	199	34317.3575	112145.5700	219	34322.2742	112153.9942	l
19	34325.9287	112157.6156	39	34329.1164	112153.0532	59	34324.8842	112154.2706	80	34322.6160	112150.8577	100	34323.7280	112144.3807	120	34318.9770	112146.4822	140	34319.3377	112144.1649	160	34320.7882	112139.1876	180	34315.3519	112138.3739	200	34318.1461	112146.0067	220	34308.4664	112138.1799	l

EXISTING LEGEND

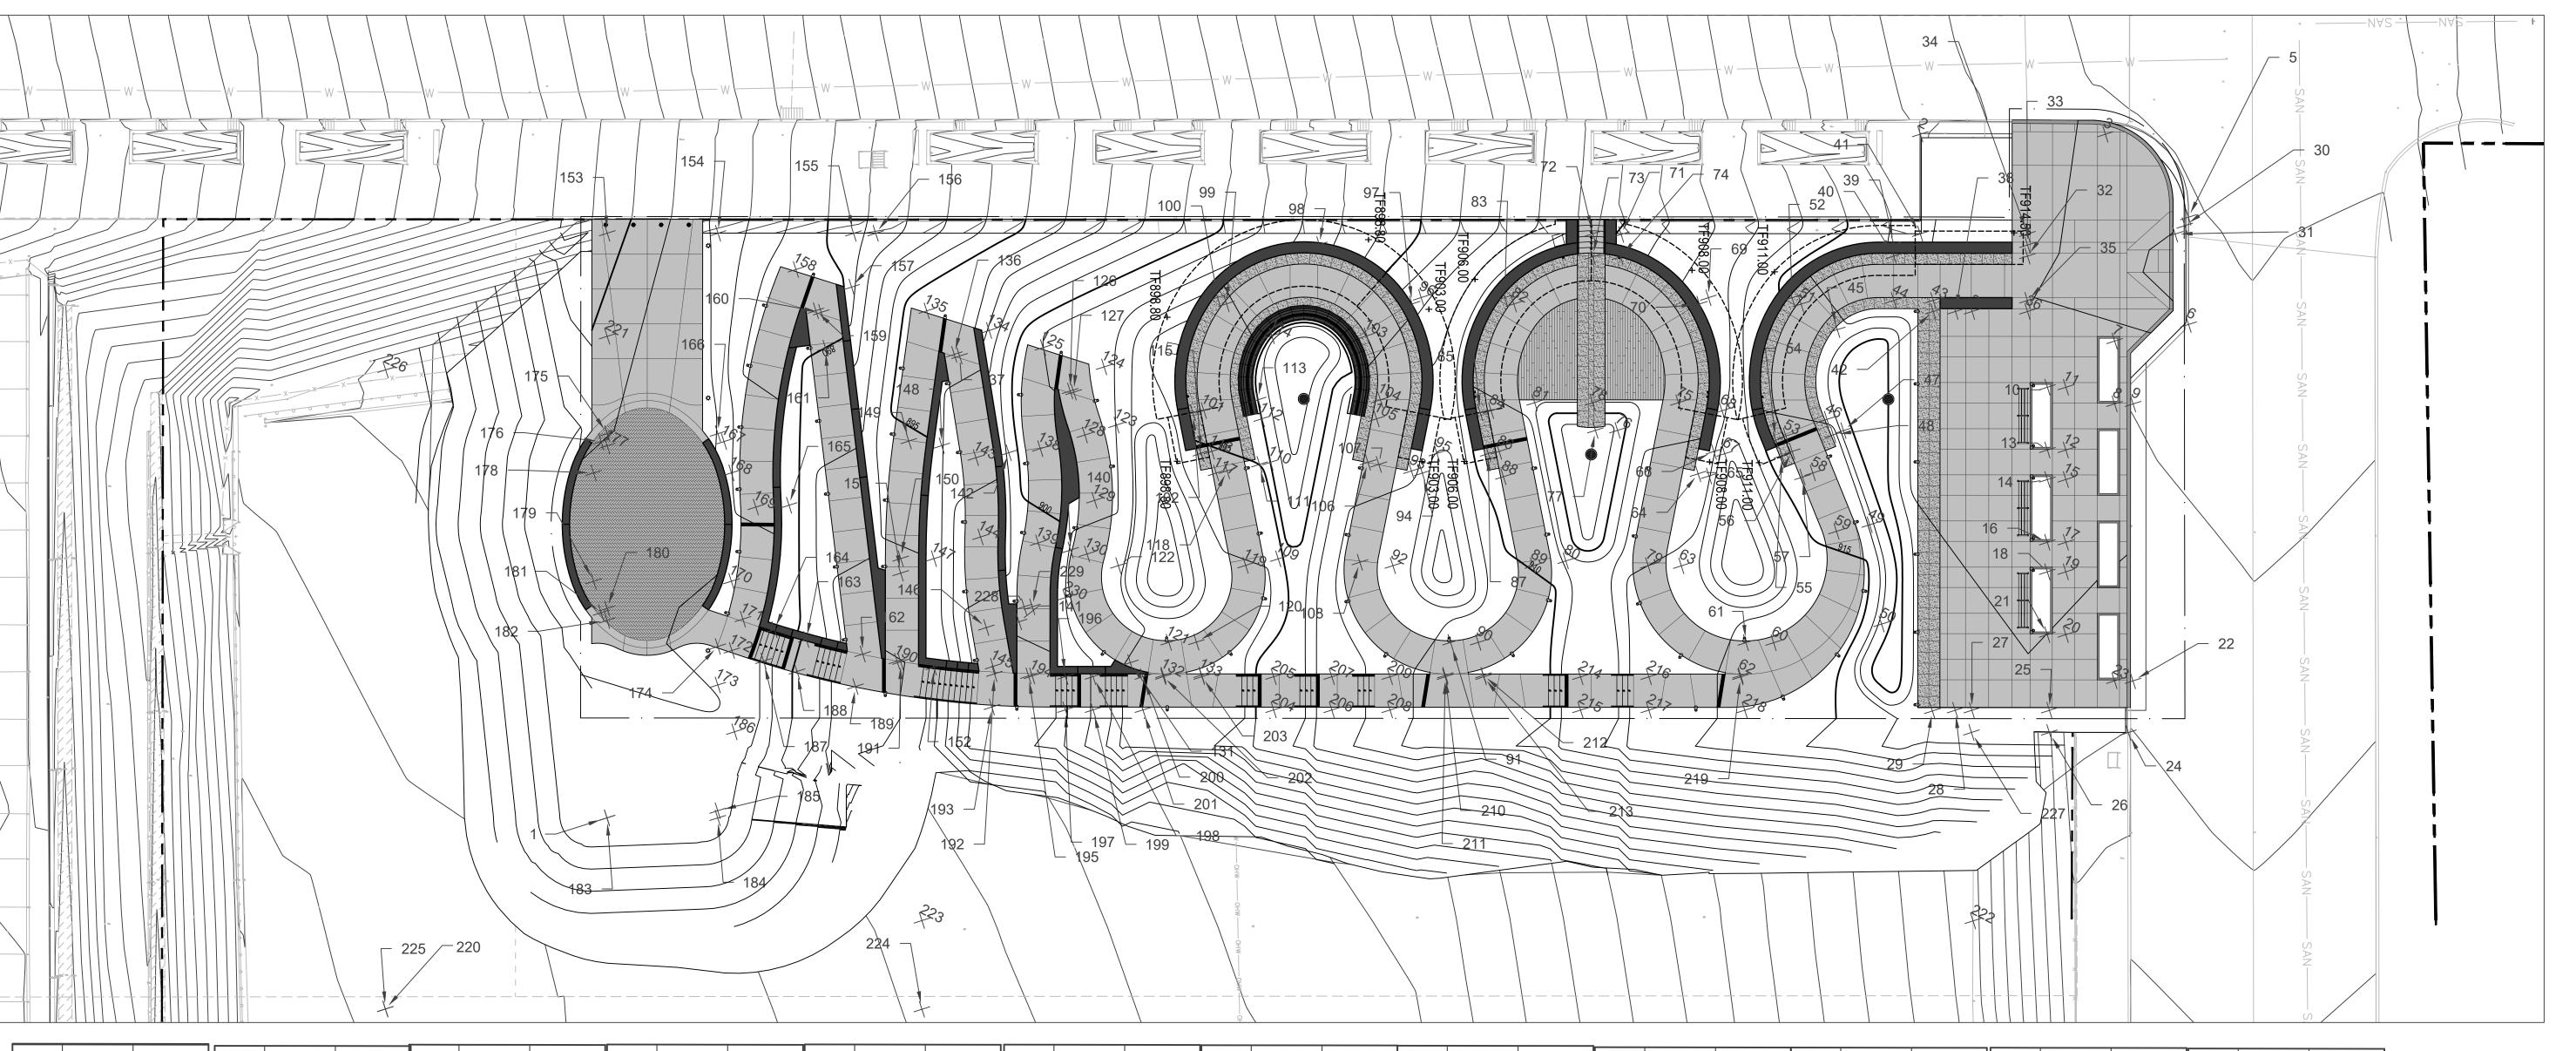0 0 0 0 0 0

SANITARY LINE
STORM LINE
WATER LINE
MAJOR CONTOUR LINE
MINOR CONTOUR LINE
GUIDERAIL

CHAINLINK FENCE

OVERHEAD WIRE — OHW — OH



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HSUUDIO ARTIST

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Project Number:
21020:1

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BN | SD

Checked by:
CS | BD

Date:
April 28, 2023

Easting

34318.9876 112136.4933

34320.6233 112158.7889

34313.3586 112144.7393

34312.1735 112145.3521

34308.4664 112138.1799

34317.0078 112133.7639

34323.1300 112157.4651

34318.2579 112143.9345

34318.3142 | 112144.0437

34318.6670 112144.4242

Northing

S c a l e : 15'

Sheet Name:

Revisions:

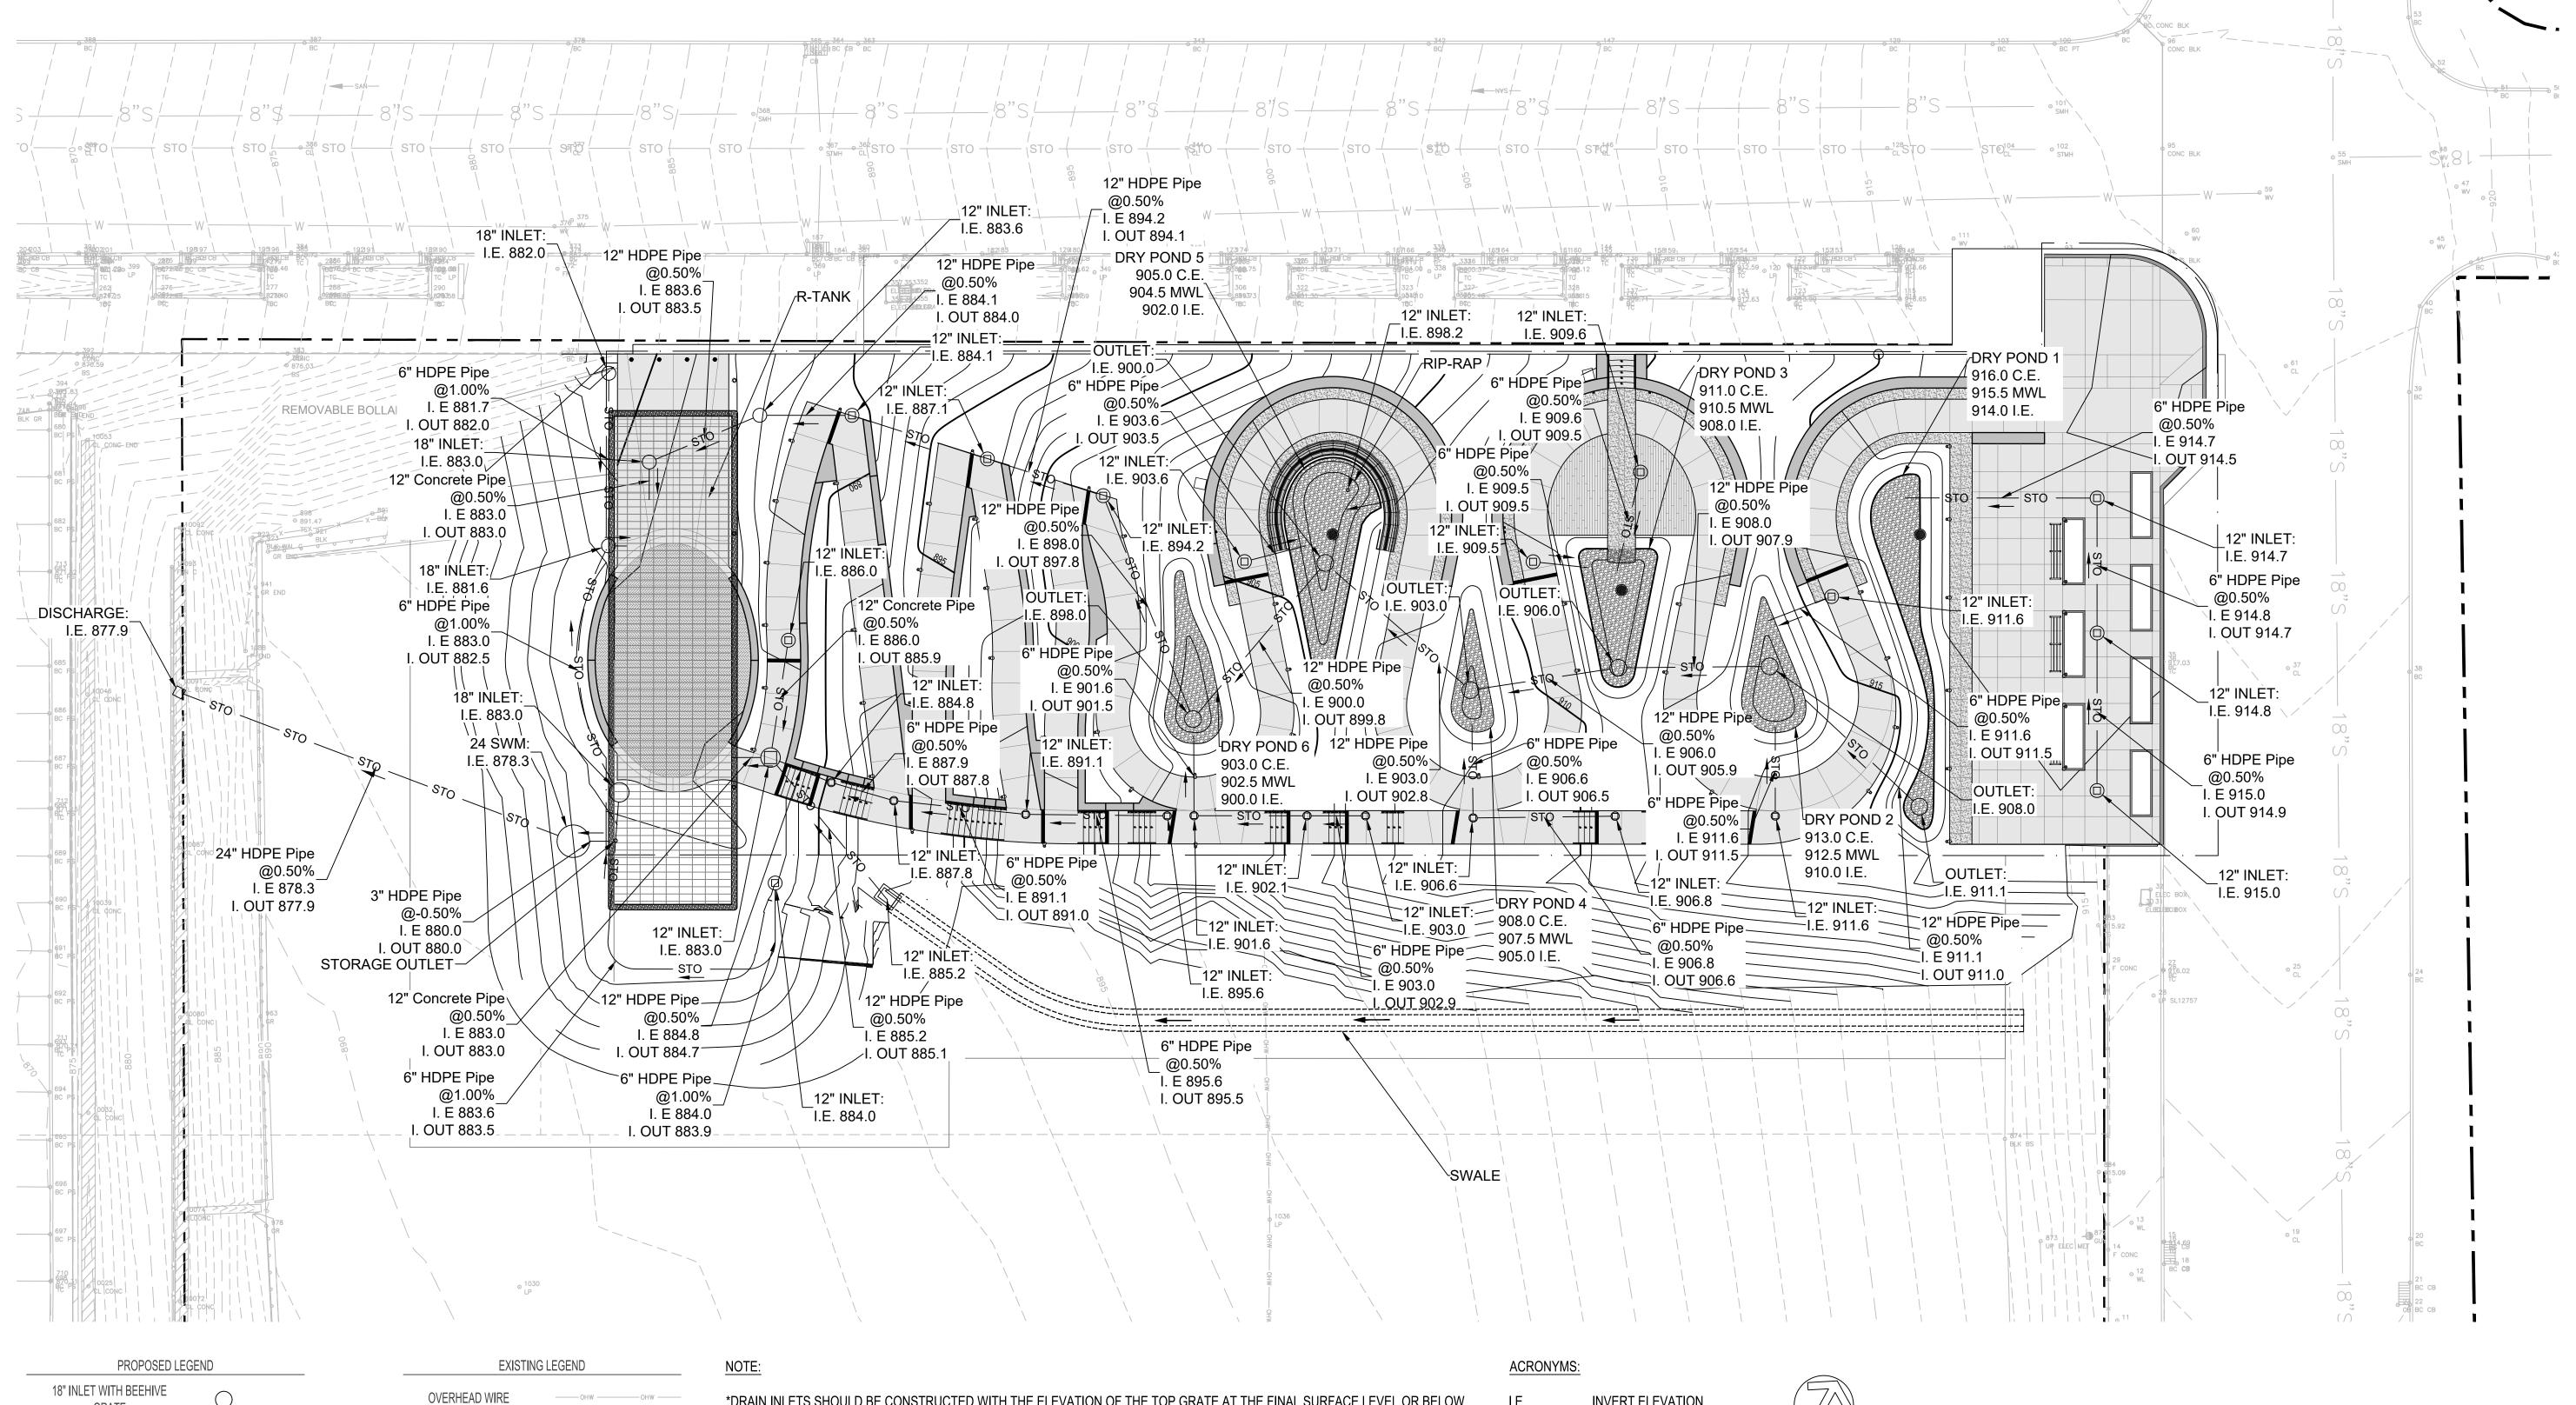
SITE LAYOUT PLAN

Submission:

100% Construction Documents

Sheet Number:

C200



INVERT ELEVATION

CREST ELEVATION

INVERT OUT ELEVATION

MAX WATER ELEVATION

I. OUT

M.W.L.

C.E.

*DRAIN INLETS SHOULD BE CONSTRUCTED WITH THE ELEVATION OF THE TOP GRATE AT THE FINAL SURFACE LEVEL OR BELOW

IT NO MORE THAN HALF AN INCH (1/2"), AND ALL SURROUNDING SURFACE MUST SLOPE THROUGH THE INLET. THERE SHOULD

NOT BE ANY IMPEDIMENT FOR ALL THE SURROUNDING AREA TO DRAIN INTO THE INLETS INTERIOR. IF IT IS NECESSARY, THE

SURROUNDING AREA SHOULD BE MODIFIED TO SLOPE TOWARD THE DRAIN INLET WITH A RECOMMENDED SLOPE OF 5% BUT

____OHW ____OHW ____

8"S - 8"S - 8"S - 10"S - 10"S - 10"S - 18"S - 18"S

— STO — STO — STO —

NO LESS THAN 2%.

SANITARY LINE

STORM LINE

WATER LINE

MAJOR CONTOUR LINE

MINOR CONTOUR LINE

GRATE

STORM LINE

— STO —



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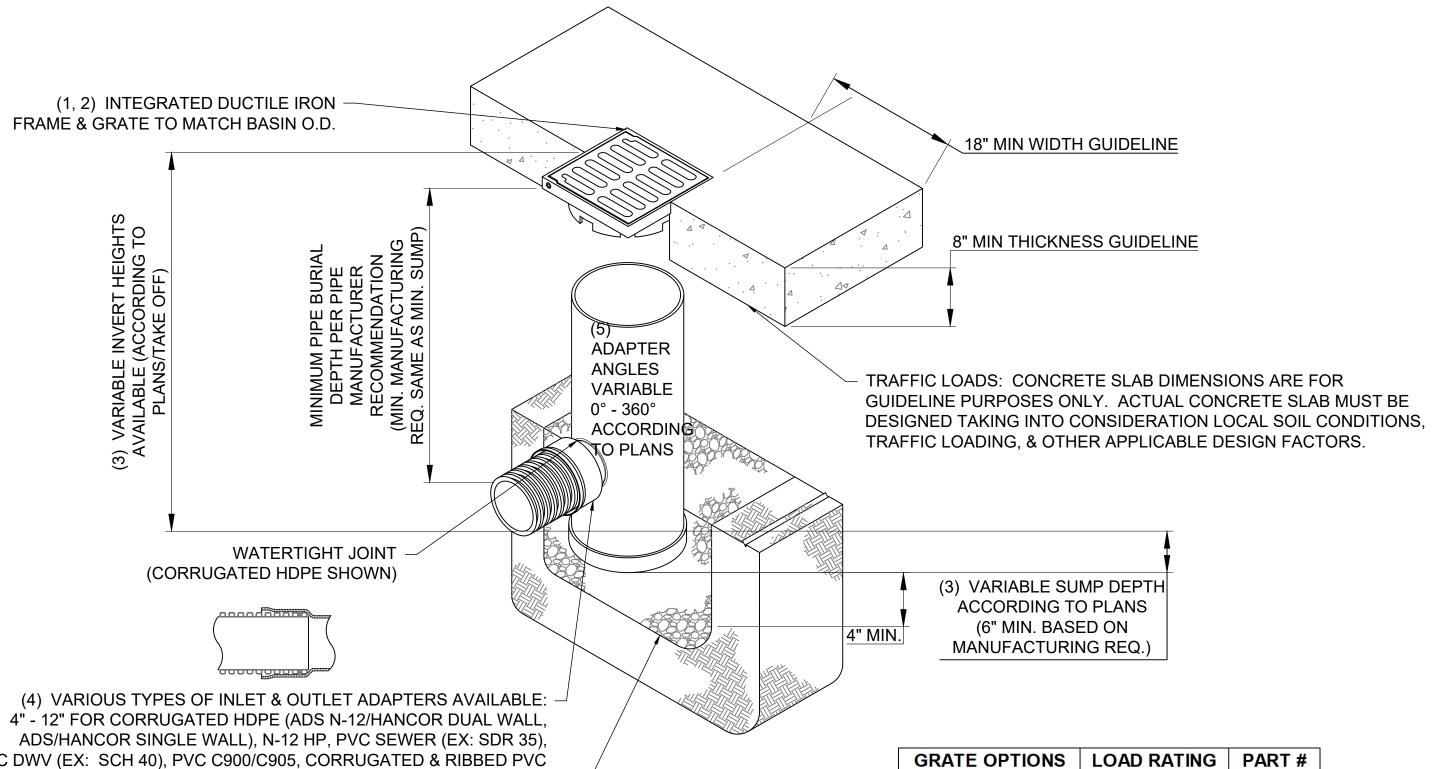
SITE GRADING & DRAINAGE PLAN

Submission:

100% Construction Documents

Sheet Number:

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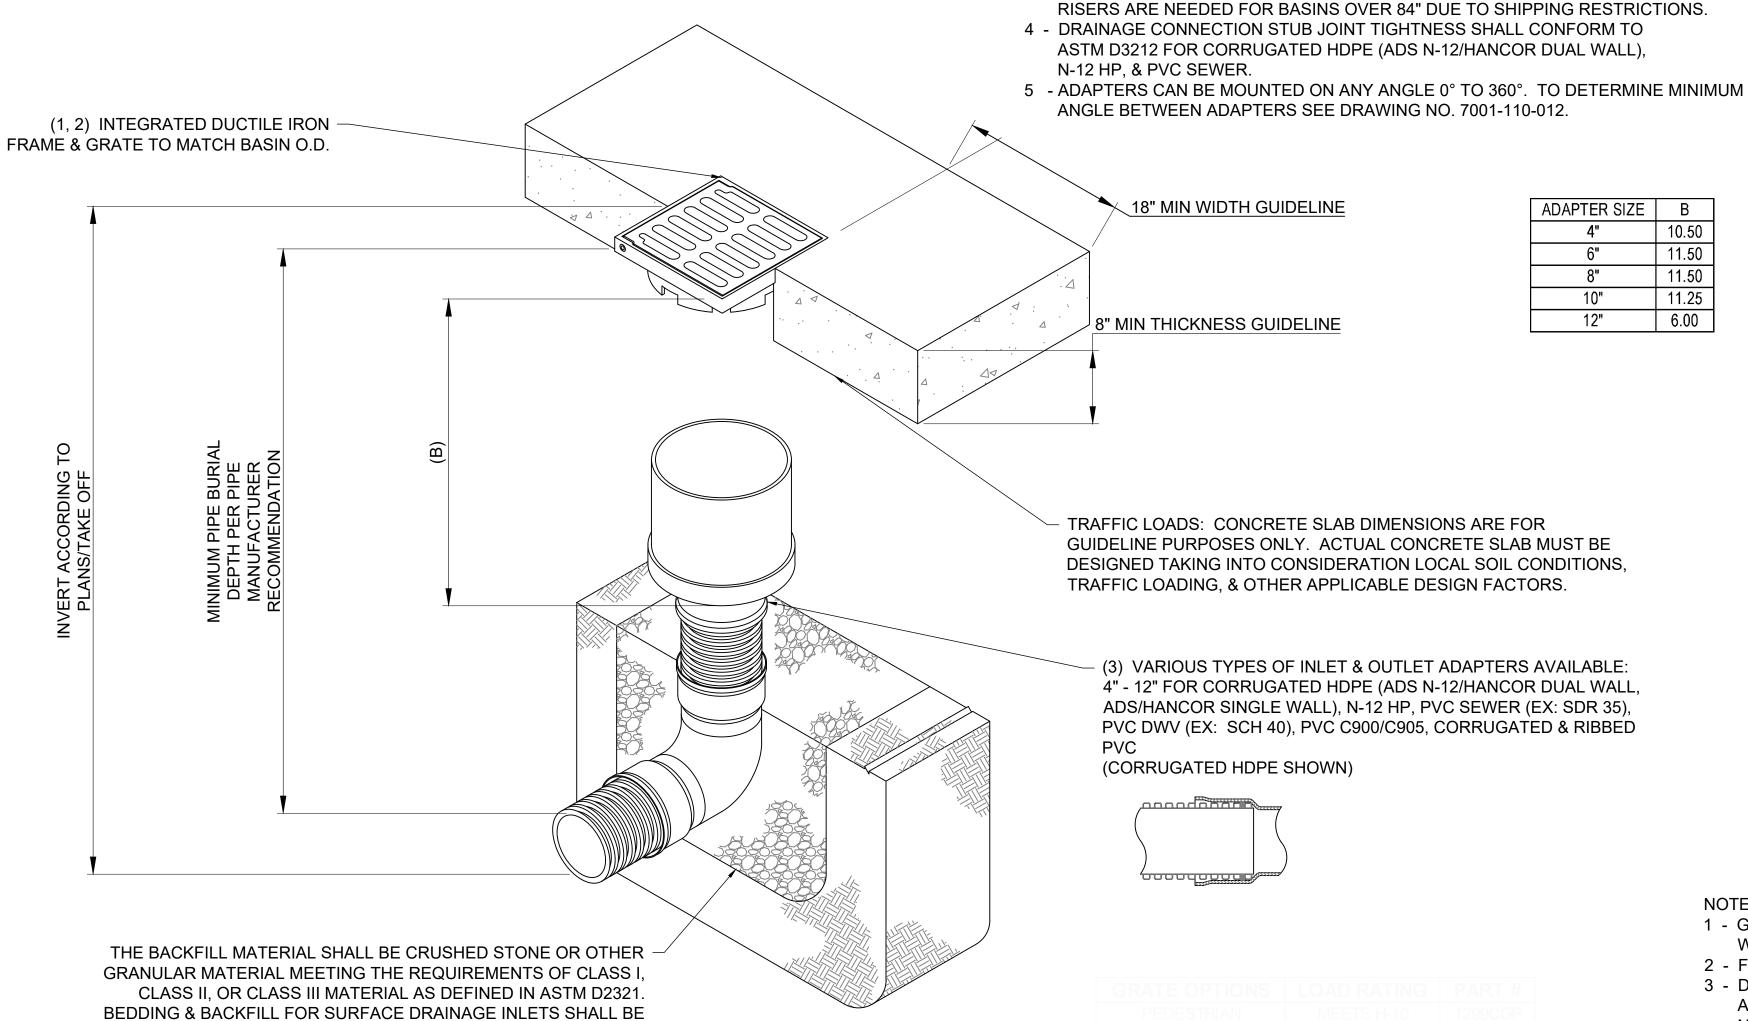
PVC DWV (EX: SCH 40), PVC C900/C905, CORRUGATED & RIBBED PVC GRATE OPTIONS PEDESTRIAN MEETS H-10 1299CGP THE BACKFILL MATERIAL SHALL BE CRUSHED STONE OR OTHER STANDARD MEETS H-20 1299CGS GRANULAR MATERIAL MEETING THE REQUIREMENTS OF CLASS I, SOLID COVER MEETS H-20 1299CGC CLASS II, OR CLASS III MATERIAL AS DEFINED IN ASTM D2321 PEDESTRIAN BRONZE N/A 1299CGPB BEDDING & BACKFILL FOR SURFACE DRAINAGE INLETS SHALL BE DOME N/A 1299CGD PLACED & COMPACTED UNIFORMLY IN ACCORDANCE WITH ASTM D2321. DROP IN GRATE LIGHT DUTY 1201DI


NYLOPLAST 18" DRAIN BASIN SCALE: NTS


PLACED & COMPACTED UNIFORMLY IN ACCORDANCE WITH ASTM D2321


NYLOPLAST 12" INLINE DRAIN

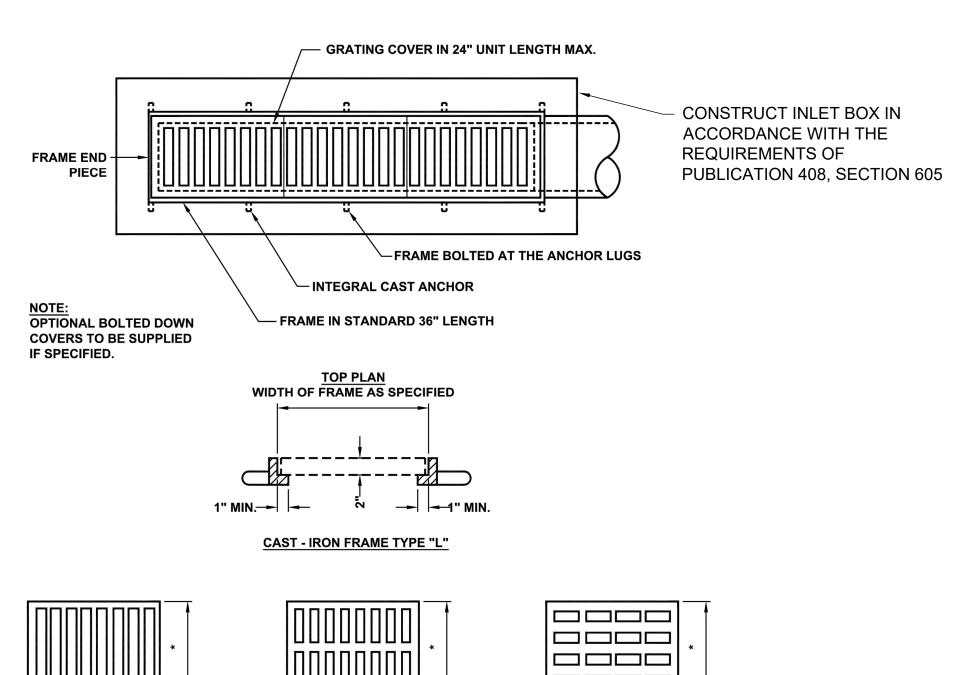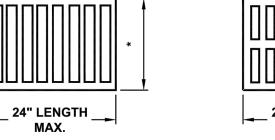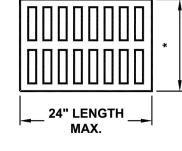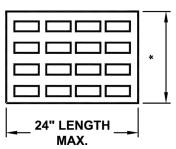
SCALE: NTS











TYPE "C" GRATING

TYPE "A" GRATING **TYPE "B" GRATING**

<u>DUCTILE IRON</u> <u>OPEN GRATE TRENCH COVERS</u>



1 - GRATES/SOLID COVER SHALL BE DUCTILE IRON PER ASTM A536 GRADE 70-50-05,

- DRAIN BASIN TO BE CUSTOM MANUFACTURED ACCORDING TO PLAN DETAILS.

WITH THE EXCEPTION OF THE BRONZE GRATE.

2 - FRAMES SHALL BE DUCTILE IRON PER ASTM A536 GRADE 70-50-05

- 1 GRATES/SOLID COVER SHALL BE DUCTILE IRON PER ASTM A536 GRADE 70-50-05,
- WITH THE EXCEPTION OF THE BRONZE GRATE.
- 2 FRAMES SHALL BE DUCTILE IRON PER ASTM A536 GRADE 70-50-05.
- 3 DRAINAGE CONNECTION STUB JOINT TIGHTNESS SHALL CONFORM TO ASTM D3212 FOR CORRUGATED HDPE (ADS N-12/HANCOR DUAL WALL), N-12 HP, & PVC SEWER.
- 4 DIMENSIONS ARE FOR REFERENCE ONLY. ACTUAL DIMENSIONS MAY VARY.
- 5 DIMENSIONS ARE IN INCHES



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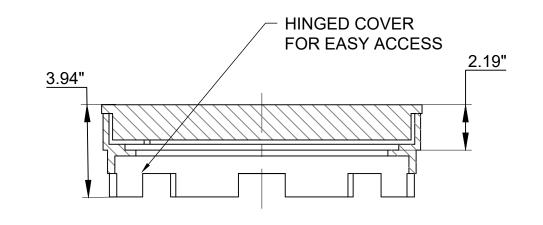
SITE GRADING DETAIL


Submission:


100% Construction Documents

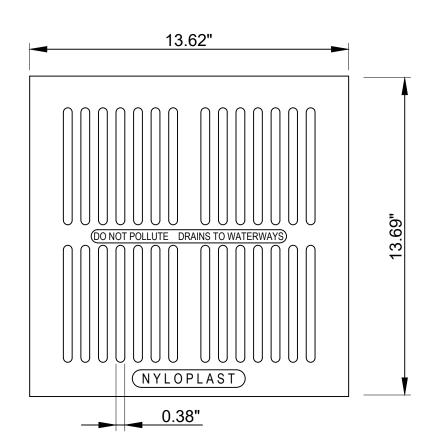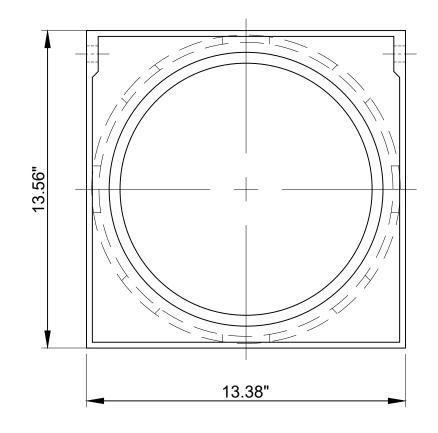Sheet Number:

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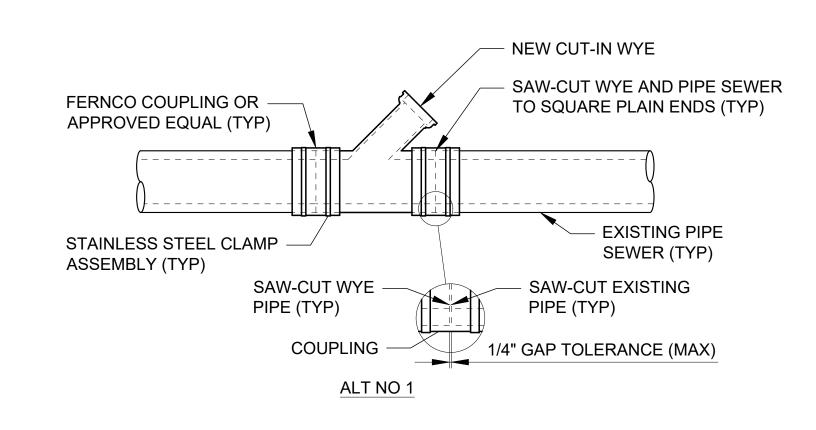
NYLOPLAST 12 IN BRONZE GRATE ASSEMBLY


SCALE: NTS

Ø14.95"

OUCTILE IRON

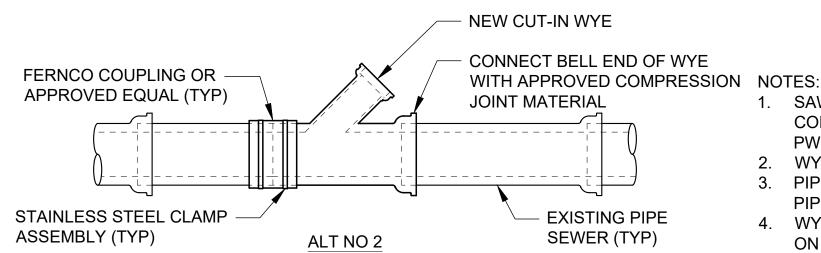Ø 11.64"





ON NOTES:

1. SAW-CUT EXISTING PIPE SEWER, NO BREAK-IN OR HAMMER
CONNECTIONS PERMITTED. JOINTS MUST BE INSPECTED BY
PWSA BEFORE AND AFTER FLEXIBLE COUPLINGS ARE INSTALLED.

WYE MATERIAL WILL MATCH SEWER MAIN MATERIAL.
 PIPE MAIN ID OF NEW WYE SECTION WILL MATCH ID OF EXISTING

PIPE SEWER MAIN.

4. WYE LOCATION WILL BE LOCATED AT 2 O'CLOCK OR 10 O'CLOCK ON BARREL OF PIPE SEWER.

ST-7
CUT-IN WYE PIPE TRANSITION
SCALE: NTS



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> Date: **April 28, 2023**

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Scale:
0' 10' 2

Sheet Name:

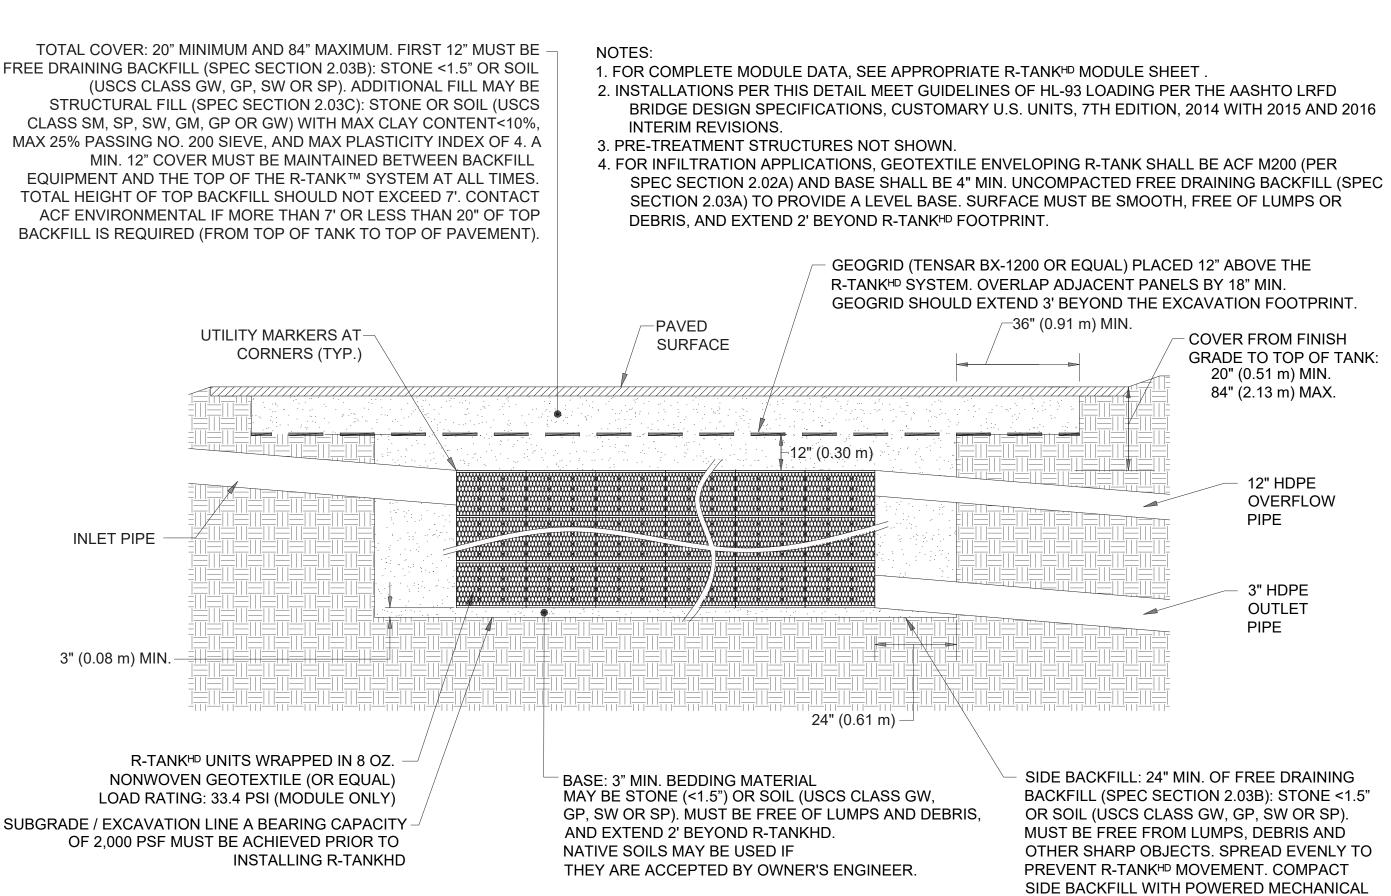
SITE GRADING DETAIL

Submission:

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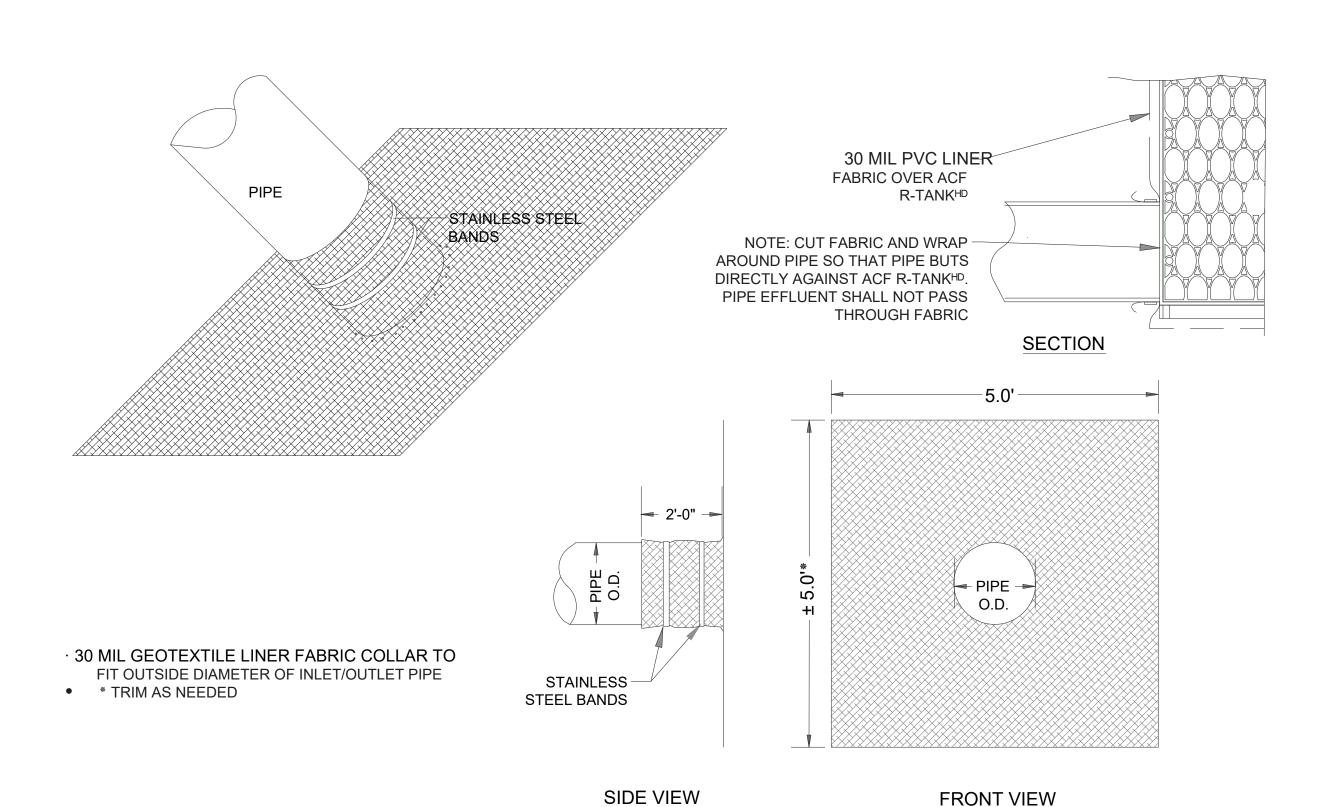
C302




COMPACTOR IN 12" LIFTS.

HEAVY DUTY MODULE ACF-R TANK

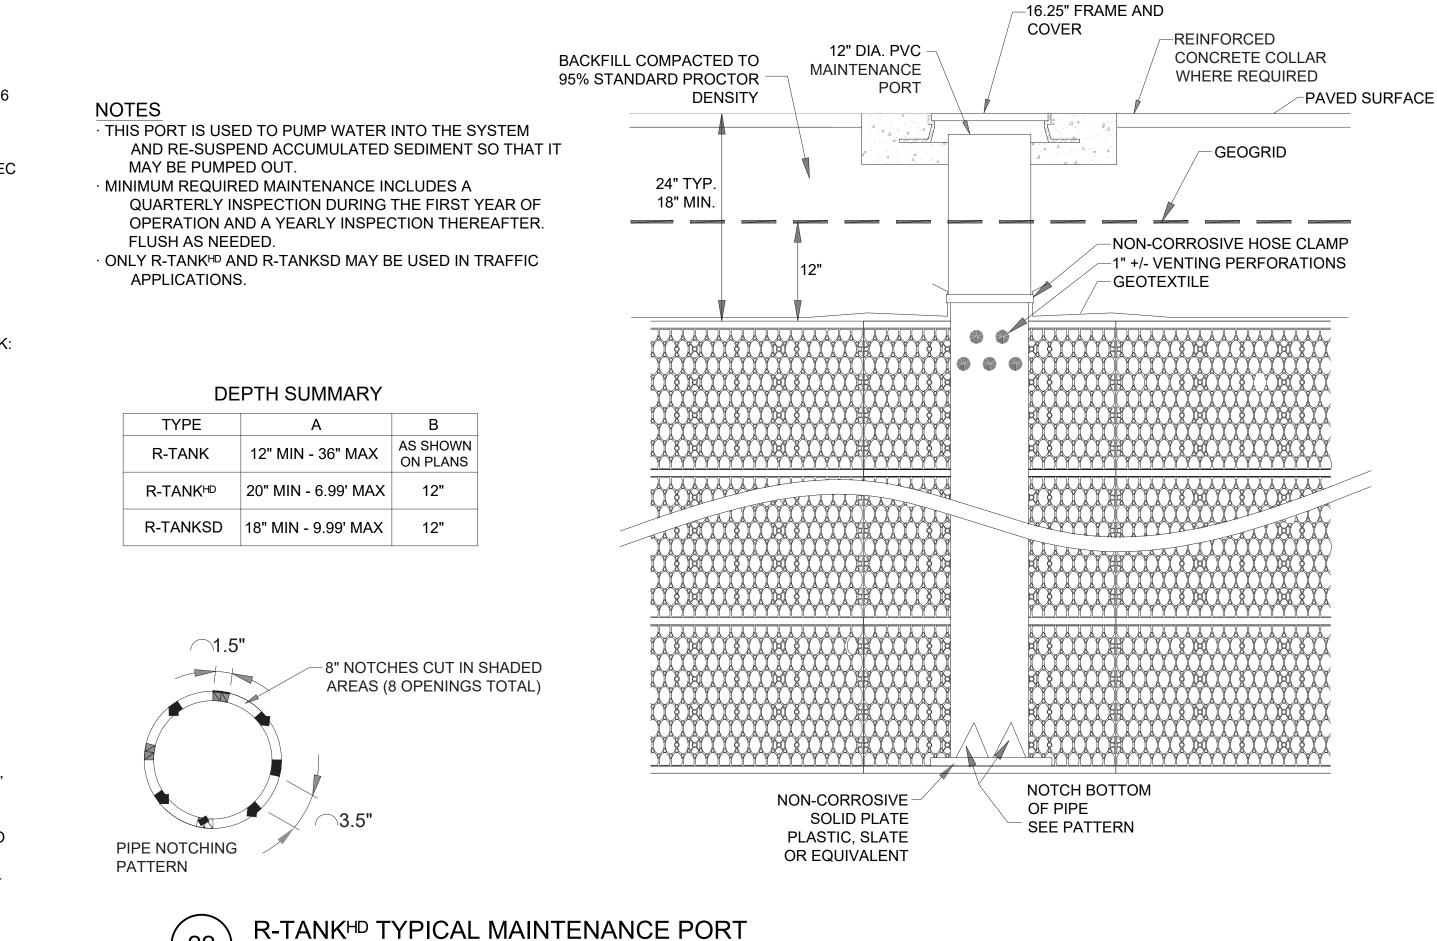
SCALE: NTS







SCALE: NTS

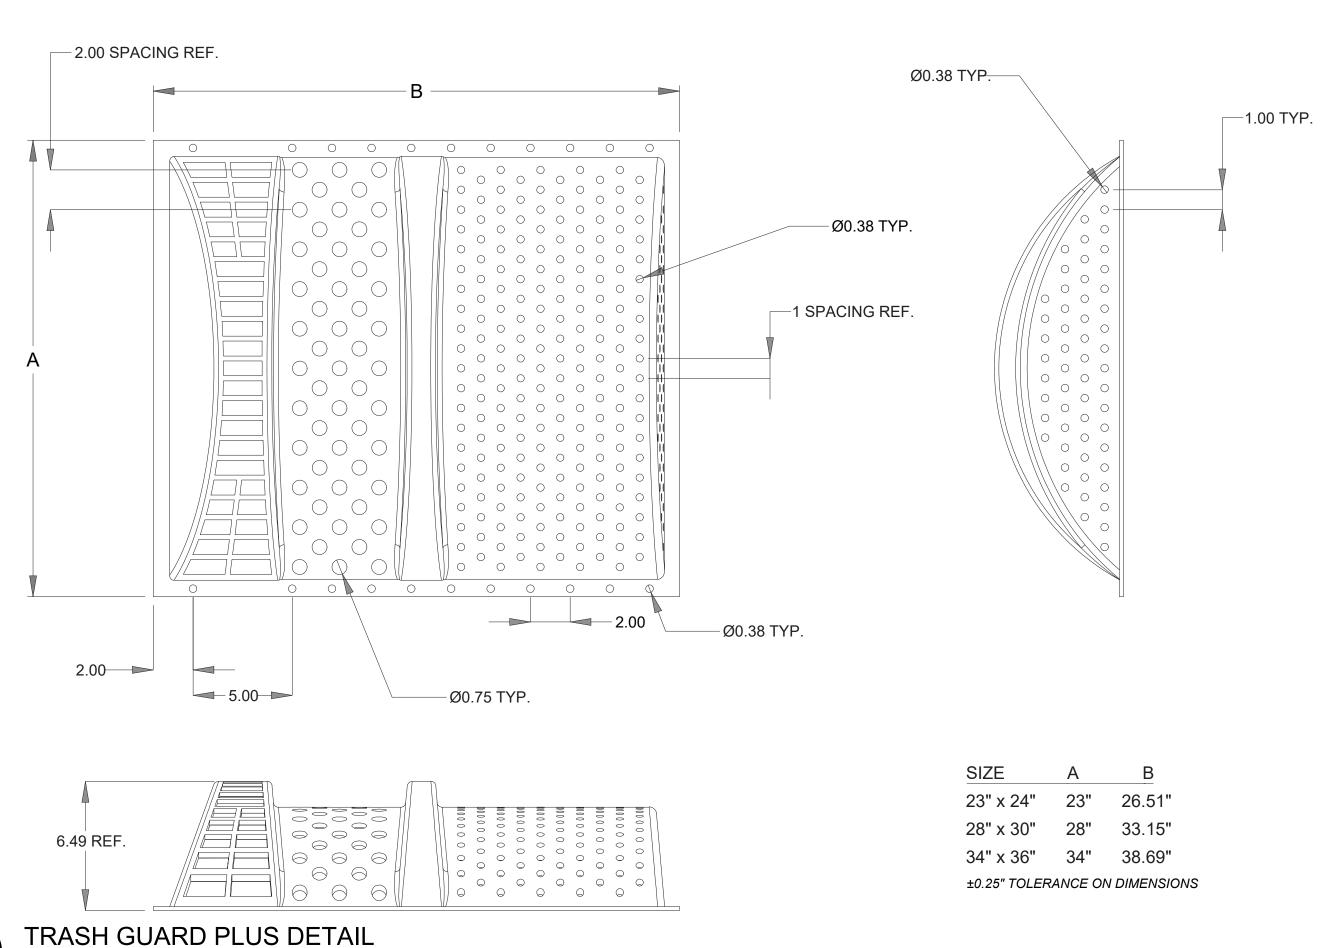



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Revisions:

S c a l e :

0' 10' 20'

SCALE: 1"=10'-0"

Sheet Name:


SITE GRADING DETAIL

Submission:

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Sheet Number:

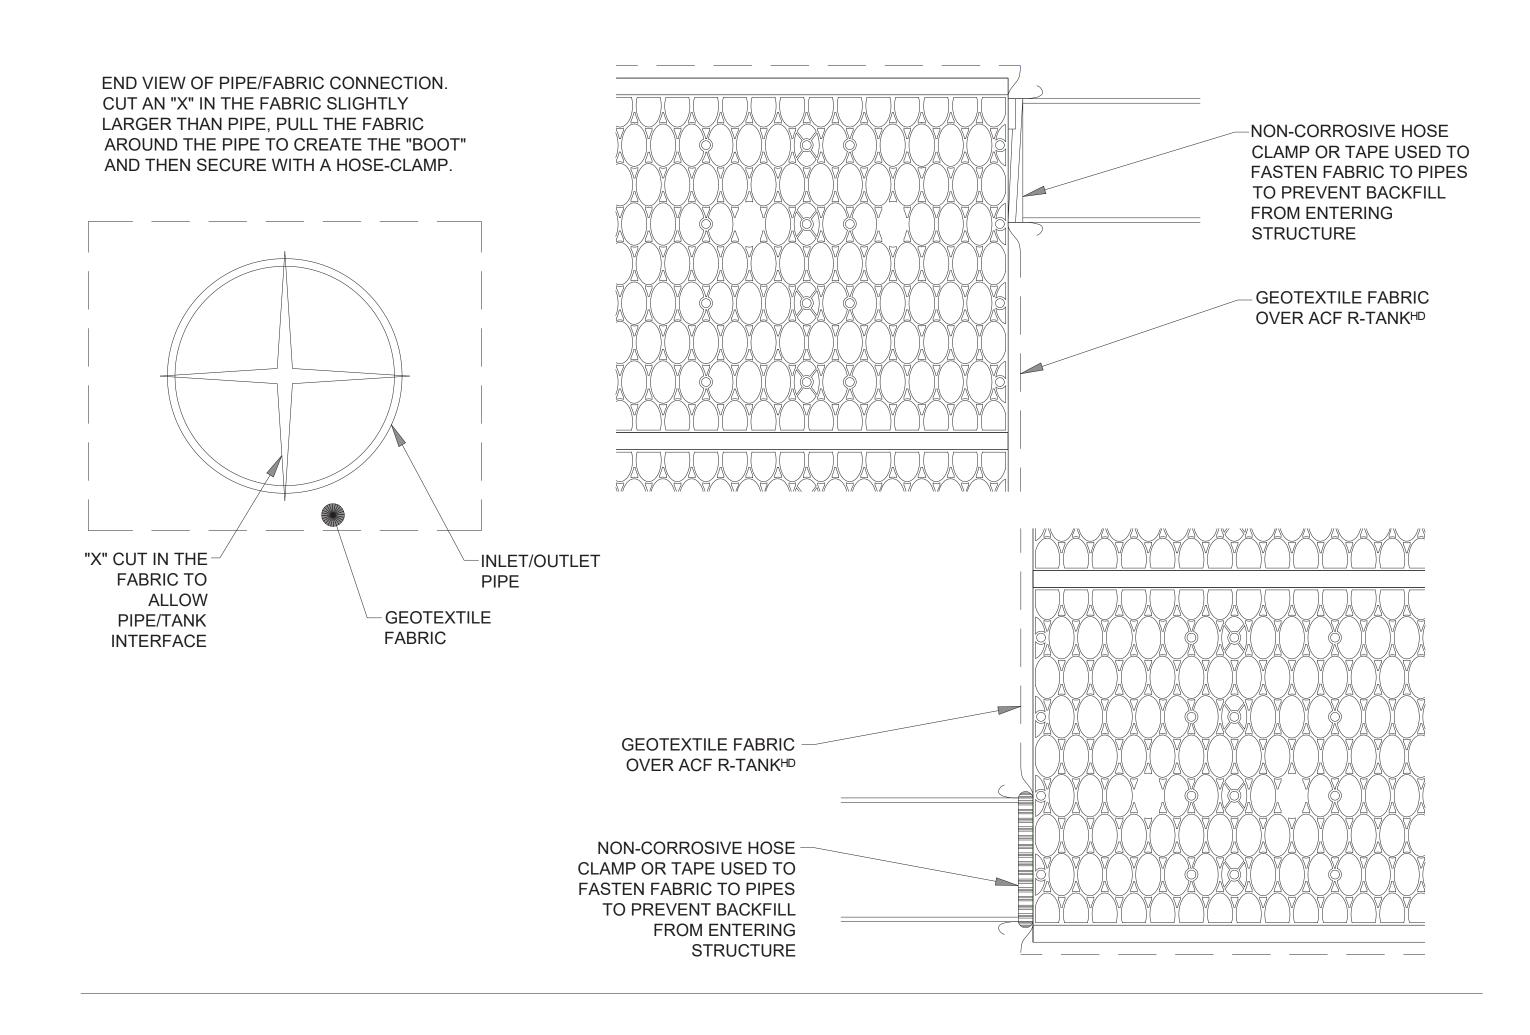C303



R-TANKHD TYPICAL TANK INLET/OUTLET DETAIL

HEAVY DUTY, WATER TIGHT CAPS
AS PER ACHD

FINISHED SURFACE

CLEAN OUT
AS PER ACHD

-45° BEND

WYE

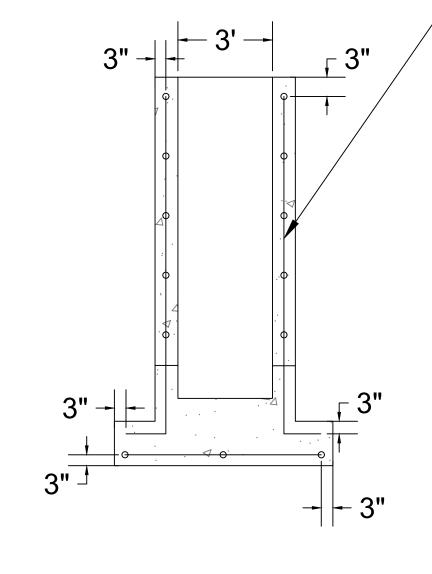
CLEANOUT

SCALE: NTS

TOP MESH 40"X40"X2" OUTLET STRUCTURE TRASH GUARD SEE DETAIL # 20 ON SHEET C303 **INLET PIPE** FIRST 1" OUTLET ORIFICE 6" FROM THE GROUND IMPERVIOUS LINER SECOND 1" OUTLET 18" BIORETENTION SOIL ORIFICE AT GROUND LEVEL (SEE DRAWING L601) DRAIN PIPE CAP I.E. **OUTLET PIPE** 2" PERFORATED UNDERDRAIN PIPE WITH SOCK └ 1" INLET PIPE FROM UPSTREAM

DRY POND

DRY POND OUTLET STRUCTURES



CONSTRUCT INLET BOX IN ACCORDANCE WITH THE REQUIREMENTS OF PUBLICATION 408, SECTION 605

DRY POND							
NAME	OUTLET STRUCTURE HEIGHT	# OF UNDERDRAIN LINES	OUTLET PIPE INVERT				
DRY POND 01	6	2	911.14				
DRY POND 02	5	1	908.00				
DRY POND 03	6	2	906.00				
DRY POND 04	6	1	903.00				
DRY POND 05	5	2	900.00				
DRY POND 06	5	1	898.00				

28 STRUCTURE DETAILS
SCALE: NTS



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S c a l e :

0' 10' 20'

SCALE: 1" = 10'-0"

Sheet Name:

SITE GRADING DETAIL

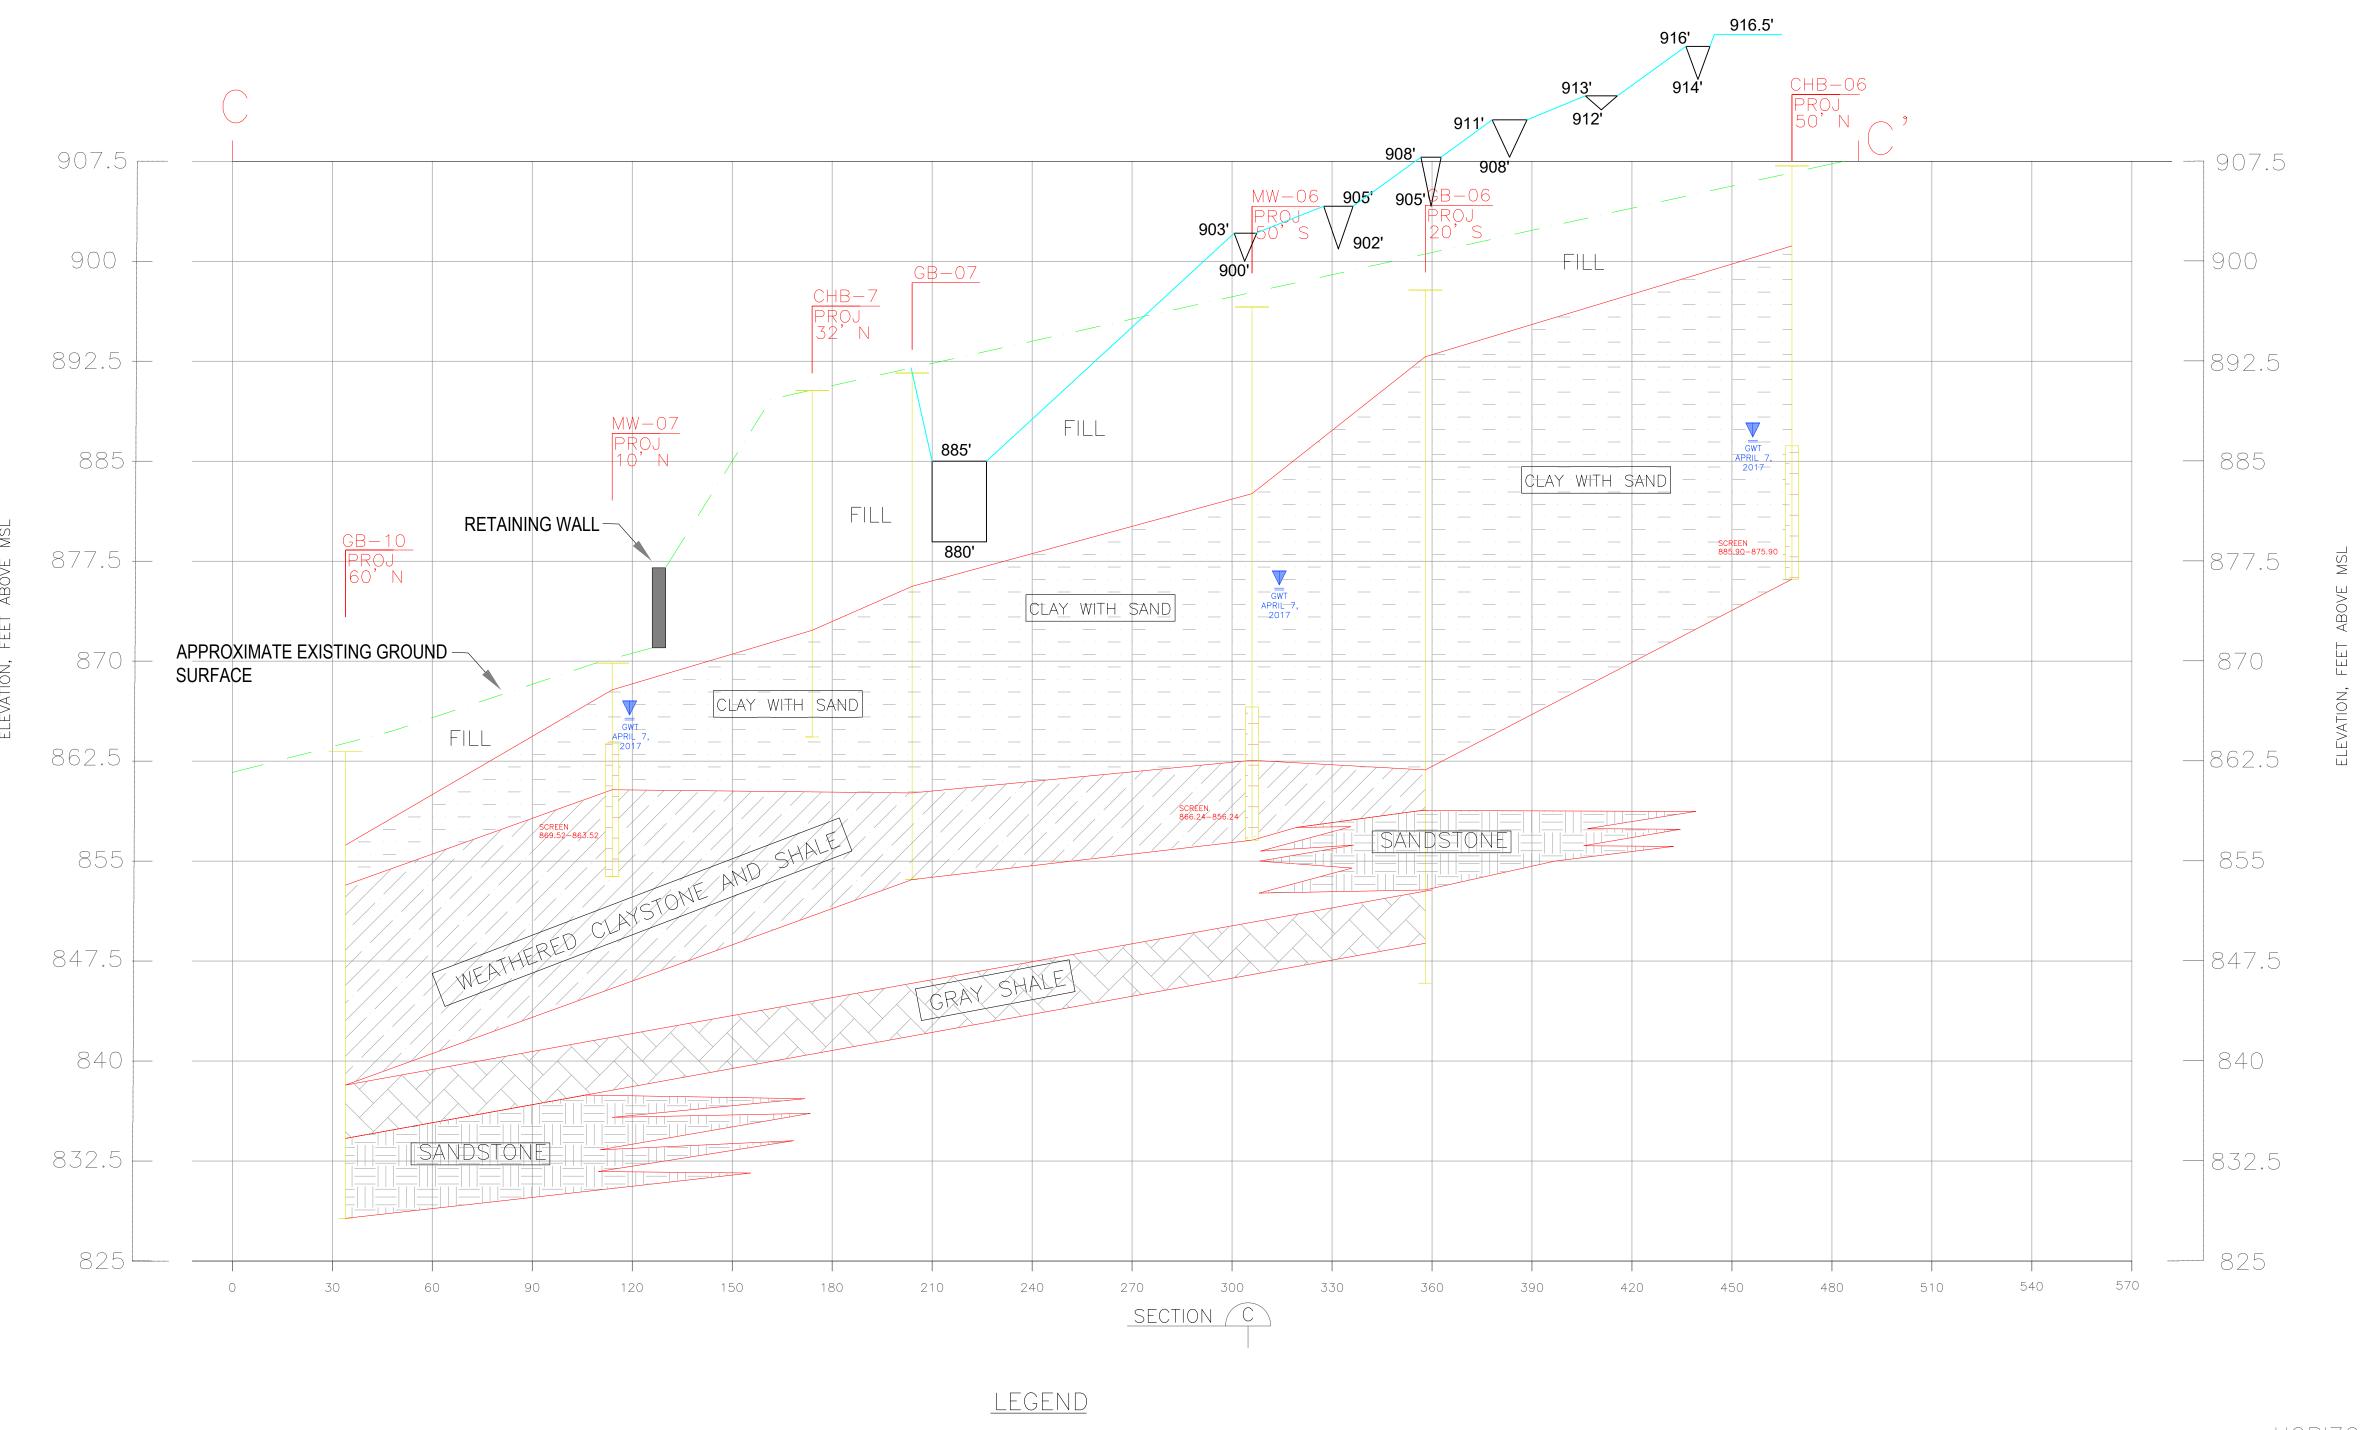
Submission:

100% Construction Documents

Sheet Number:

C304

GEOLOGICAL CROSS-SECTION C-C' LOOKING NORTHEAST



SAMPLE ID FILL (CLAY/GRAVEL/DEMO MATERIAL BOUNDARY SHALE DEBRIS) SOIL BORING / APPROXIMATE EXISTING MONITORING WELL CLAY WITH SAND SANDSTONE GROUND SURFACE POND GROUNDWATER LEVEL WEATHERED CLAYSTONE AND SHALE APRIL 7, 2017 BOTTOM OF BORING WATER SITE GRADING & RESERVOIR DRAINAGE PROFILE

HORIZONTAL SCALE — FEET VERTICAL SCALE — FEET VERTICAL EXAGGERATION X4

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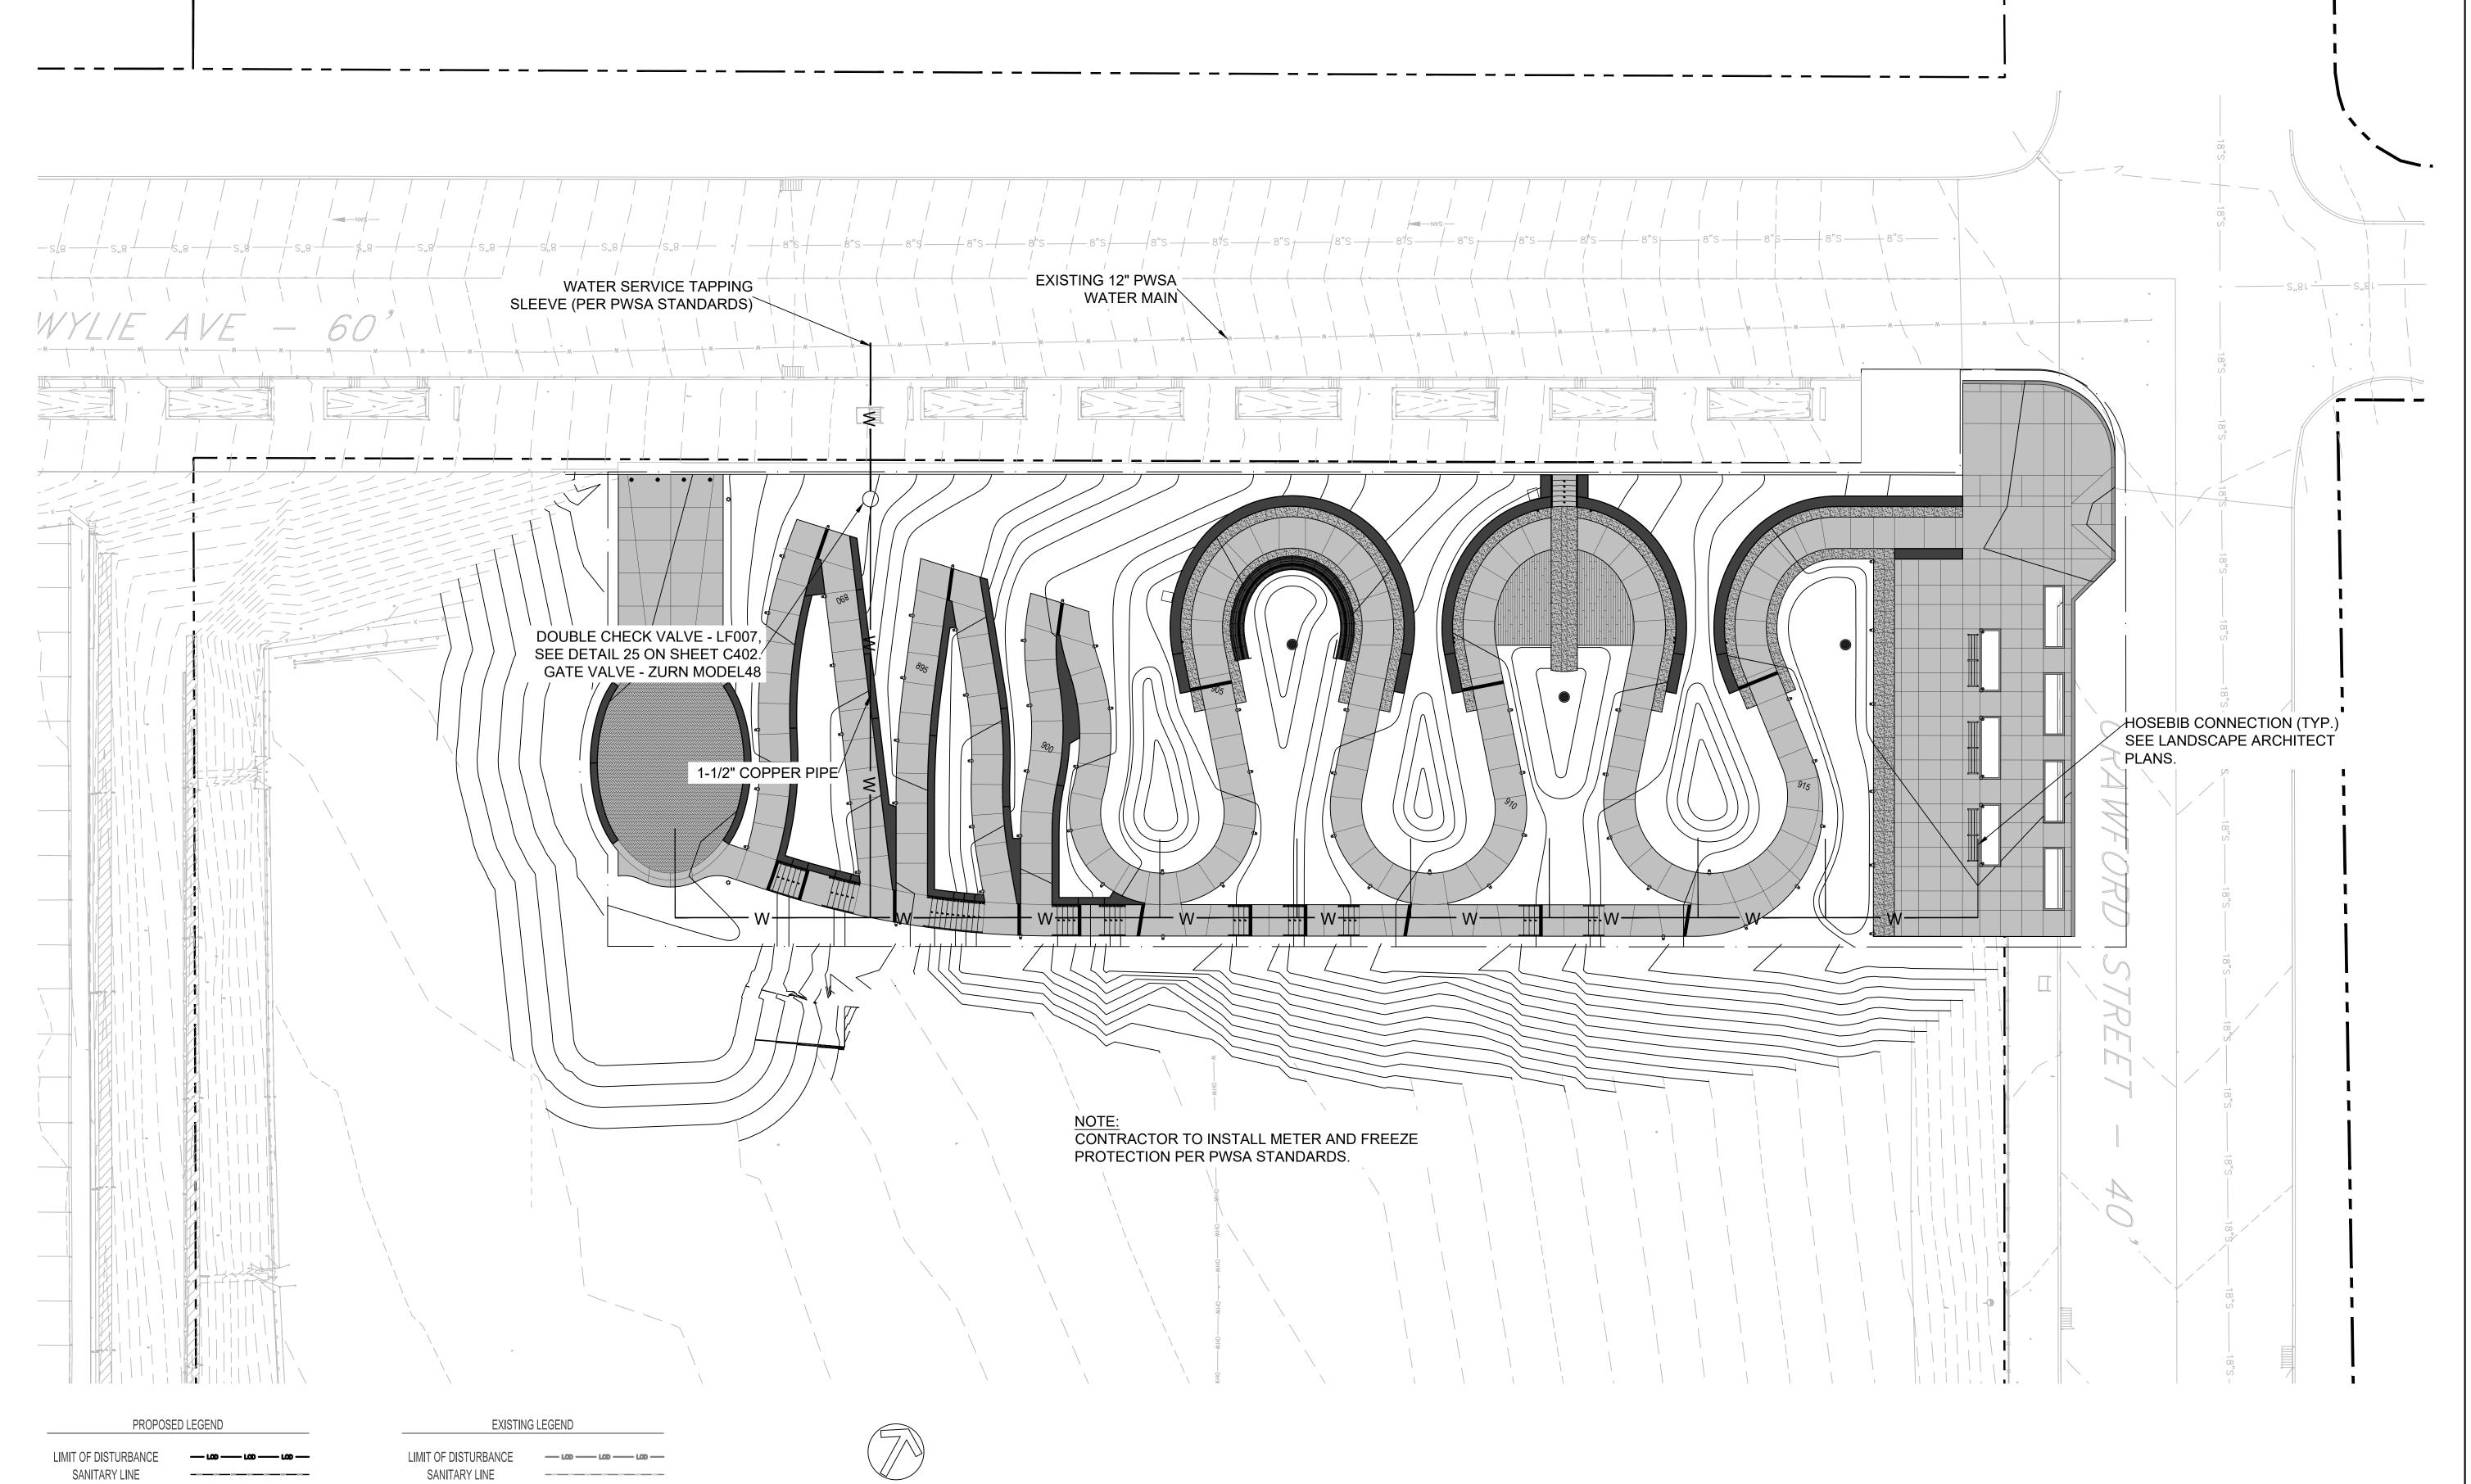
SITE GRADING & DRAINAGE PROFILE

Submission:

100% Construction Documents

Sheet Number:

SITE GRADING & DRAINAGE PROFILE SCALE: NTS



STORM LINE

WATER LINE

MAJOR CONTOUR

MINOR CONTOUR LINE

UNDERGROUND ELECTRIC

STORM LINE

WATER LINE

MAJOR CONTOUR

MINOR CONTOUR LINE

PROPERTY LINE

_ _ _ _ _ _



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S c a l e :

0' 15'

SCALE: 1" = 15'-0"

Sheet Name:

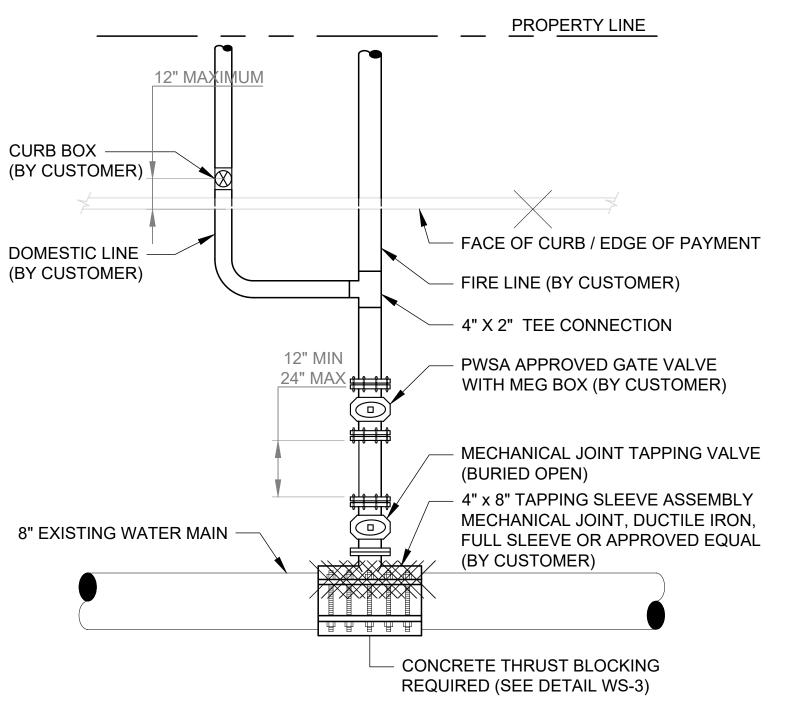
WATER SUPPLY PLAN

Submission:

100% Construction Documents

Sheet Number:

C400



NOTES

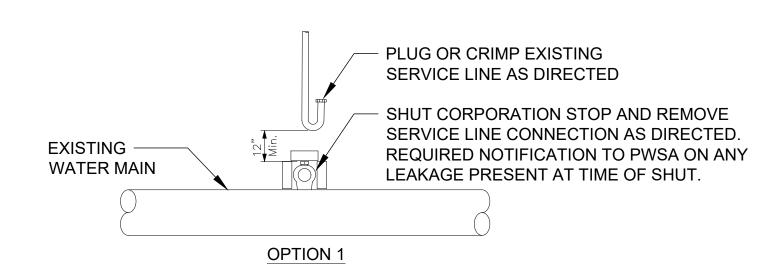
- 1. PWSA PERFORMS ACTUAL TAP TO MAIN ONLY AND MAINTAINS METER; ALL
- OTHER WORK BY CUSTOMER.

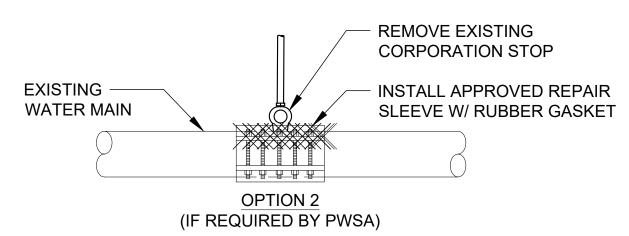
 2. TAPPING TEE SHALL BE FULL SLEEVE; SADDLE STYLE NOT PERMITTED.
- 3. CUSTOMER IS REQUIRED TO ENTER VALUES FOR ALL DIMENSION FIELDS ABOVE.
- 4. CUT-IN TEE CONNECTION ALSO ACCEPTABLE AND IS REQUIRED FOR SIZE ON SIZE (e.g. 8" TAP ON 8" MAIN).
- 5. CENTERING OF TAPPING TEE CONNECTION SHALL BE 18" MINIMUM FROM EXISTING WATER MAIN BELL/HUB OR OTHER EXISTING SERVICE CONNECTIONS.
- 6. CUSTOMER IS RESPONSIBLE FOR, MAINTANS, AND OWNS, INCLUDING THE
- TAPPING TEE ASSEMBLY, FROM THE MAIN TO THE BUILDING.
- ADDITIONAL BACKFLOW PREVENTION (RPZ TYPE) REQUIRED INTERNALLY ON COMMERCIAL OR HIGH HAZARD PROPERTIES.
- 8. ALL VALVES MUST BE "RIGHT TURN TO OPEN".
- 9. PRIVATE SERVICE LINE MATERIAL AND EQUIPMENT SHALL CONFORM TO ALLEGHENY COUNTY PLUMBING CODE, ARTICLE XV.

COUNTY FLOWDING C

WS-C1 SINGLE SERVICE CONNECTION (4" AND LARGER)

(21) SCALE:NTS






NOTES

- OPTION 2 REQUIRES MAIN LINE SHUT; THIS WOULD BE ADDITIONAL PWSA CHARGE.
- 2. TERMINATION OPTION FROM ABOVE AS DIRECTED BY

WS-STS

TYPICAL WATER TAP SERVICE TERMINATION FOR 2" AND SMALLER CONNECTION

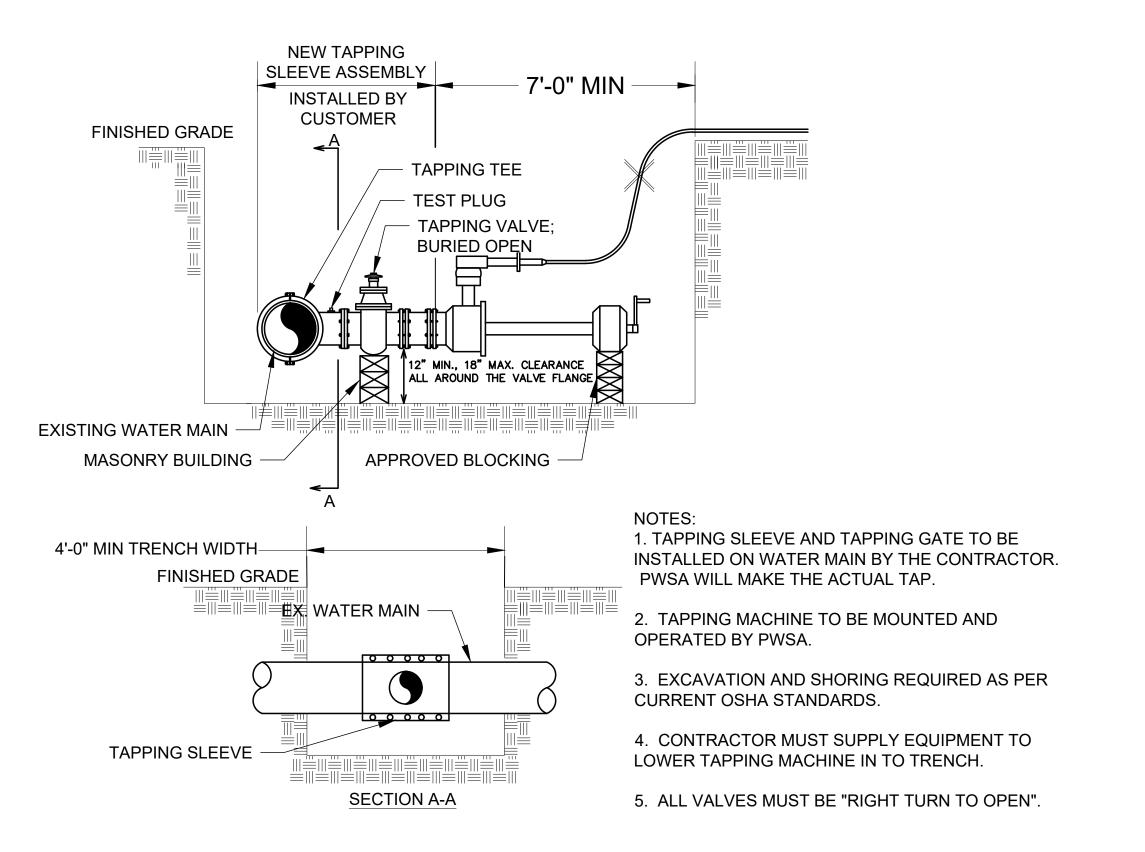SCALE: NTS




WS-B

22

TRENCH REQUIREMENTS FOR 4" THROUGH 12" LIVE WATER TAP

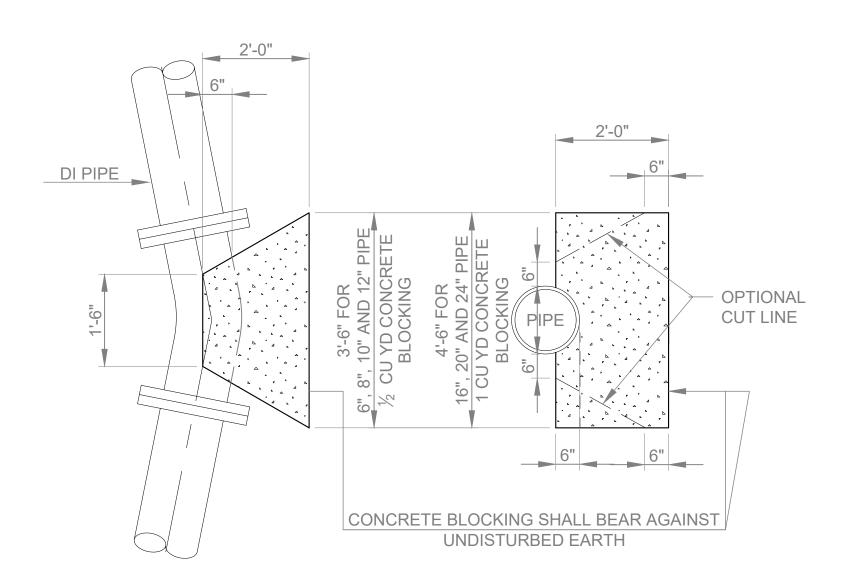SCALE: NTS



NOTES:

- CONCRETE THRUST BLOCKING SHALL BE PROVIDED AT ALL TEES, BENDS, CAPS AND PLUGS. IN ADDITION, ALL PIPE BENDS SHALL BE HARNESSED WITH MECHANICAL JOINT RETAINER GLANDS, USEING EITHER SET SCREW OR LUG TYPE RETAINING SYSTEM, AS DIRECTED.
- CONCRETE THRUST BLOCKS SHALL BE MINIMUM 4000PSI CEMENT CONCRETE.
 SEE DETAIL WS-VB AND WS-VBL FOR VERTICAL BENDS REQUIREMENTS.

WS-3



CONCRETE BLOCKING FOR PRESSURE PIPE

SCALE: NTS



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ARTIS 1

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0' 10' 20'

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WATER SUPPLY DETAIL


Submission:

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Sheet Number:

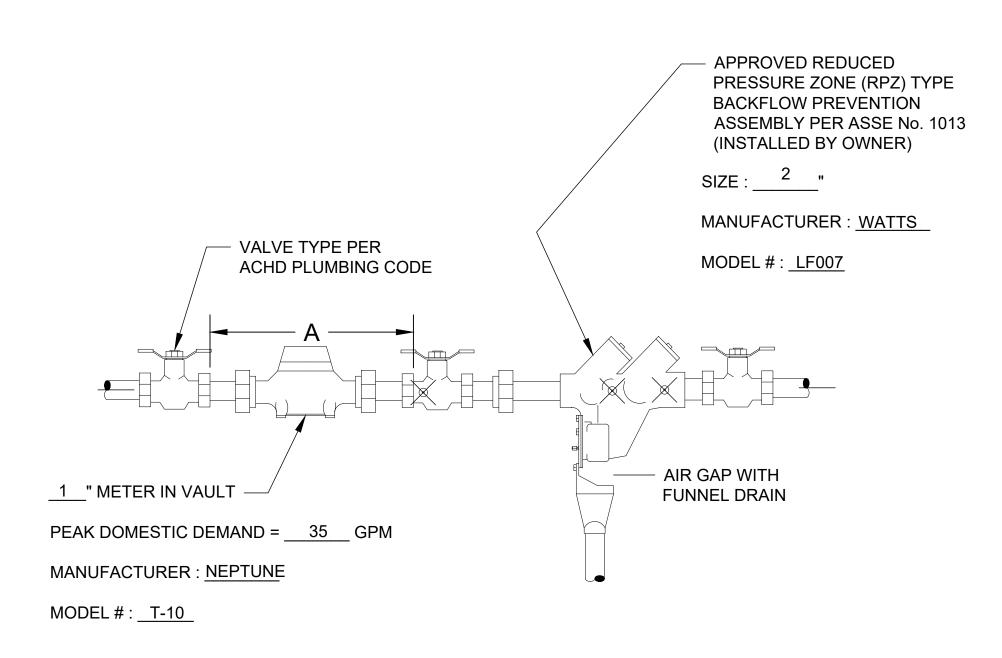C401

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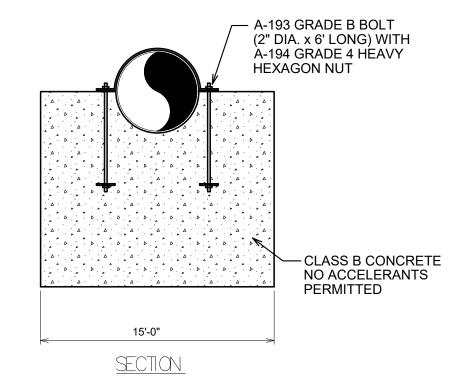
DOMESTIC SERVICE INTERNAL METER SETTING


COMMERCIAL AND MULTI-FAMILY

- 1. METER TO BE INSTALLED IN A WARM, NON-FREESING, ACCESSIBLE AREA WITHIN DWELLING, A MINIMUM OF 2'-0" FROM FLOOR AND A MAXIMUM OF 3'-0" FROM POINT OF ENTRY AND/OR FROM INSIDE WALL.
- 2. SEE ACHD PLUMBING CODE FOR ADDITIONAL PIPING AND PRESSURE REGULATOR REQUIREMENTS.
- 3. PROPER METER ACCESS REQUIRED. METER SETTING CAN NOT BE IN A RESTRICTED AREA (EG UNDER STEPS, BEHIND FURNACE OR HOT WATER TANK), OR IN OTHER OBSTRUCTED AREAS IN ANY WAY.
- 4. METER SETTING VALUES:

SIZE	COUPLING SPACE A	FLOW (GPM)	
5/8"	12.5"	1/2"	20
5/8" x 3/4"	12.5"	3/4"	20
3/4"	14.25"	3/4"	30
1"	16.5"	1"	50

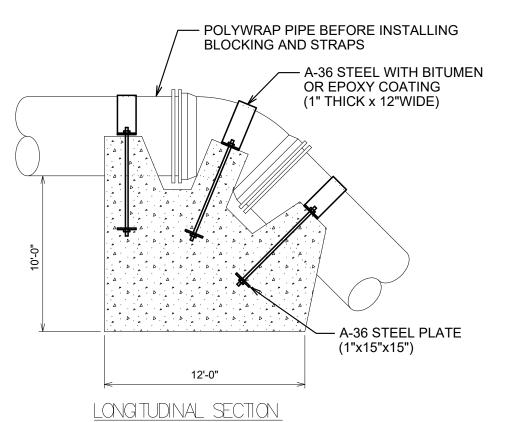- 5. THE METER AND MXU SHALL BE PURCHASED FROM AND INSTALLED BY PWSA.
- METER ASSEMBLY SETTINGS MUST BE INSTALLED BY THE CUSTOMER BEFORE THE METER WILL BE SET INCLUDING METER SIGNAL WIRING.
- 7. CUSTOMER SHALL PROVIDE PROPER DRAIN AT METER SETTING LOCATION.
- METER MUST BE INSTALLED IN A HORIZONTAL POSITION ONLY.
- CUSTOMER TO BE PROVIDE DATA FOR PROPER PWSA SIZING AND PEAK DOMESTIC DEMAND.





- 1. THE DETAIL REPRESENTS THE APPROXIMATE BLOCKING CONFIGURATION AND ASSUMES SOUD SOIL AND PROPER BURIAL
- 2. EXACT SHAPE AND SIZE TO BE DETERMINED IN THE FIELD.
- 3. POOR SOIL CONDITIONS WILL GREATLY INCREASE THE SIZE OF THE CONCRETE BLOCK.



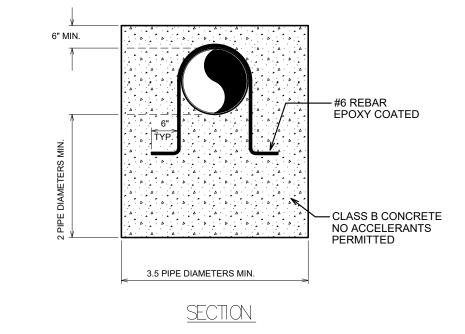
WS-VBL VERTICAL THRUST BLOCK FOR LARGE PIPE

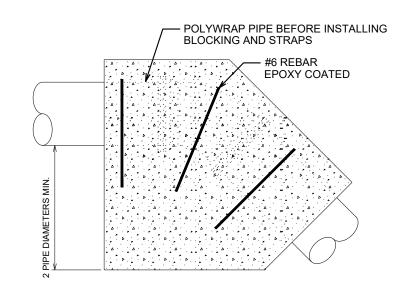
SCALE: NTS

WEIGHT

13.1

17.7






LONG TUDINAL SECTION


- 1. THE DETAIL REPRESENTS THE APPROXIMATE BLOCKING CONFIGURATION AND ASSUMES SOLID SOIL AND PROPER BURIAL.
- 2, EXACT SHAPE AND SIZE TO BE DETERMINED IN THE FIELD.
- 3. POOR SOIL CONDITIONS WILL GREATLY INCREASE THE SIZE OF THE CONCRETE BLOCK.


WS-5CDI

SCALE: NTS

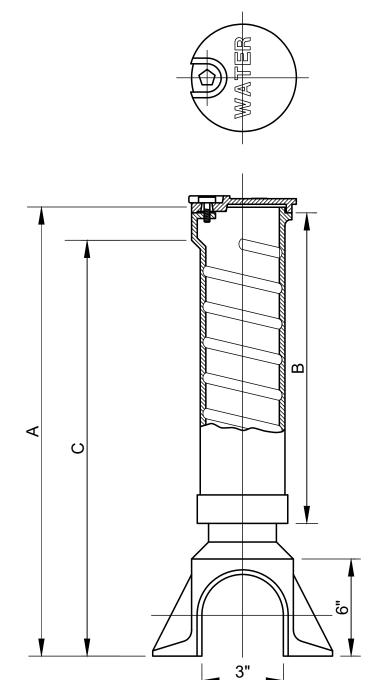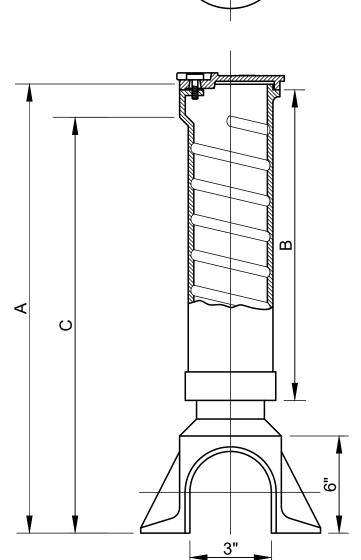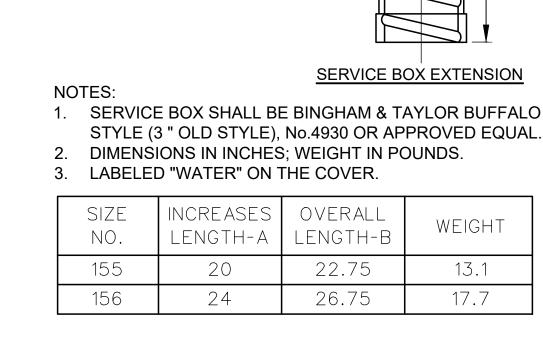WS-VB VERTICAL THRUST BLOCK FOR SMALL PIPE







TOP SECTION, BOTTOM SECTION AND COVER

SIZE	EXTENSION	TOP S	TOP SECTION & COVER BOTTOM SECTION						
NO.	RANGE - A	NO.	WEIGHT	DIM. B	NO.	WEIGHT	DIM. C	WEIGHT	
2	24'' - 39''	9	19.6	18	2	14.1	23.0	32.7	



WCB-1 3" CURB SERVICE BOX DETAIL



95 South Tenth Street Pittsburgh, Pennsylvania 15203 www.laquatrabonci.com 412.488.8822



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Lower Hill-Curtain Call Pittsburgh, PA

Project Number

Drawn by: BN | SD

21020:1

Checked by: CS | BD

Date: April 28, 2023

Revisions:


Sheet Name:

WATER SUPPLY DETAIL

Submission:

100% Construction Documents

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MAJOR CONTOUR

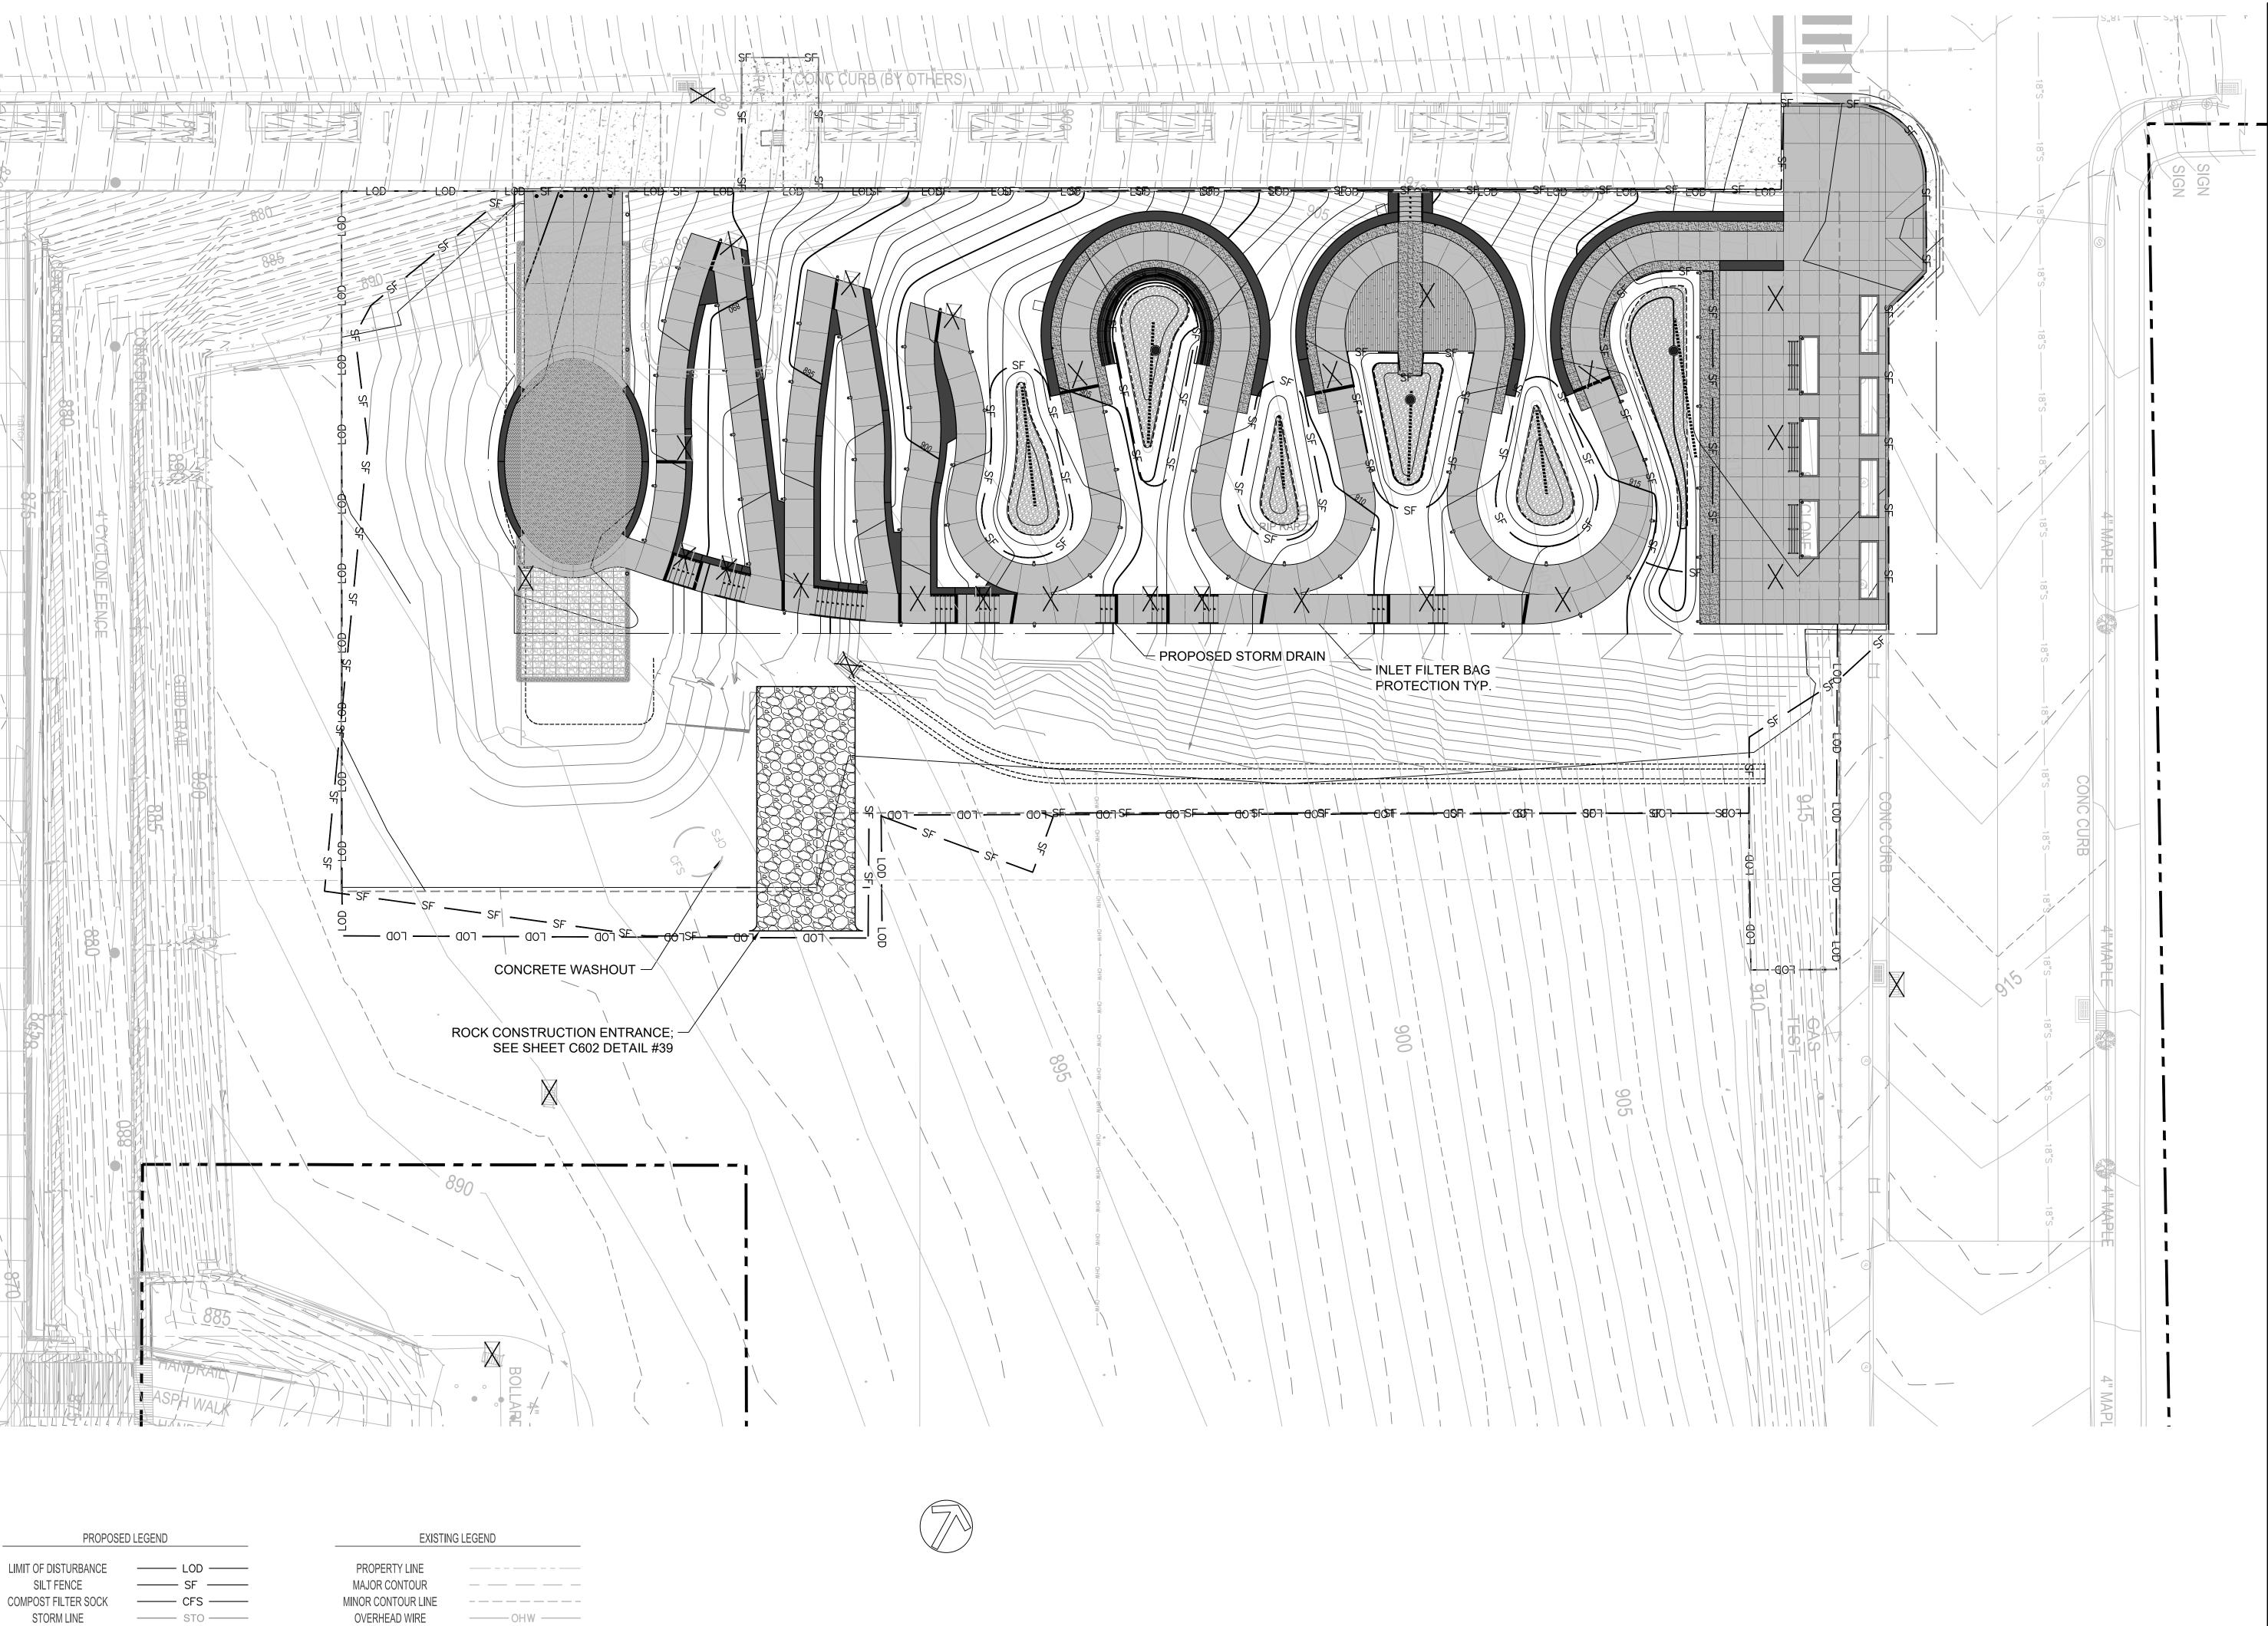MINOR CONTOUR LINE

STORM LINE

SANITARY LINE

_____ STO _____



Landscape Architecture

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Lower Hill-Curtain Call
Pittsburgh, PA

Project Number: 21020:1

Drawn by: BN | SD

Checked by: CS | BD

April 28, 2023
Revisions:

Date:

S c a l e :
0' 15'

Sheet Name:

E & S CONTROL PLAN

Submission:

100% Construction Documents

Sheet Number:

C600

GENERAL NOTES:

- 1. ALL EARTH DISTURBANCES, INCLUDING CLEARING AND GRUBBING AS WELL AS CUTS AND FILLS SHALL BE DONE IN ACCORDANCE WITH THE APPROVED E&S PLAN. A COPY OF THE APPROVED DRAWINGS (STAMPED, SIGNED AND DATED BY THE REVIEWING AGENCY) MUST BE AVAILABLE AT THE PROJECT SITE AT ALL TIMES. THE REVIEWING AGENCY SHALL BE NOTIFIED OF ANY CHANGES TO THE APPROVED PLAN PRIOR TO IMPLEMENTATION OF THOSE CHANGES. THE REVIEWING AGENCY MAY REQUIRE A WRITTEN SUBMITTAL OF THOSE CHANGES FOR REVIEW AND APPROVAL AT ITS DISCRETION.
- 2. AT LEAST 7 DAYS PRIOR TO STARTING ANY EARTH DISTURBANCE ACTIVITIES, INCLUDING CLEARING AND GRUBBING, THE OWNER AND/OR OPERATOR SHALL INVITE ALL CONTRACTORS, THE LANDOWNER, APPROPRIATE MUNICIPAL OFFICIALS, THE E&S PLAN PREPARER, AND A REPRESENTATIVE FROM THE LOCAL CONSERVATION DISTRICT TO AN ON-SITE PRE-CONSTRUCTION MEETING.
- 3. AT LEAST 3 DAYS PRIOR TO STARTING ANY EARTH DISTURBANCE ACTIVITIES, OR EXPANDING INTO AN AREA PREVIOUSLY UNMARKED, THE PENNSYLVANIA ONE CALL SYSTEM INC. SHALL BE NOTIFIED AT 1-800-242-1776 FOR THE LOCATION OF EXISTING UNDERGROUND UTILITIES.
- 4. ALL EARTH DISTURBANCE ACTIVITIES SHALL PROCEED IN ACCORDANCE WITH THE SEQUENCE PROVIDED ON THE PLAN DRAWINGS. DEVIATION FROM THAT SEQUENCE MUST BE APPROVED IN WRITING FROM THE LOCAL CONSERVATION DISTRICT OR BY THE PENNSYLVANIA DEPARTMENT OF ENVIRONMENTAL PROTECTION (DEPARTMENT) PRIOR TO IMPLEMENTATION.
- 5. AREAS TO BE FILLED ARE TO BE CLEARED, GRUBBED, AND STRIPPED OF TOPSOIL TO REMOVE TREES, VEGETATION, ROOTS AND OTHER **OBJECTIONABLE MATERIAL**
- CLEARING, GRUBBING, AND TOPSOIL STRIPPING SHALL BE LIMITED TO THOSE AREAS DESCRIBED IN EACH STAGE OF THE CONSTRUCTION SEQUENCE. GENERAL SITE CLEARING, GRUBBING AND TOPSOIL STRIPPING MAY NOT COMMENCE IN ANY STAGE OR PHASE OF THE PROJECT UNTIL THE E&S BMPS SPECIFIED BY THE BMP SEQUENCE FOR THAT STAGE OR PHASE HAVE BEEN INSTALLED AND ARE FUNCTIONING AS DESCRIBED IN THIS E&S PLAN.
- 7. AT NO TIME SHALL CONSTRUCTION VEHICLES BE ALLOWED TO ENTER AREAS OUTSIDE THE LIMIT OF DISTURBANCE BOUNDARIES SHOWN ON THE PLAN MAPS. THESE AREAS MUST BE CLEARLY MARKED AND FENCED OFF BEFORE CLEARING AND GRUBBING OPERATIONS BEGIN
- 8. TOPSOIL REQUIRED FOR THE ESTABLISHMENT OF VEGETATION SHALL BE STOCKPILED AT THE LOCATION(S) SHOWN ON THE PLAN MAPS(S) IN THE AMOUNT NECESSARY TO COMPLETE THE FINISH GRADING OF ALL EXPOSED AREAS THAT ARE TO BE STABILIZED BY VEGETATION. EACH STOCKPILE SHALL BE PROTECTED IN THE MANNER SHOWN ON THE PLAN DRAWINGS. STOCKPILE HEIGHTS SHALL NOT EXCEED 35 FEET. STOCKPILE SLOPES SHALL BE 2H:1V OR FLATTER
- 9. IMMEDIATELY UPON DISCOVERING UNFORESEEN CIRCUMSTANCES POSING THE POTENTIAL FOR ACCELERATED EROSION AND/OR SEDIMENT POLLUTION, THE OPERATOR SHALL IMPLEMENT APPROPRIATE BEST MANAGEMENT PRACTICES TO MINIMIZE THE POTENTIAL FOR EROSION AND SEDIMENT POLLUTION AND NOTIFY THE LOCAL CONSERVATION DISTRICT AND/OR THE REGIONAL OFFICE OF THE DEPARTMENT.
- 10. ALL BUILDING MATERIALS AND WASTES SHALL BE REMOVED FROM THE SITE AND RECYCLED OR DISPOSED OF IN ACCORDANCE WITH THE DEPARTMENT'S SOLID WASTE MANAGEMENT REGULATIONS AT 25 PA. CODE 260.1 ET SEQ., 271.1, AND 287.1 ET. SEQ. NO BUILDING MATERIALS OR WASTES OR UNUSED BUILDING MATERIALS SHALL BE BURNED, BURIED, DUMPED, OR DISCHARGED AT THE SITE
- 11. ALL OFF-SITE WASTE AND BORROW AREAS MUST HAVE AN E&S PLAN APPROVED BY THE LOCAL CONSERVATION DISTRICT OR THE DEPARTMENT FULLY IMPLEMENTED PRIOR TO BEING ACTIVATED.
- 12. THE CONTRACTOR IS RESPONSIBLE FOR ENSURING THAT ANY MATERIAL BROUGHT ON SITE IS CLEAN FILL. FORM FP-001 MUST BE RETAINED BY THE PROPERTY OWNER FOR ANY FILL MATERIAL AFFECTED BY A SPILL OR RELEASE OF A REGULATED SUBSTANCE BUT QUALIFYING AS CLEAN FILL DUE TO ANALYTICAL TESTING.
- 13. ALL PUMPING OF WATER FROM ANY WORK AREA SHALL BE DONE USING A PUMPED WATER FILTER BAG, OVER UNDISTURBED VEGETATED
- 14. VEHICLES AND EQUIPMENT MAY NEITHER ENTER DIRECTLY NOR EXIT DIRECTLY FROM LOTS (SPECIFY LOT NUMBERS) ONTO (SPECIFY ROAD
- 15. UNTIL THE SITE IS STABILIZED, ALL EROSION AND SEDIMENT BMPS SHALL BE MAINTAINED PROPERLY. MAINTENANCE SHALL INCLUDE INSPECTIONS OF ALL EROSION AND SEDIMENT BMPS AFTER EACH RUNOFF EVENT AND ON A WEEKLY BASIS. ALL PREVENTATIVE AND REMEDIAL MAINTENANCE WORK, INCLUDING CLEAN OUT, REPAIR, REPLACEMENT, REGRADING, RESEEDING, REMULCHING AND RENETTING MUST BE PERFORMED IMMEDIATELY. IF THE E&S BMPS FAIL TO PERFORM AS EXPECTED, REPLACEMENT BMPS, OR MODIFICATIONS OF THOSE INSTALLED WILL BE REQUIRED.
- 16. A LOG SHOWING DATES THAT E&S BMPS WERE INSPECTED AS WELL AS ANY DEFICIENCIES FOUND AND THE DATE THEY WERE CORRECTED SHALL BE MAINTAINED ON THE SITE AND BE MADE AVAILABLE TO REGULATORY AGENCY OFFICIALS AT THE TIME OF INSPECTION.
- 17. SEDIMENT TRACKED ONTO ANY PUBLIC ROADWAY OR SIDEWALK SHALL BE RETURNED TO THE CONSTRUCTION SITE BY THE END OF EACH WORK DAY AND DISPOSED IN THE MANNER DESCRIBED IN THIS PLAN. IN NO CASE SHALL THE SEDIMENT BE WASHED, SHOVELED, OR SWEPT INTO ANY ROADSIDE DITCH, STORM SEWER, OR SURFACE WATER.
- 18. ALL SEDIMENT REMOVED FROM BMPS SHALL BE DISPOSED OF UPSLOPE OF AN ESTABLISHED E&S BMP AS NOTED IN THE PLAN DRAWINGS.
- 19. AREAS WHICH ARE TO BE TOPSOILED SHALL BE SCARIFIED TO A MINIMUM DEPTH OF 3 TO 5 INCHES 6 TO 12 INCHES ON COMPACTED SOILS — PRIOR TO PLACEMENT OF TOPSOIL. AREAS TO BE VEGETATED SHALL HAVE A MINIMUM 4 INCHES OF TOPSOIL IN PLACE PRIOR TO SEEDING AND MULCHING. FILL OUTSLOPES SHALL HAVE A MINIMUM OF 2 INCHES OF TOPSOIL
- 20. ALL FILLS SHALL BE COMPACTED AS REQUIRED TO REDUCE EROSION, SLIPPAGE, SETTLEMENT, SUBSIDENCE OR OTHER RELATED PROBLEMS. FILL INTENDED TO SUPPORT BUILDINGS, STRUCTURES AND CONDUITS, ETC. SHALL BE COMPACTED IN ACCORDANCE WITH LOCAL REQUIREMENTS OR CODES.
- 21. ALL EARTHEN FILLS SHALL BE PLACED IN COMPACTED LAYERS NOT TO EXCEED 8 INCHES IN THICKNESS.
- 22. FILL MATERIALS SHALL BE FREE OF FROZEN PARTICLES, BRUSH, ROOTS, SOD, OR OTHER FOREIGN OR OBJECTIONABLE MATERIALS THAT WOULD INTERFERE WITH OR PREVENT CONSTRUCTION OF SATISFACTORY FILLS.
- 23. FROZEN MATERIALS OR SOFT, MUCKY, OR HIGHLY COMPRESSIBLE MATERIALS SHALL NOT BE INCORPORATED INTO FILLS.
- 24. FILL SHALL NOT BE PLACED ON SATURATED OR FROZEN SURFACES.
- 25. ALL GRADED AREAS SHALL BE PERMANENTLY STABILIZED IMMEDIATELY UPON REACHING FINISHED GRADE.
- 26. IMMEDIATELY AFTER EARTH DISTURBANCE ACTIVITIES CEASE IN ANY AREA OR SUBAREA OF THE PROJECT, THE OPERATOR SHALL STABILIZE ALL DISTURBED AREAS. DURING NON-GERMINATING MONTHS, MULCH OR PROTECTIVE BLANKETING SHALL BE APPLIED AS DESCRIBED IN THE PLAN, AREAS NOT AT FINISHED GRADE, WHICH WILL BE REACTIVATED WITHIN 1 YEAR, MAY BE STABILIZED IN ACCORDANCE WITH THE TEMPORARY STABILIZATION SPECIFICATIONS. THOSE AREAS WHICH WILL NOT BE REACTIVATED WITHIN 1 YEAR SHALL BE STABILIZED IN ACCORDANCE WITH THE PERMANENT STABILIZATION SPECIFICATIONS.
- 27. PERMANENT STABILIZATION IS DEFINED AS A MINIMUM UNIFORM, PERENNIAL 70% VEGETATIVE COVER OR OTHER PERMANENT NON-VEGETATIVE COVER WITH A DENSITY SUFFICIENT TO RESIST ACCELERATED EROSION. CUT AND FILL SLOPES SHALL BE CAPABLE OF RESISTING FAILURE DUE TO SLUMPING, SLIDING, OR OTHER MOVEMENTS.
- 28. E&S BMPS SHALL REMAIN FUNCTIONAL AS SUCH UNTIL ALL AREAS TRIBUTARY TO THEM ARE PERMANENTLY STABILIZED OR UNTIL THEY ARE REPLACED BY ANOTHER BMP APPROVED BY THE LOCAL CONSERVATION DISTRICT OR THE DEPARTMENT.
- 29. UPON COMPLETION OF ALL EARTH DISTURBANCE ACTIVITIES AND PERMANENT STABILIZATION OF ALL DISTURBED AREAS, THE OWNER AND/OR OPERATOR SHALL CONTACT THE LOCAL CONSERVATION DISTRICT FOR AN INSPECTION PRIOR TO REMOVAL/CONVERSION OF THE E&S BMPS
- 30. AFTER FINAL SITE STABILIZATION HAS BEEN ACHIEVED, TEMPORARY EROSION AND SEDIMENT BMPS MUST BE REMOVED OR CONVERTED TO PERMANENT POST CONSTRUCTION STORMWATER MANAGEMENT BMPS. AREAS DISTURBED DURING REMOVAL OR CONVERSION OF THE BMPS SHALL BE STABILIZED IMMEDIATELY. IN ORDER TO ENSURE RAPID REVEGETATION OF DISTURBED AREAS, SUCH REMOVAL/CONVERSIONS ARE TO BE DONE ONLY DURING THE GERMINATING SEASON.
- 31. UPON COMPLETION OF ALL EARTH DISTURBANCE ACTIVITIES AND PERMANENT STABILIZATION OF ALL DISTURBED AREAS, THE OWNER AND/OR OPERATOR SHALL CONTACT THE LOCAL CONSERVATION DISTRICT TO SCHEDULE A FINAL INSPECTION
- 32. FAILURE TO CORRECTLY INSTALL E&S BMPS, FAILURE TO PREVENT SEDIMENT-LADEN RUNOFF FROM LEAVING THE CONSTRUCTION SITE, OR FAILURE TO TAKE IMMEDIATE CORRECTIVE ACTION TO RESOLVE FAILURE OF E&S BMPS MAY RESULT IN ADMINISTRATIVE. CIVIL. AND/OR CRIMINAL PENALTIES BEING INSTITUTED BY THE DEPARTMENT AS DEFINED IN SECTION 602 OF THE PENNSYLVANIA CLEAN STREAMS LAW. THE CLEAN STREAMS LAW PROVIDES FOR UP TO \$10,000 PER DAY IN CIVIL PENALTIES, UP TO \$10,000 IN SUMMARY CRIMINAL PENALTIES, AND UP TO \$25,000 IN MISDEMEANOR CRIMINAL PENALTIES FOR EACH VIOLATION.

STAGING OF CONSTRUCTION ACTIVITIES:

THE FOLLOWING SEQUENCE OF CONSTRUCTION ACTIVITIES HAVE BEEN DEVELOPED TO PROVIDE THE CONTRACTOR WITH A GENERAL PROCEDURE FOR THE CONSTRUCTION OF THE PROPOSED IMPROVEMENT. THE PROCEDURE IS INTENDED TO ADDRESS THE POTENTIAL FOR SEDIMENT POLLUTION AND ACCELERATED EROSION AS A RESULT OF THE PROJECT CONSTRUCTION.

SEQUENCE OF CONSTRUCTION:

- 1. INSTALL ROCK CONSTRUCTION ENTRANCE AT THE ANTICIPATED ENTRANCE TO THE CONSTRUCTION AREA.
- 2. INSTALL SEDIMENT FILTER BAG INLET PROTECTION IN THE EXISTING DRAINS WITHIN THE PROJECT LIMITS OF DISTURBANCE, IF IDENTIFIED IN THE FIELD. INSTALL SUPPLEMENTAL INLET PROTECTION TO AVOID SEDIMENTATION OF THE STORM SEWER SYSTEM.
- 3. INSTALL COMPOST FILTER SOCK IN THE ALIGNMENTS PRESENTED ON THE E&SPC PLAN DRAWINGS.
- 4. ESTABLISH TOPSOIL STOCKPILE AREA.
- 5. DEMOLISH THE EXISTING HARDSCAPE FEATURES AS NOTED IN THE BID DOCUMENTS.
- 6. PERFORM CLEAR AND GRUBBING ACTIVITIES WITHIN THE PROJECT LIMITS OF DISTURBANCE TO REMOVE THE EXISTING VEGETATION NOT DEMARCATED BY TEMPORARY PROTECTIVE FENCING.
- 7. REMOVE TOPSOIL AND STOCKPILE AT THE DESIGNATED ONSITE LOCATION FOR REUSE PRIOR TO ESTABLISHING PERMANENT VEGETATIVE STABILIZATION.
- 8. PERFORM ROUGH EARTHWORK ACTIVITIES AS PRESENTED ON THE E&SPC PLAN DRAWINGS.
- 9. ESTABLISH CONCRETE WASHOUT FACILITY ONSITE FOR WASHING OF CONCRETE TRUCKS.
- 10. INSTALL PROPOSED HARDSCAPE FEATURES AND PERFORM FINE GRADING ACTIVITIES, APPLYING THE STOCKPILED TOPSOIL TO AREAS TO BE SEEDED.
- 11. INSTALL TREES AND PLANTINGS. APPLY MULCH OR THE PERMANENT SEED MIX TO THE NON-PAVED AREAS TO STABILIZED, AS INDICATED IN THE BID DOCUMENTS.

2" X 2" X 36" WOODEN

SECTION VIEW

PLAN VIEW

SCALE:NTS

CONCRETE WASHOUT FACILITY

STAKES PLACED 5' O.C.

RING HEIGHT

MAXIMUM DEPTH OF CONCRETE

WASHOUT WATER IS 50% OF FILTER

24" DIAMETER COMPOST

FILTER SOCK

DIRECT CONCRETE

FILTER RING

2" X 2" X 36" WOODEN

STAKES PLACED 5' O.C.

WASHOUT WATER INTO

24" DIAMETER COMPOST

OVERLAP ON UPSLOPE

SIDE OF FILTER RING

FILTER SOCK 4' MIN.

- 12. RETAIN EROSION AND SEDIMENT CONTROLS IN PLACE UNTIL 70% UNIFORM PERENNIAL VEGETATIVE STABILIZATION IS ACHIEVED AT AREAS TO BE SEEDED OR UNTIL EXPOSED EARTH SURFACES ARE COVERED WITH A PERMANENT AGGREGATE, MULCH, OR HARDSCAPE MATERIAL.
- 13. REMOVE EROSION AND SEDIMENT CONTROLS UPON STABILIZATION OF ALL SURFACES.

IMPERVIOUS LINER





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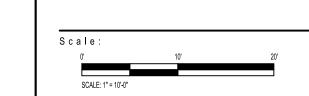
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Project Number 21020:1 Drawn by: BN | SD Checked by: CS | BD Date: April 28, 2023 Revisions:




E & S CONTROL DETAIL

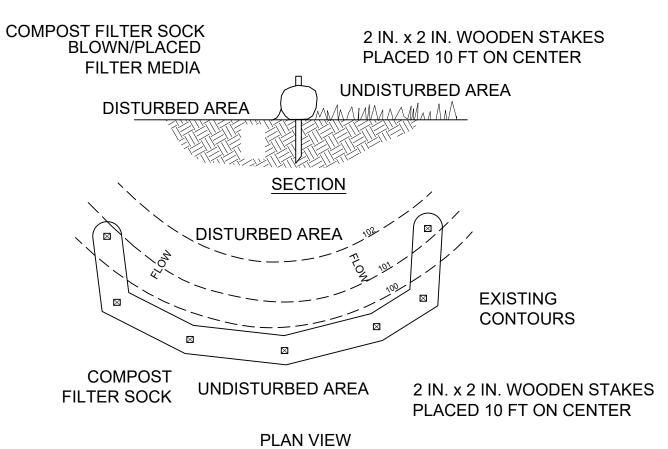Submission:

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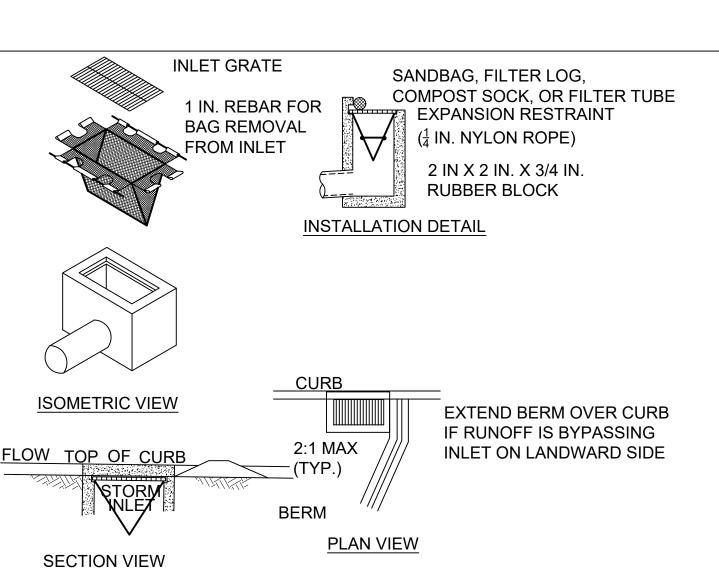


NOTES

- SOCK FABRIC SHALL MEET STANDARDS OF TABLE 4.1 OF THE PADEP EROSION CONTROL MANUAL. COMPOST SHALL MEET THE STANDARDS OF TABLE 4.2 OF THE PADEP EROSION CONTROL MANUAL
- 2. COMPOST FILTER SOCK SHALL BE PLACED AT EXISTING LEVEL GRADE. BOTH ENDS OF THE BARRIER SHALL BE EXTENDED AT LEAST 8 FEET UP SLOPE AT 45 DEGREES TO THE MAIN BARRIER ALIGNMENT. MAXIMUM SLOPE LENGTH ABOVE ANY BARRIER SHALL NOT EXCEED THAT SPECIFIED FOR THE SIZE OF THE SOCK AND THE SLOPE OF ITS TRIBUTARY AREA.
- 3. TRAFFIC SHALL NOT BE PERMITTED TO CROSS COMPOST FILTER SOCKS
- 4. ACCUMULATED SEDIMENT SHALL BE REMOVED WHEN IT REACHES 1/2 THE ABOVE GROUND HEIGHT OF THE BARRIER AND DISPOSED IN THE MANNER DESCRIBED ELSEWHERE IN THE PLAN
- COMPOST FILTER SOCKS SHALL BE INSPECTED WEEKLY AND AFTER EACH RUNOFF EVENT. DAMAGED SOCKS SHALL BE REPAIRED ACCORDING TO MANUFACTURER'S SPECIFICATIONS OR REPLACED WITHIN 24 HOURS OF INSPECTION.
- BIODEGRADABLE COMPOST FILTER SOCKS SHALL BE REPLACED AFTER 6 MONTHS; PHOTODEGRADABLE SOCKS AFTER 1 YEAR. POLYPROPYLENE SOCKS SHALL BE REPLACED ACCORDING TO MANUFACTURER'S RECOMMENDATIONS.

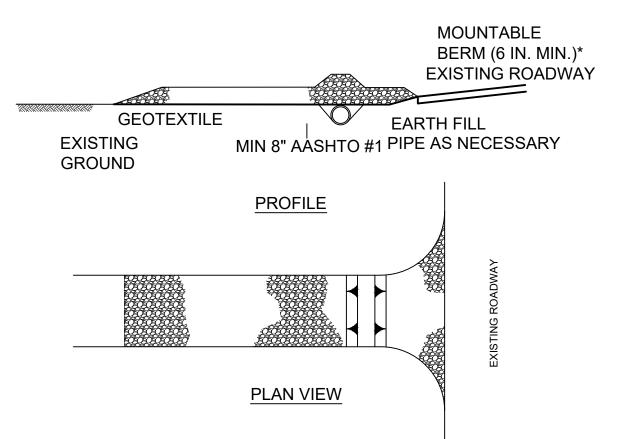


COMPOST FILTER SOCK



NOTES:

- MAXIMUM DRAINAGE AREA = 1/2 ACRE.
- ROLLED EARTHEN BERM SHALL BE MAINTAINED UNTIL ROADWAY IS STONED. ROAD SUBBASE BERM SHALL BE MAINTAINED UNTIL ROADWAY IS PAVED. SIX INCH MINIMUM HEIGHT ASPHALT BERM SHALL BE MAINTAINED UNTIL ROADWAY SURFACE RECEIVES FINAL COAT.
- 3. AT A MINIMUM, THE FABRIC SHALL HAVE A MINIMUM GRAB TENSILE STRENGTH OF 120 LBS, A MINIMUM BURST STRENGTH OF 200 PSI, AND A MINIMUM TRAPEZOIDAL TEAR STRENGTH OF 50 LBS. FILTER BAGS SHALL BE CAPABLE OF TRAPPING ALL PARTICLES NOT PASSING A NO. 40 SIEVE.
- 4. INLET FILTER BAGS SHALL BE INSPECTED ON A WEEKLY BASIS AND AFTER EACH RUNOFF EVENT. BAGS SHALL BE EMPTIED AND RINSED OR REPLACED WHEN HALF FULL OR WHEN FLOW CAPACITY HAS BEEN REDUCED SO AS TO CAUSE FLOODING OR BYPASSING OF THE INLET. DAMAGED OR CLOGGED BAGS SHALL BE REPLACED. A SUPPLY SHALL BE MAINTAINED ON SITE FOR REPLACEMENT OF BAGS. ALL NEEDED REPAIRS SHALL BE INITIATED IMMEDIATELY AFTER THE INSPECTION. DISPOSE OF ACCUMULATED SEDIMENT AS WELL AS ALL USED BAGS ACCORDING TO THE PLAN NOTES.
- 5. DO NOT USE ON MAJOR PAVED ROADWAYS WHERE PONDING MAY CAUSE TRAFFIC HAZARDS.



* MOUNTABLE BERM USED TO PROVIDE PROPER COVER FOR PIPE

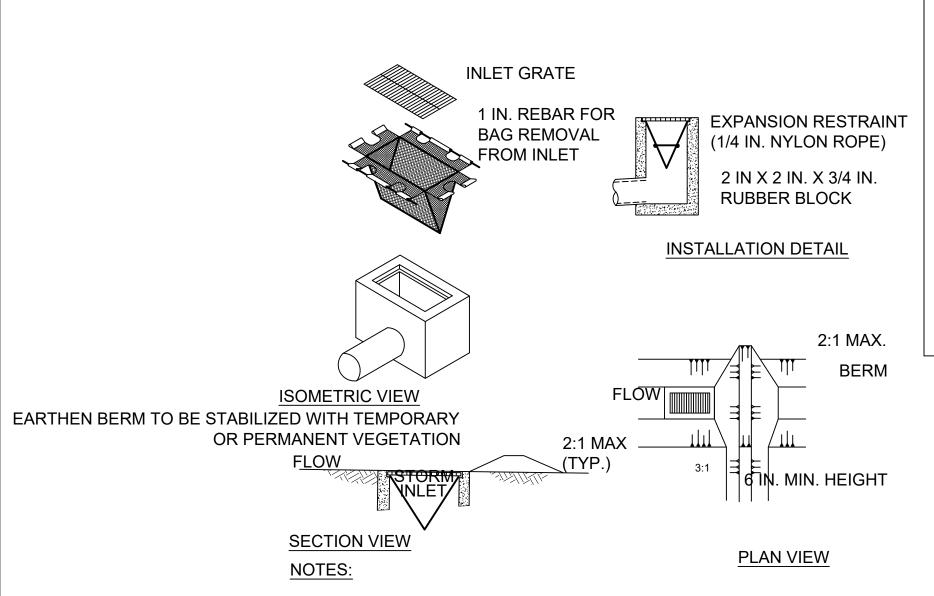
NOTES:

- REMOVE TOPSOIL PRIOR TO INSTALLATION OF ROCK CONSTRUCTION ENTRANCE. EXTEND ROCK OVER FULL WIDTH OF ENTRANCE.
- RUNOFF SHALL BE DIVERTED FROM ROADWAY TO A SUITABLE SEDIMENT REMOVAL BMP PRIOR TO ENTERING ROCK CONSTRUCTION ENTRANCE.
- MOUNTABLE BERM SHALL BE INSTALLED WHEREVER OPTIONAL CULVERT PIPE IS USED AND PROPER PIPE COVER AS SPECIFIED BY MANUFACTURER IS NOT OTHERWISE PROVIDED. PIPE SHALL BE SIZED APPROPRIATELY FOR SIZE OF DITCH BEING CROSSED.
- MAINTENANCE: ROCK CONSTRUCTION ENTRANCE THICKNESS SHALL BE CONSTANTLY MAINTAINED TO THE SPECIFIED DIMENSIONS BY ADDING ROCK. A STOCKPILE SHALL BE MAINTAINED ON SITE FOR THIS PURPOSE ALL SEDIMENT DEPOSITED ON PAVED ROADWAYS SHALL BE REMOVED AND RETURNED TO THE CONSTRUCTION SITE IMMEDIATELY. IF EXCESSIVE AMOUNTS OF SEDIMENT ARE BEING DEPOSITED ON ROADWAY, EXTEND LENGTH OF ROCK CONSTRUCTION ENTRANCE BY 50 FOOT INCREMENTS UNTIL CONDITION IS ALLEVIATED OR INSTALL WASH RACK. WASHING THE ROADWAY OR SWEEPING THE DEPOSITS INTO ROADWAY DITCHES, SEWERS, CULVERTS, OR OTHER DRAINAGE COURSES IS NOT ACCEPTABLE




ROCK CONSTRUCTION ENTRANCE

SCALE: NTS



- 1. MAXIMUM DRAINAGE AREA = 1/2 ACRE.
- 2. ROLLED EARTHEN BERM IN ROADWAY SHALL BE MAINTAINED UNTIL ROADWAY IS STONED. ROAD SUBBASE BERM ON ROADWAY SHALL BE MAINTAINED UNTIL ROADWAY IS PAVED. EARTHEN BERM IN CHANNEL SHALL BE MAINTAINED UNTIL PERMANENT STABILIZATION IS COMPLETED OR REMAIN PERMANENTLY.
- 3. AT A MINIMUM, THE FABRIC SHALL HAVE A MINIMUM GRAB TENSILE STRENGTH OF 120 LBS., A MINIMUM BURST STRENGTH OF 200 PSI, AND A MINIMUM TRAPEZOIDAL TEAR STRENGTH OF 50 LBS. FILTER BAGS SHALL BE CAPABLE OF TRAPPING ALL PARTICLES NOT PASSING A NO. 40 SIEVE.
- 4. INLET FILTER BAGS SHALL BE INSPECTED ON A WEEKLY BASIS AND AFTER EACH RUNOFF EVENT. BAGS SHALL BE EMPTIED AND RINSED OR REPLACED WHEN HALF FULL OR WHEN FLOW CAPACITY HAS BEEN REDUCED SO AS TO CAUSE FLOODING OR BYPASSING OF THE INLET. DAMAGED OR CLOGGED BAGS SHALL BE REPLACED. A SUPPLY SHALL BE MAINTAINED ON SITE FOR REPLACEMENT OF BAGS. ALL NEEDED REPAIRS SHALL BE INITIATED IMMEDIATELY AFTER THE INSPECTION. DISPOSE ACCUMULATED SEDIMENT AS WELL AS ALL USED BAGS ACCORDING TO THE PLAN NOTES.
- 5. DO NOT USE ON MAJOR PAVED ROADWAYS WHERE PONDING MAY CAUSE TRAFFIC HAZARDS.

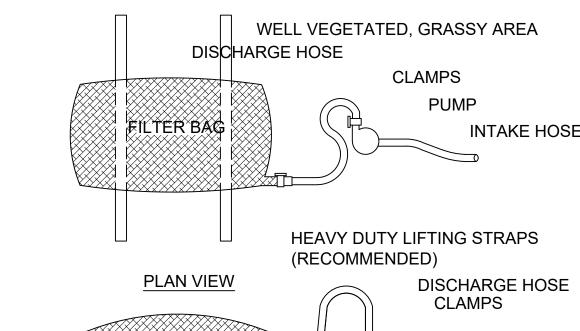

FILTER BAG WELL VEGETATED, GRASSY AREA

NOTES:

INTAKE HOSE ELEVATION VIEW

LOW VOLUME FILTER BAGS SHALL BE MADE FROM NON-WOVEN GEOTEXTILE MATERIAL SEWN WITH HIGH STRENGTH, DOUBLE STITCHED "J" TYPE SEAMS. THEY SHALL BE CAPABLE OF TRAPPING PARTICLES LARGER THAN 150 MICRONS. HIGH VOLUME FILTER BAGS SHALL BE MADE FROM WOVEN GEOTEXTILES THAT MEET THE **FOLLOWING STANDARDS:**

PROPERTY	TEST METHOD	MINIMUM STANDARD
AVG. WIDE WIDTH STRENGTH	ASTM D-4884	60 LB/IN
GRAB TENSILE	ASTM D-4632	205 LB
PUNCTURE	ASTM D-4833	110 LB
MULLEN BURST	ASTM D-3786	350 PSI
UV RESISTANCE	ASTM D-4355	70%
AOS % RETAINED	ASTM D-4751	80 SIEVE

- 1. A SUITABLE MEANS OF ACCESSING THE BAG WITH MACHINERY REQUIRED FOR DISPOSAL PURPOSES SHALL BE PROVIDED. FILTER BAGS SHALL BE REPLACED WHEN THEY BECOME 1/2 FULL OF SEDIMENT. SPARE BAGS SHALL BE KEPT AVAILABLE FOR REPLACEMENT OF THOSE THAT HAVE FAILED OR ARE FILLED. BAGS SHALL BE PLACED ON STRAPS TO FACILITATE REMOVAL UNLESS BAGS COME WITH LIFTING STRAPS ALREADY ATTACHED.
- 2. BAGS SHALL BE LOCATED IN WELL-VEGETATED (GRASSY) AREA, AND DISCHARGE ONTO STABLE, EROSION RESISTANT AREAS. WHERE THIS IS NOT POSSIBLE, A GEOTEXTILE UNDERLAYMENT AND FLOW PATH SHALL BE PROVIDED. BAGS MAY BE PLACED ON FILTER STONE TO INCREASE DISCHARGE CAPACITY. BAGS SHALL NOT BE PLACED ON SLOPES GREATER THAN 5%. FOR SLOPES EXCEEDING 5% CLEAN ROCK OR OTHER NON-ERODIBLE AND NON-POLLUTING MATERIAL MAY BE PLACED UNDER THE BAG TO REDUCE SLOPE STEEPNESS.
- 3. NO DOWNSLOPE SEDIMENT BARRIER IS REQUIRED FOR MOST INSTALLATIONS. COMPOST BERM OR COMPOST FILTER SOCK SHALL BE INSTALLED BELOW BAGS LOCATED IN HQ OR EV WATERSHEDS, WITHIN 50 FEET OF ANY RECEIVING SURFACE WATER OR WHERE GRASSY AREA IS NOT AVAILABLE
- 4. THE PUMP DISCHARGE HOSE SHALL BE INSERTED INTO THE BAGS IN THE MANNER SPECIFIED BY THE MANUFACTURER AND SECURELY CLAMPED. A PIECE OF PVC PIPE IS RECOMMENDED FOR THIS PURPOSE.
- 5. THE PUMPING RATE SHALL BE NO GREATER THAN 750 GPM OR 1/2 THE MAXIMUM SPECIFIED BY THE MANUFACTURER, WHICHEVER IS LESS. PUMP INTAKES SHALL BE FLOATING AND SCREENED.
- 6. FILTER BAGS SHALL BE INSPECTED DAILY. IF ANY PROBLEM IS DETECTED, PUMPING SHALL CEASE IMMEDIATELY AND NOT RESUME UNTIL THE PROBLEM IS CORRECTED.





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Lower Hill-Curtain Call Pittsburgh, PA

Project Number

21020:1 Drawn by:

BN | SD Checked by: CS | BD

Date: April 28, 2023

Revisions:

Sheet Name: E & S CONTROL DETAIL

Submission:

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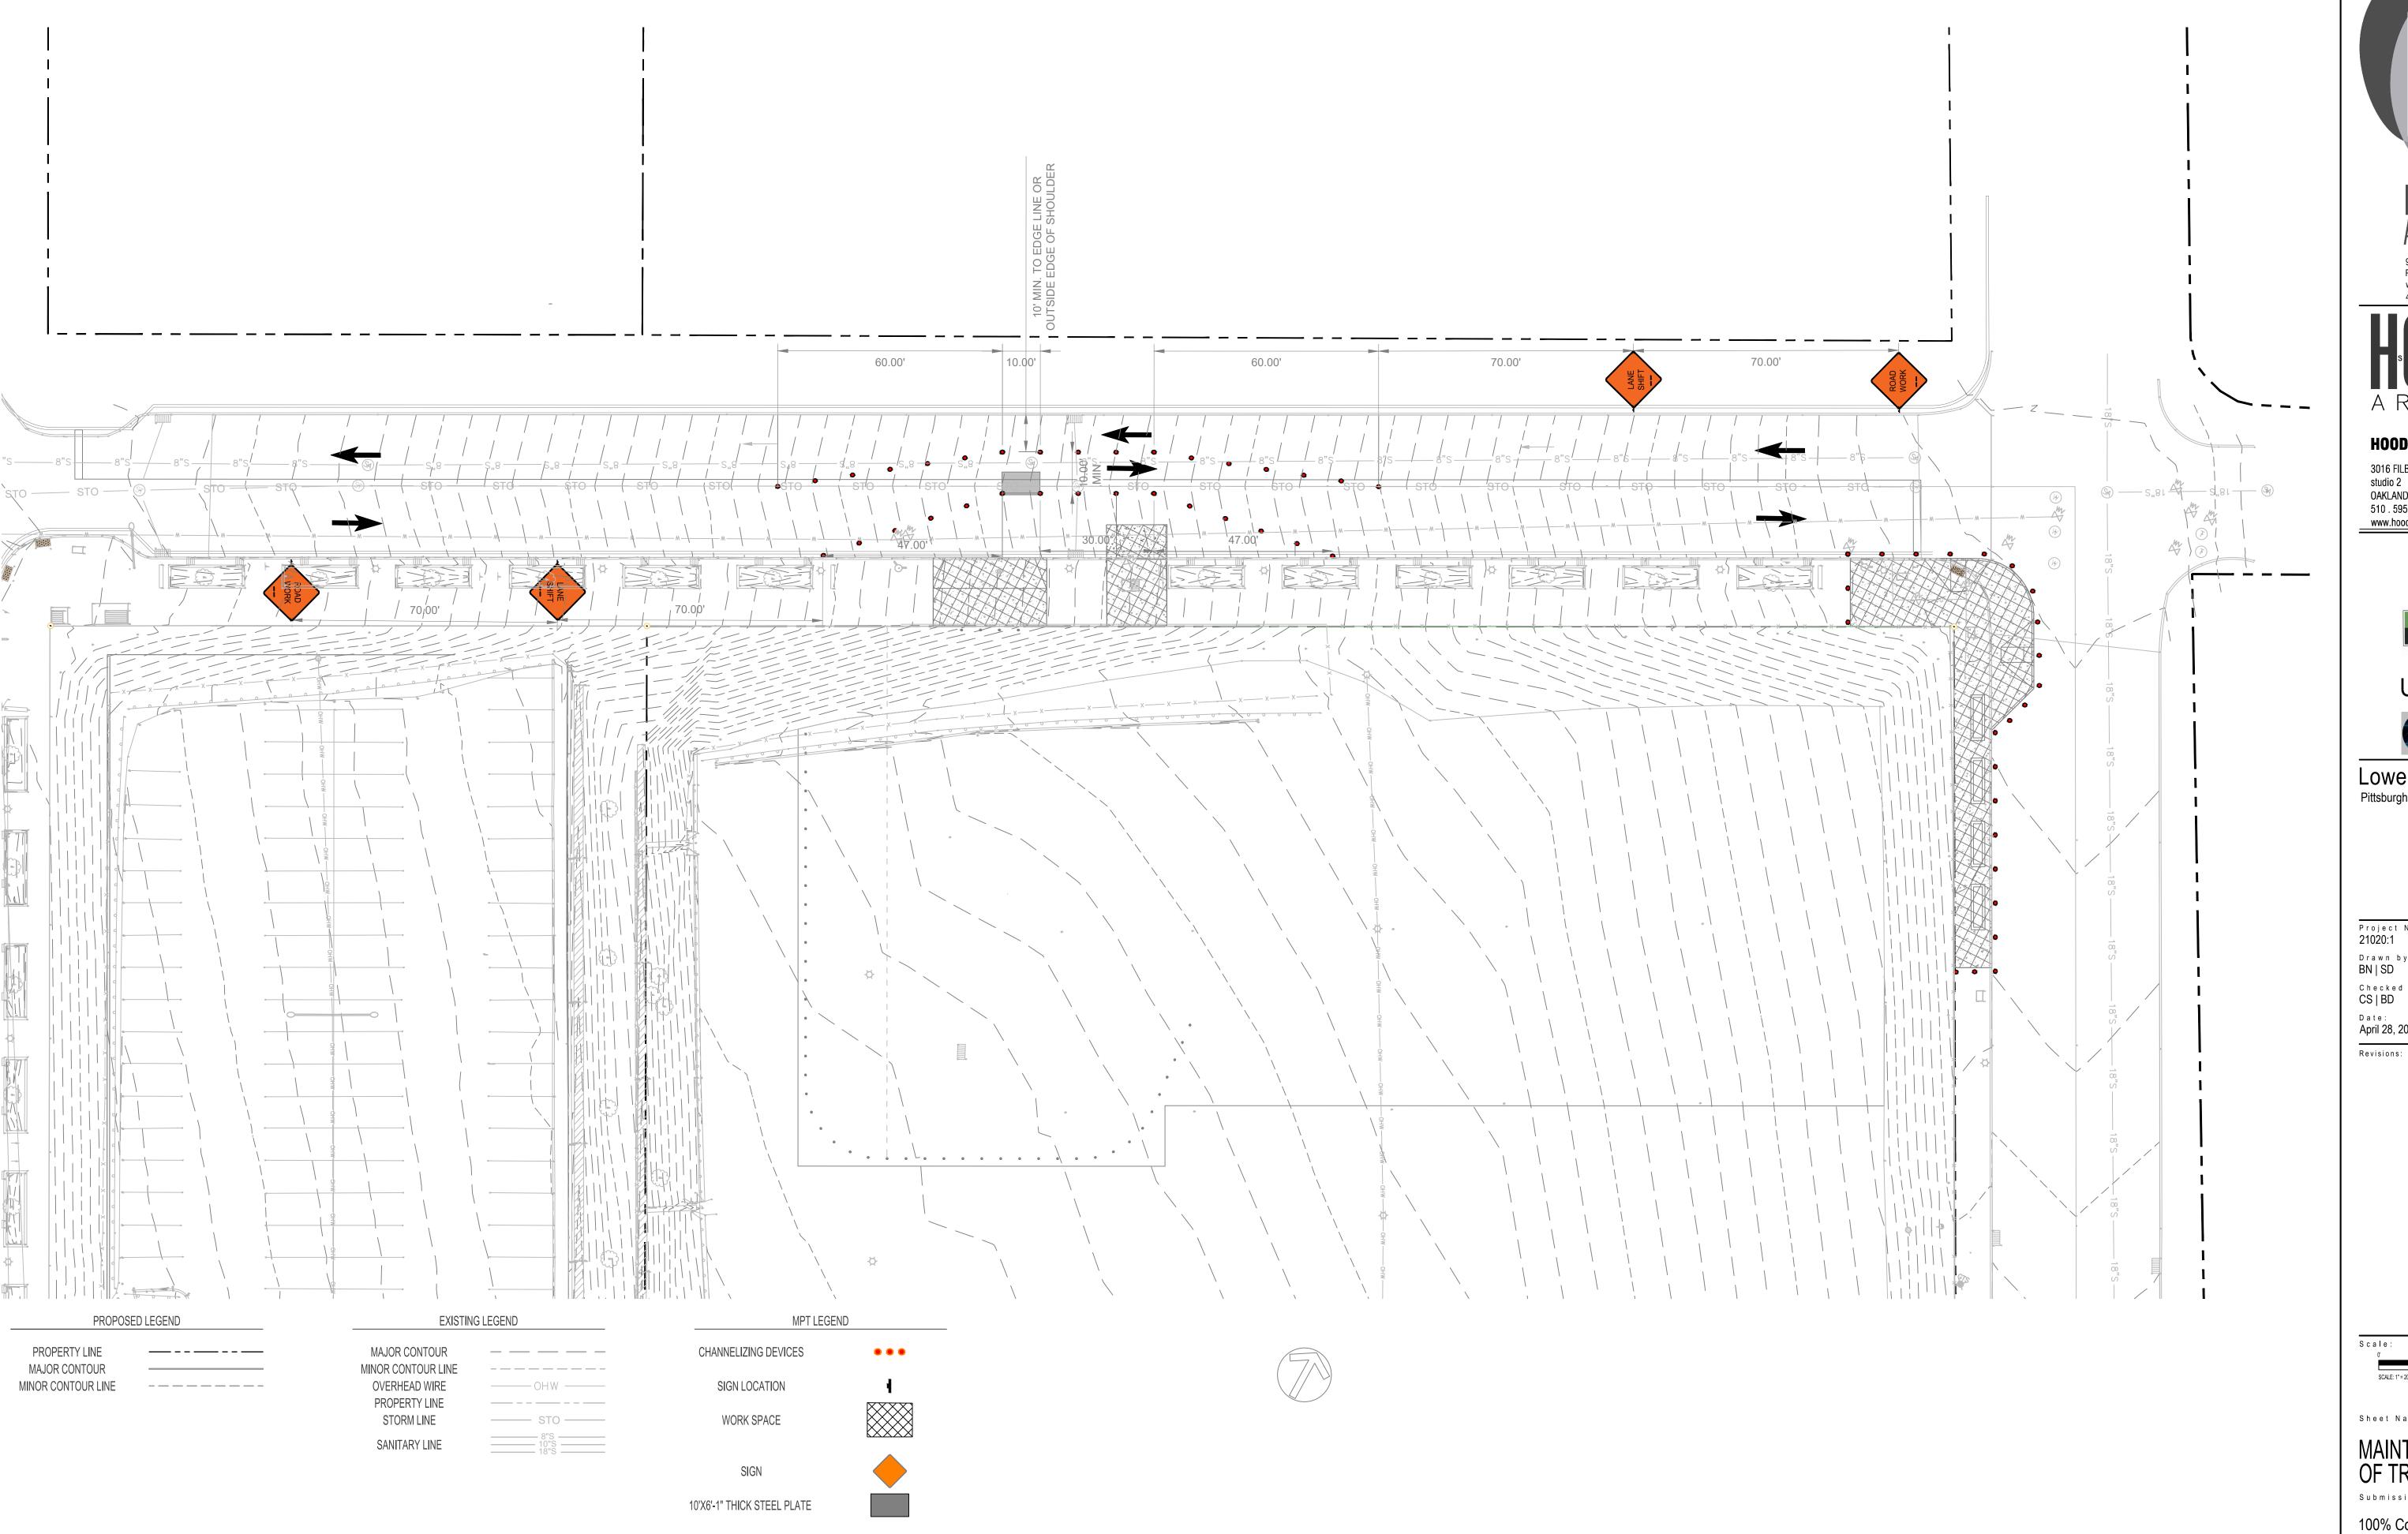
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FILTER BAG INLET PROTECTION - TYPE C INLET SCALE: NTS

SCALE: NTS

FILTER BAG INLET PROTECTION - TYPE M INLET







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Drawn by: BN | SD

Checked by: CS | BD

April 28, 2023

Sheet Name:

MAINT. & PROTECTION OF TRAFFIC PLAN

Submission:

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Sheet Number:



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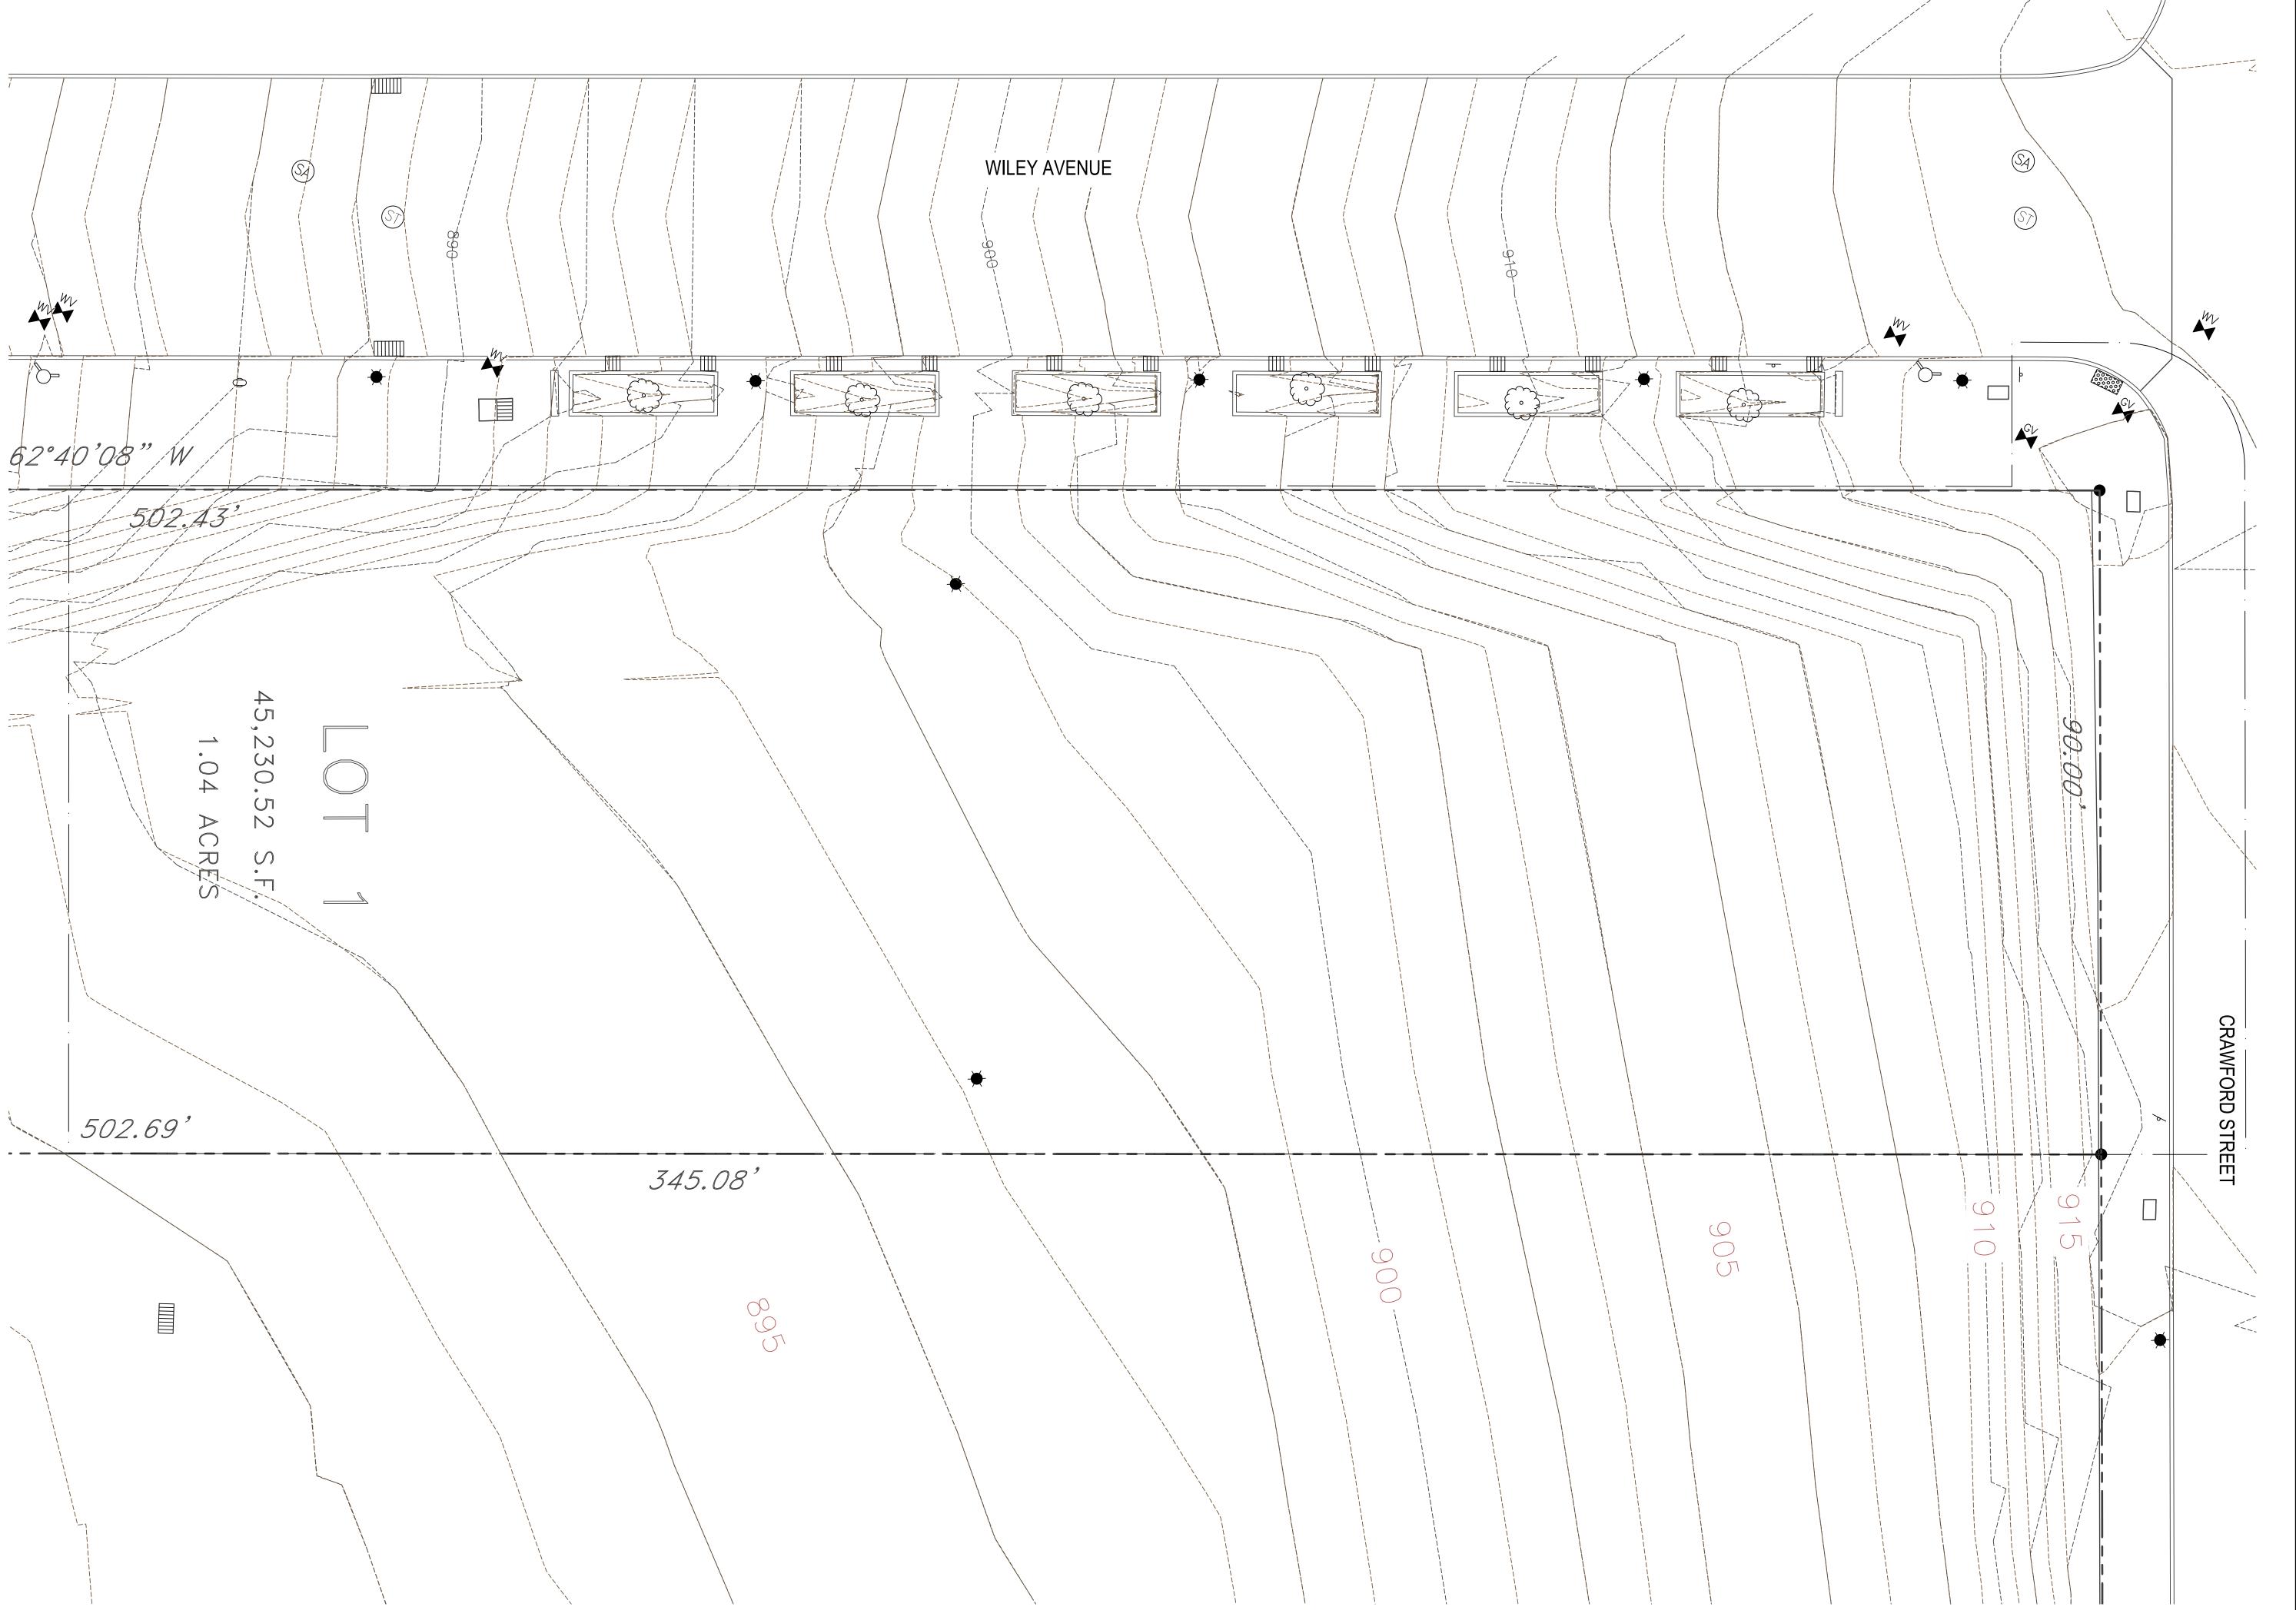




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PROPOSED SUBDIVISION PLAN

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Project Number: 21020:1

Drawn by: DM | CT

Checked by: FB | DM Date: April 28, 2023

April 20, 2023

S c a l e :

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SCALE: 1" = 10'-0"

Chaat Nama:


Existing Conditions

Submission:

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Sheet Number:

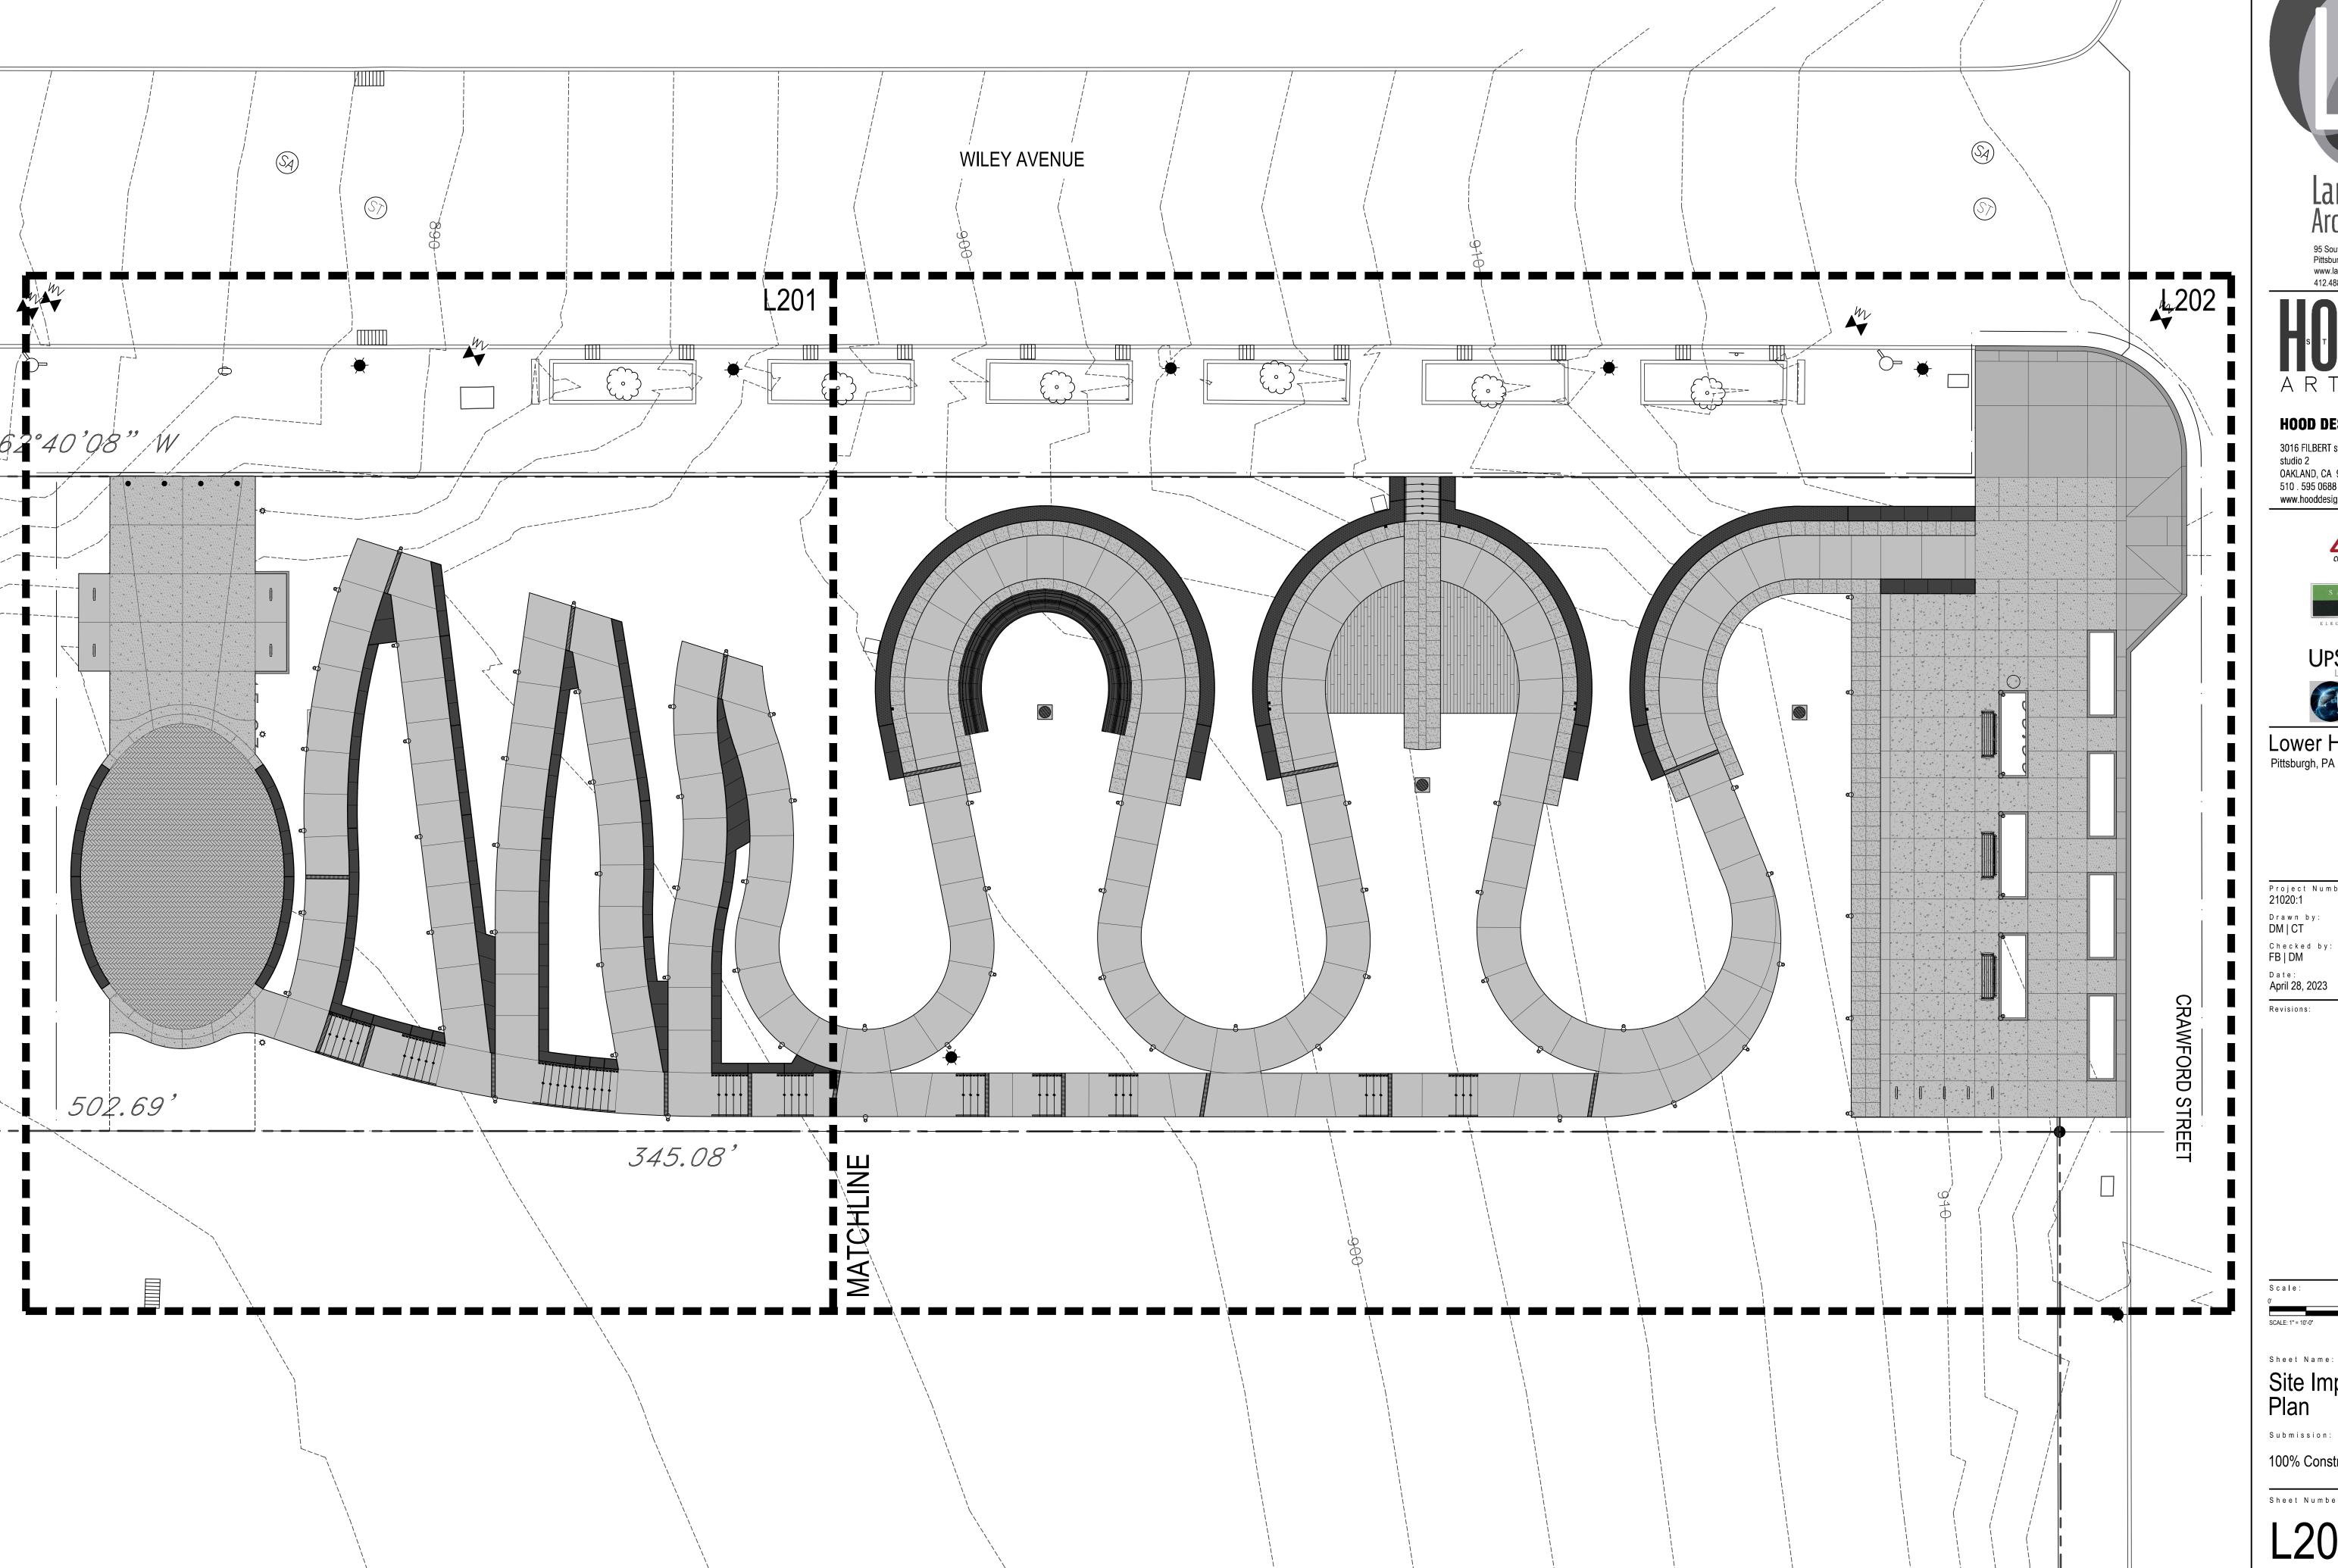L100







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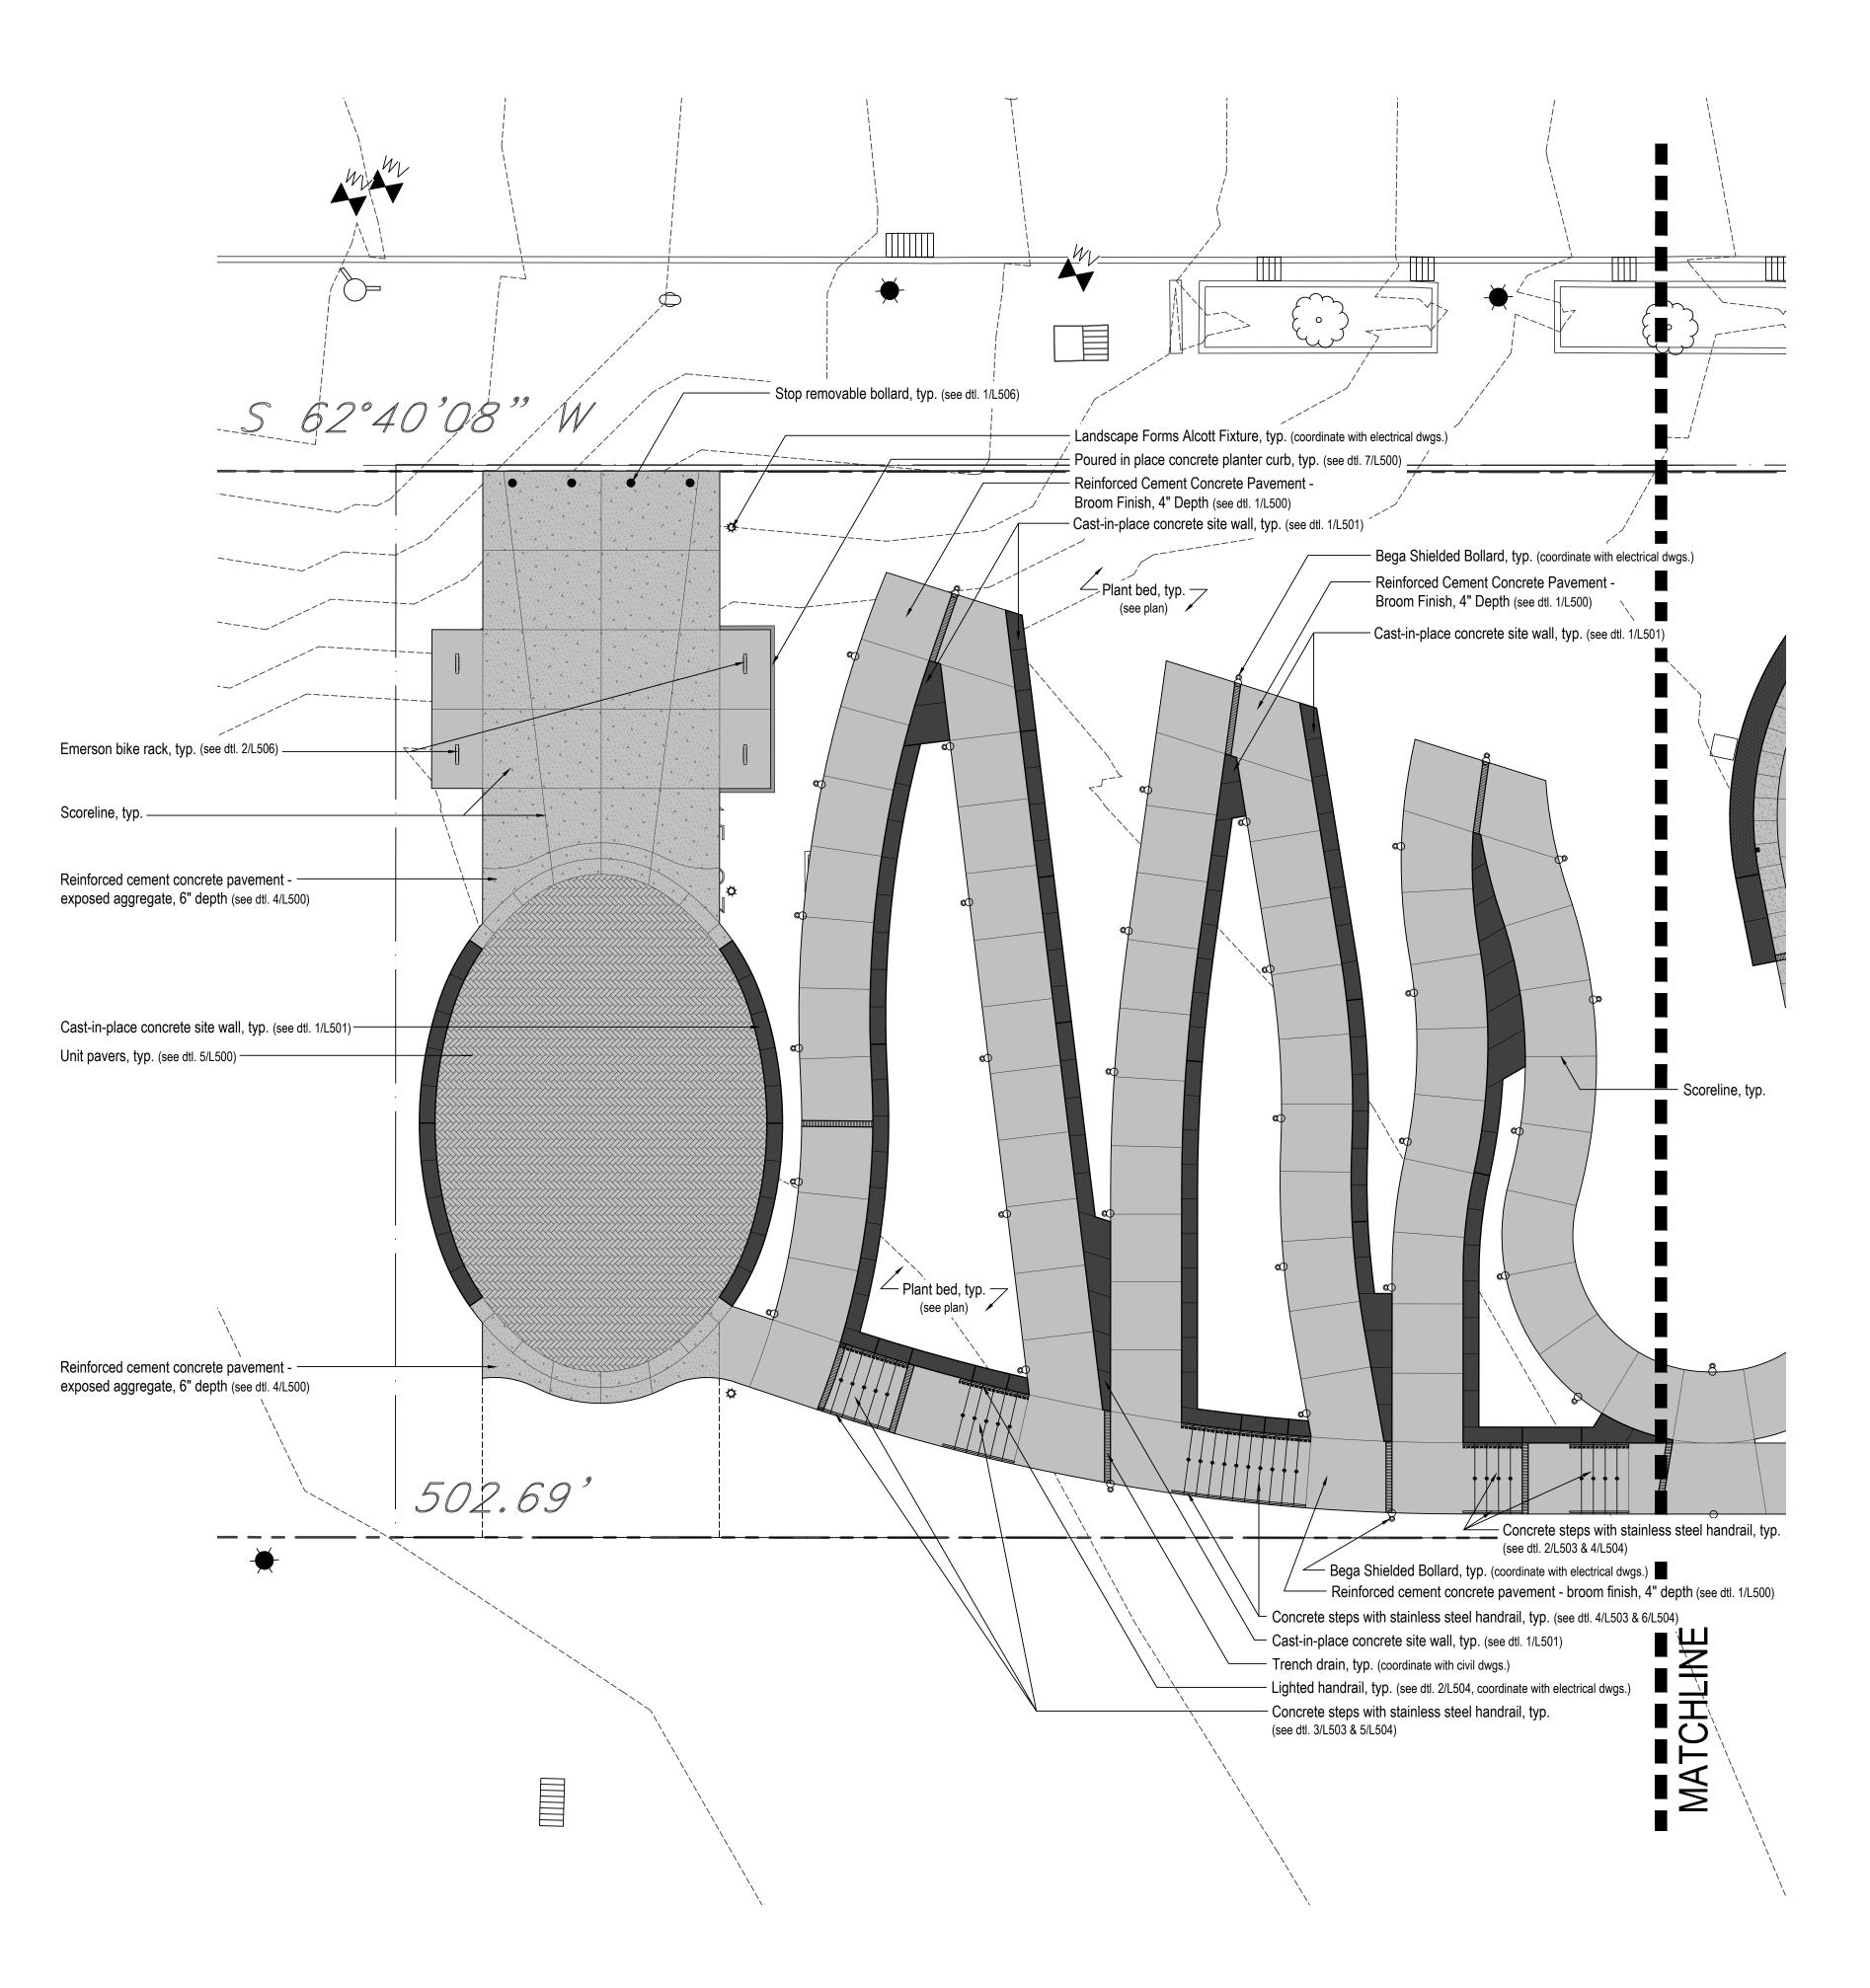
Sheet Name:

Site Improvements Plan

Submission:

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Sheet Number:





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Project Number: 21020:1

Drawn by: DM | CT

Checked by: FB | DM Date: April 28, 2023

Revisions:

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SCALE: 1' = 8'-0"

Sheet Name:


Site Improvements Plan

Submission:

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Sheet Number:

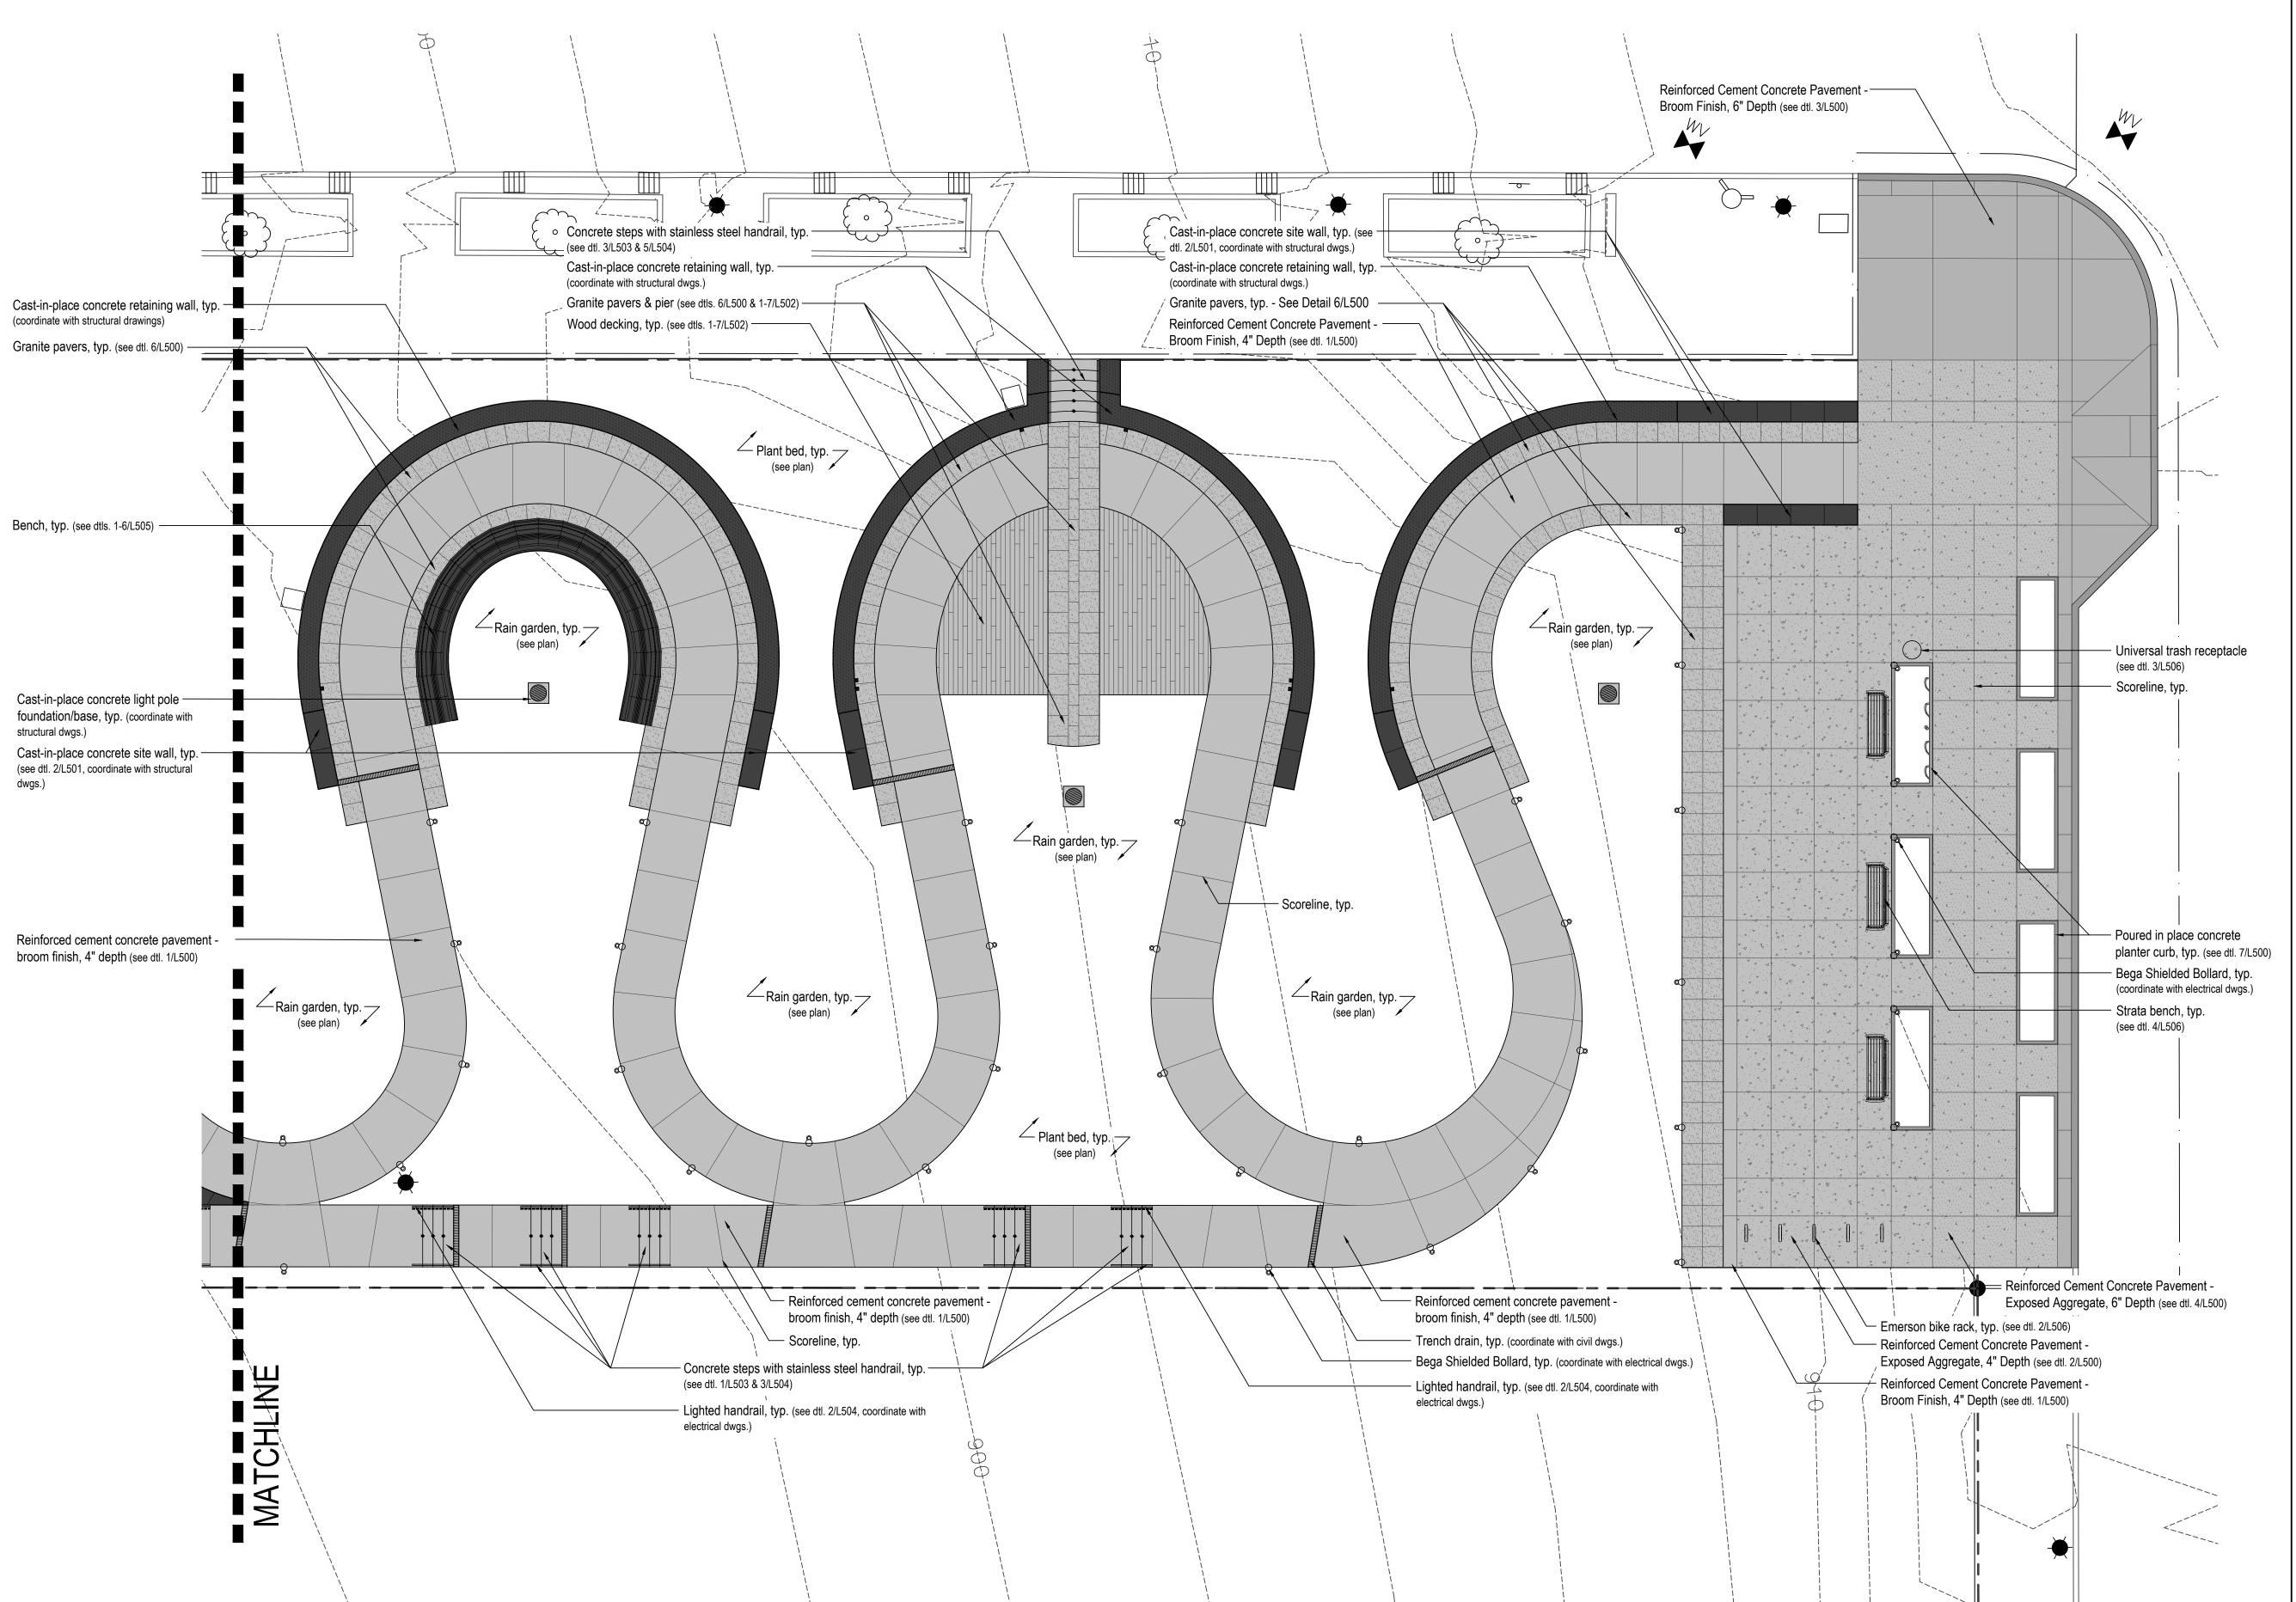L201





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Checked by:

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Date:
April 28, 2023
Revisions:

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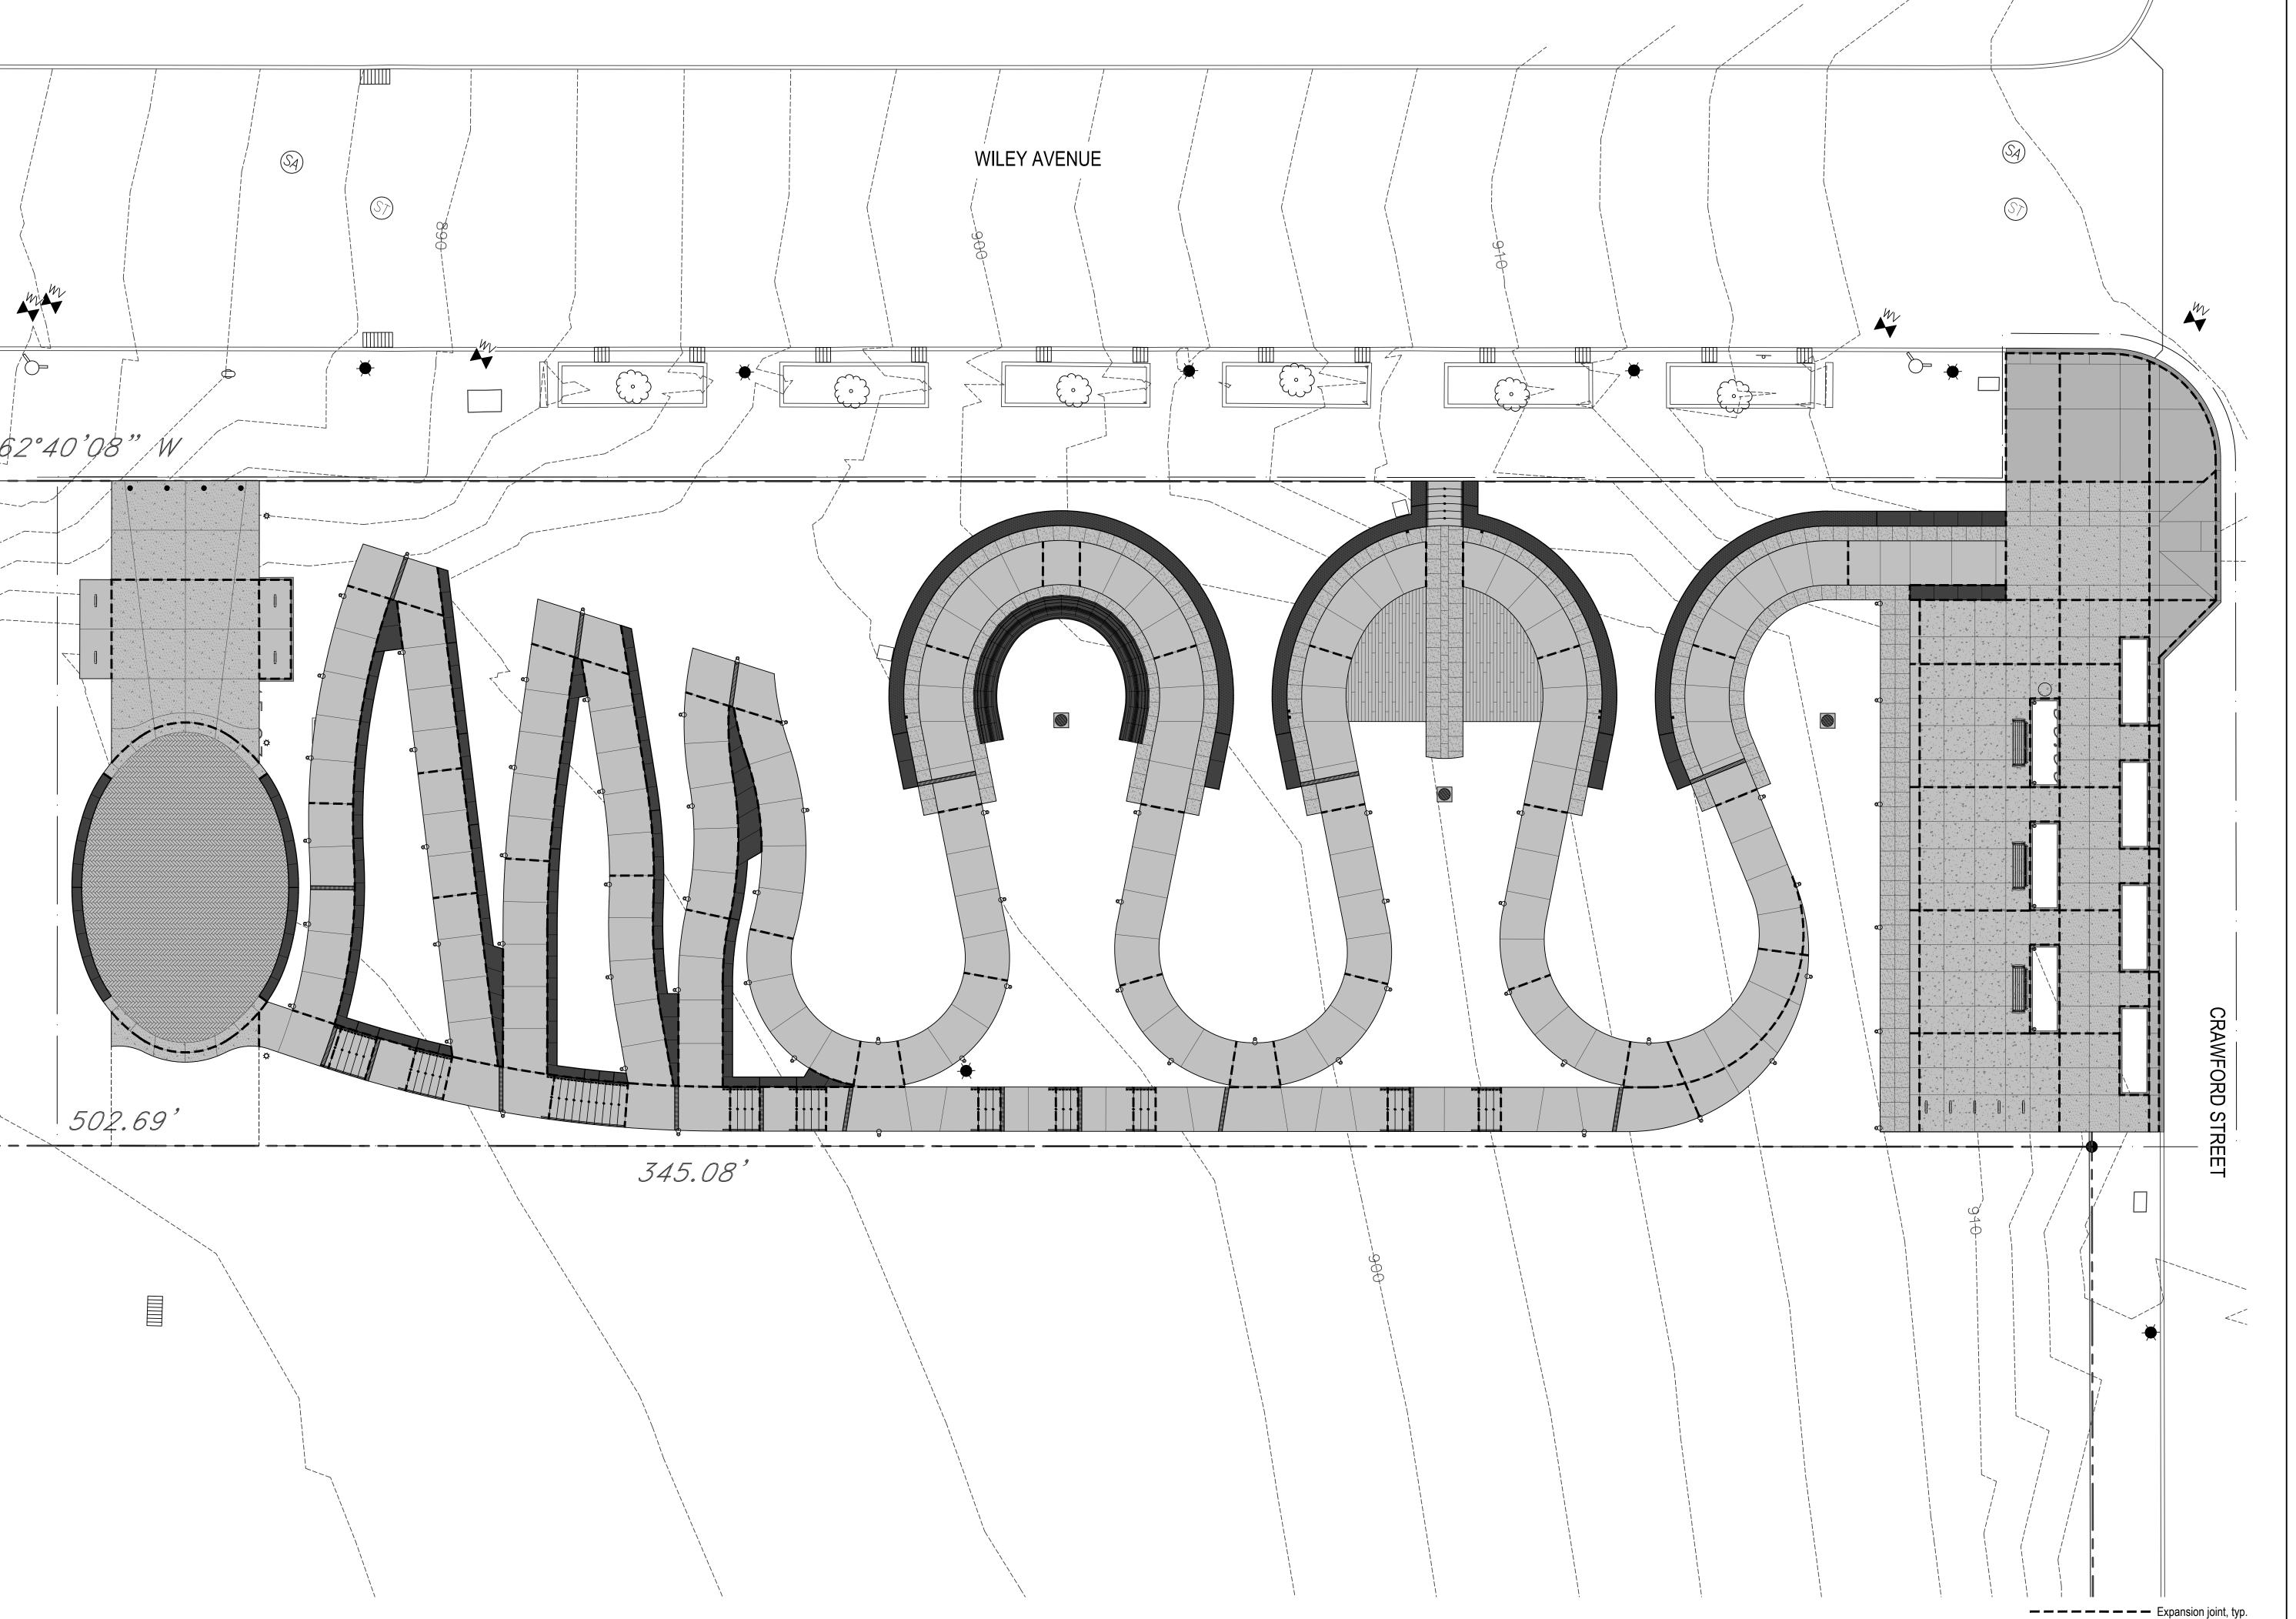
Site Improvements Plan

Submission:

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Sheet Number:

L202





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Project Number: 21020:1

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April 28, 20

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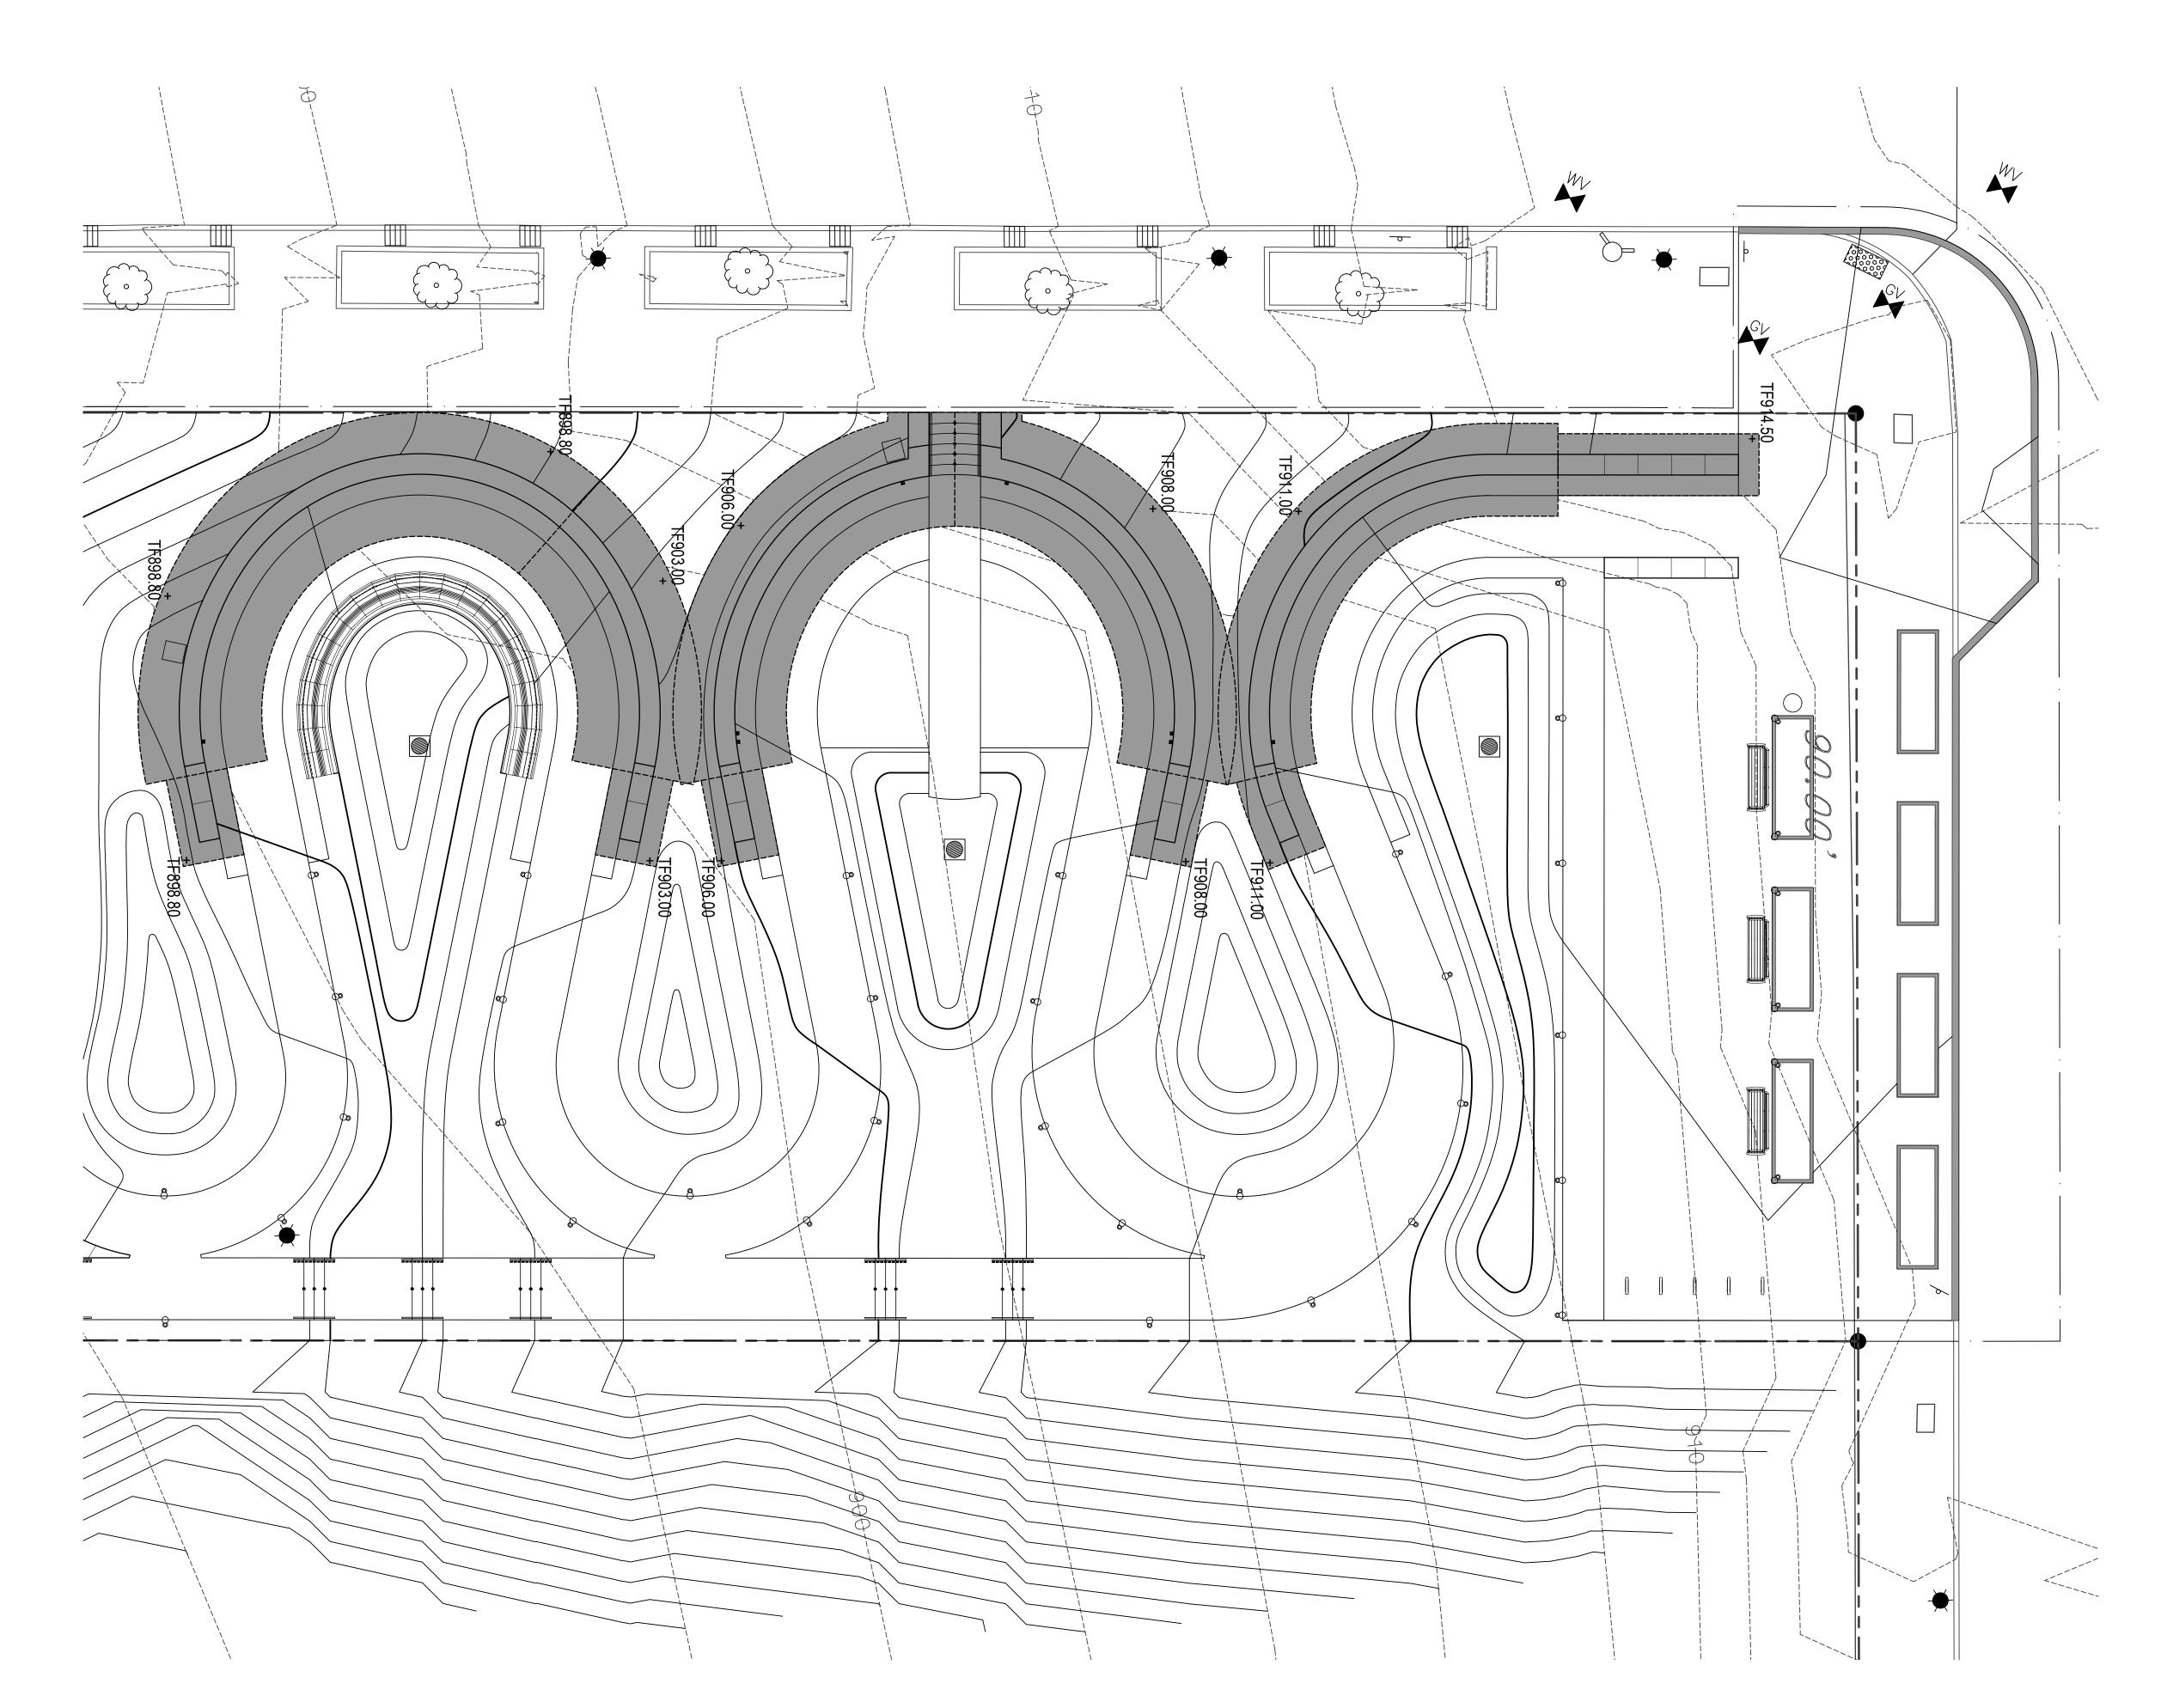
Site Improvements Plan - Expansion Joints

Submission:

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Sheet Number:

_203





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Date: **April 28, 2023**

Revisions:

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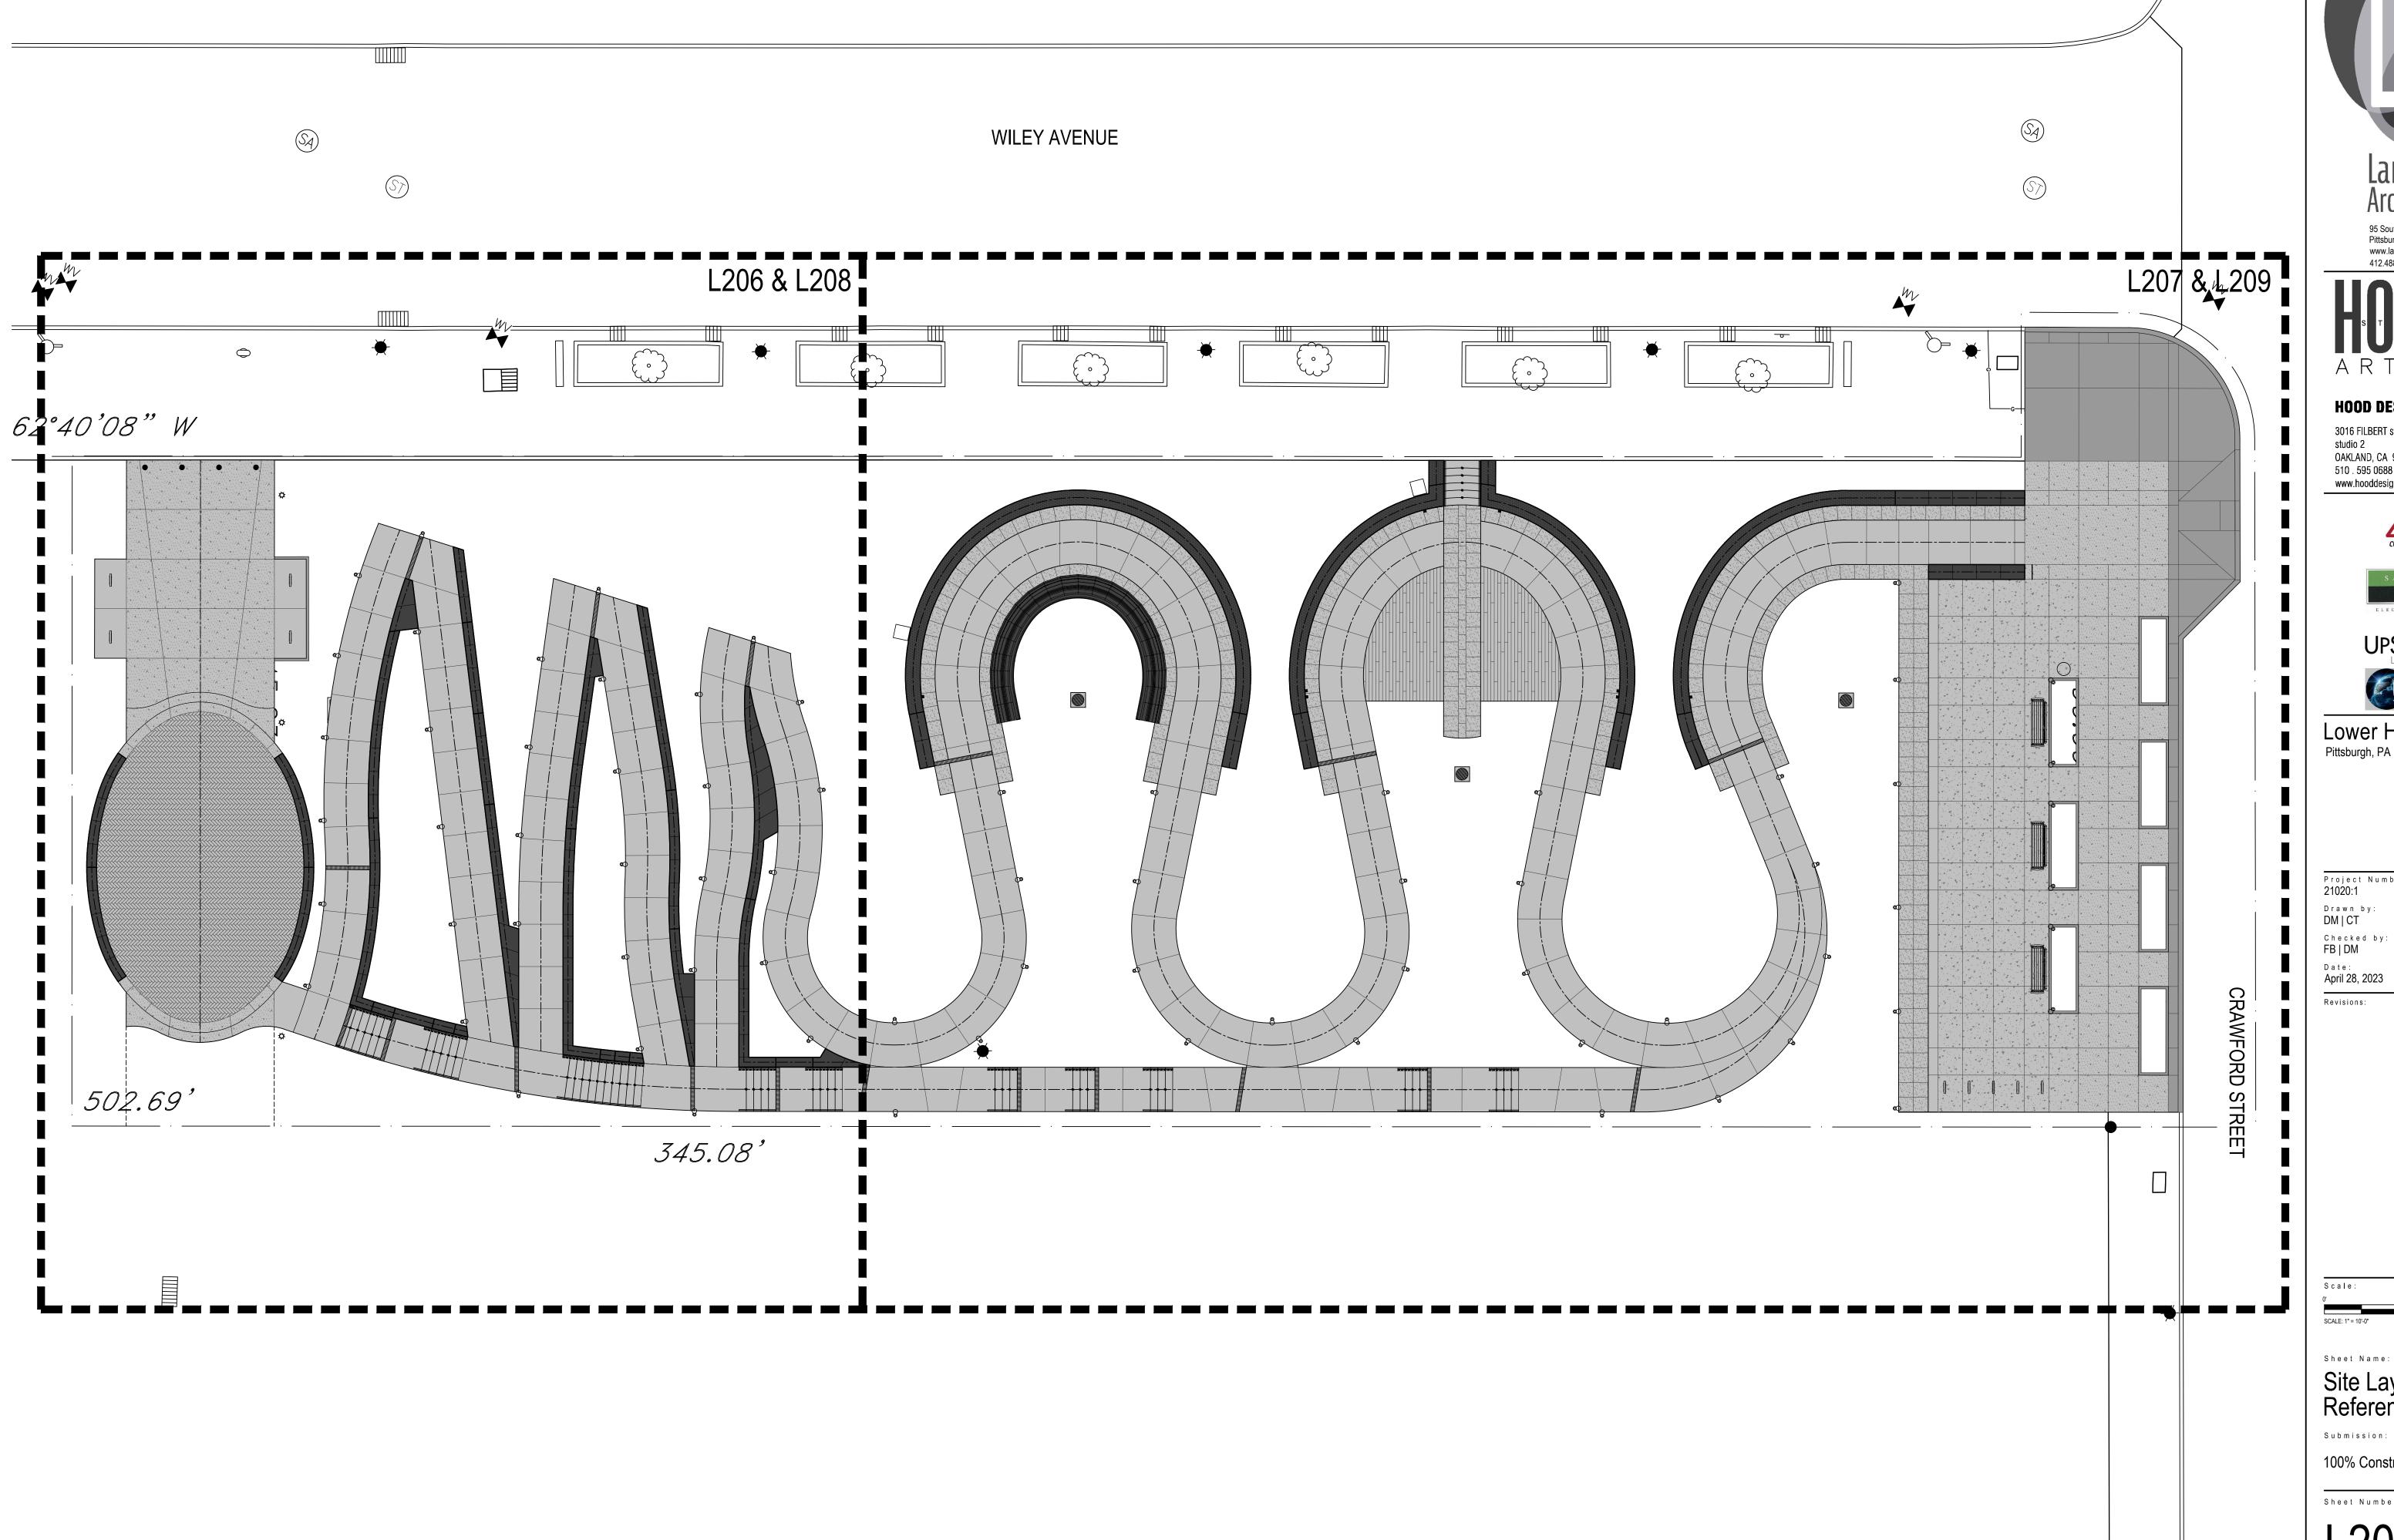
Site Curtain Wall Footer Plan

Submission:

100% Construction Documents

Sheet Number:

L204







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Project Number:

Drawn by: DM | CT

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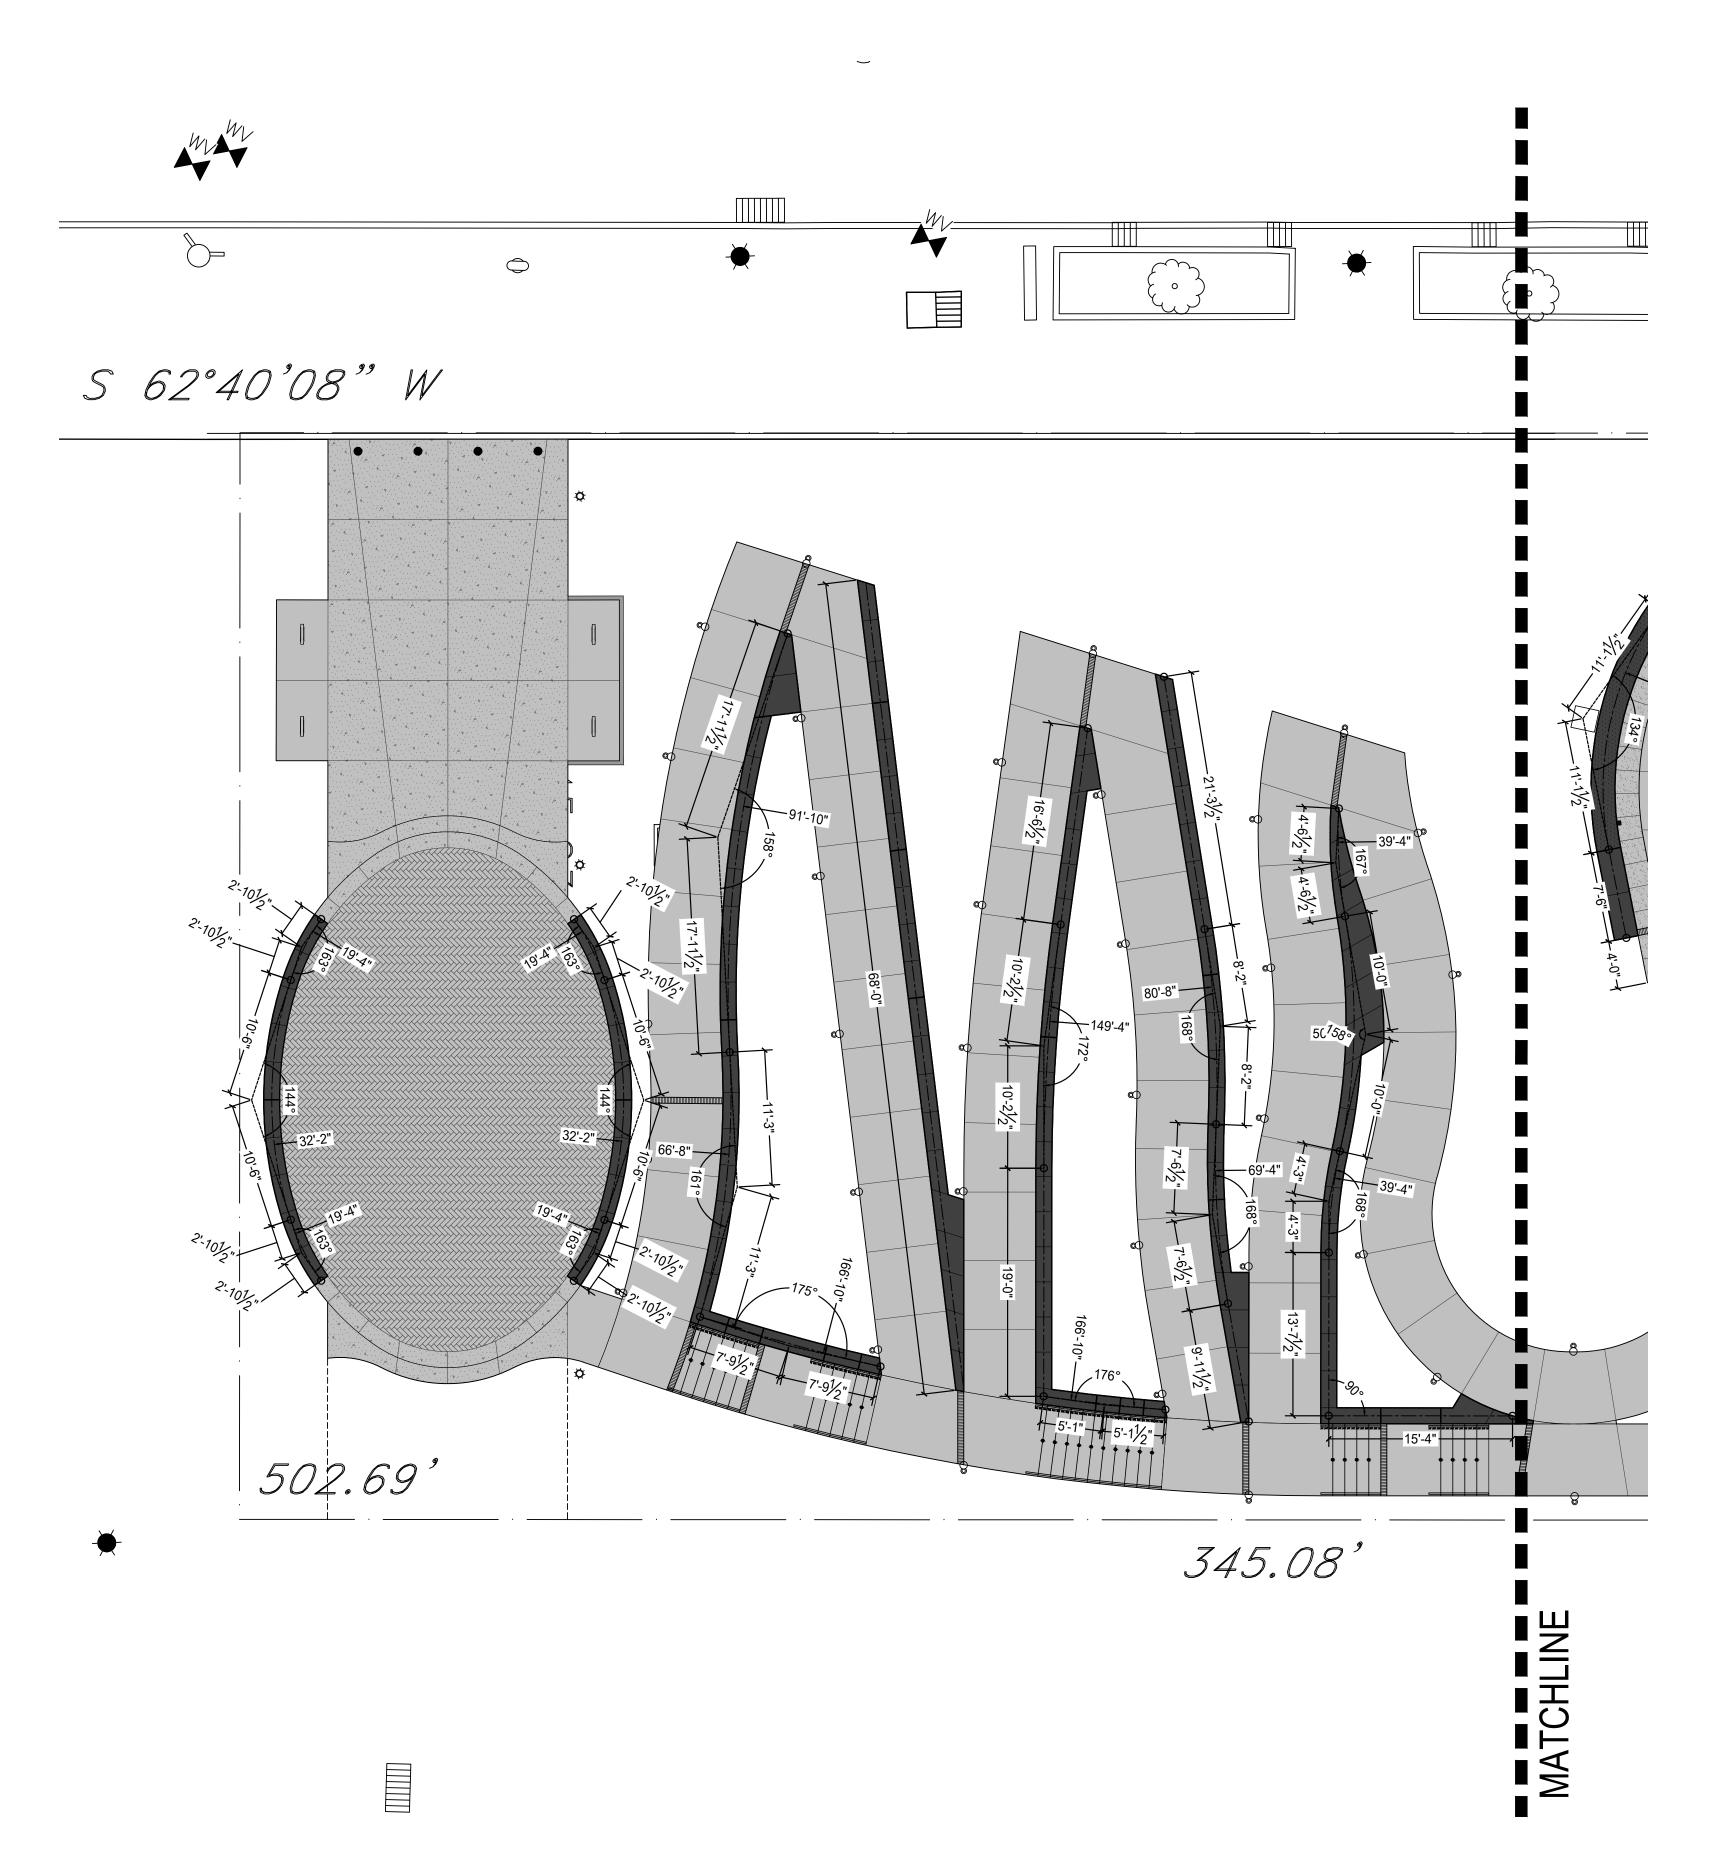
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Site Layout Reference Plan

Submission:

100% Construction Documents

Sheet Number:







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Date: **April 28, 2023** Revisions:


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Site Layout Plan -Walls

Submission:

100% Construction Documents

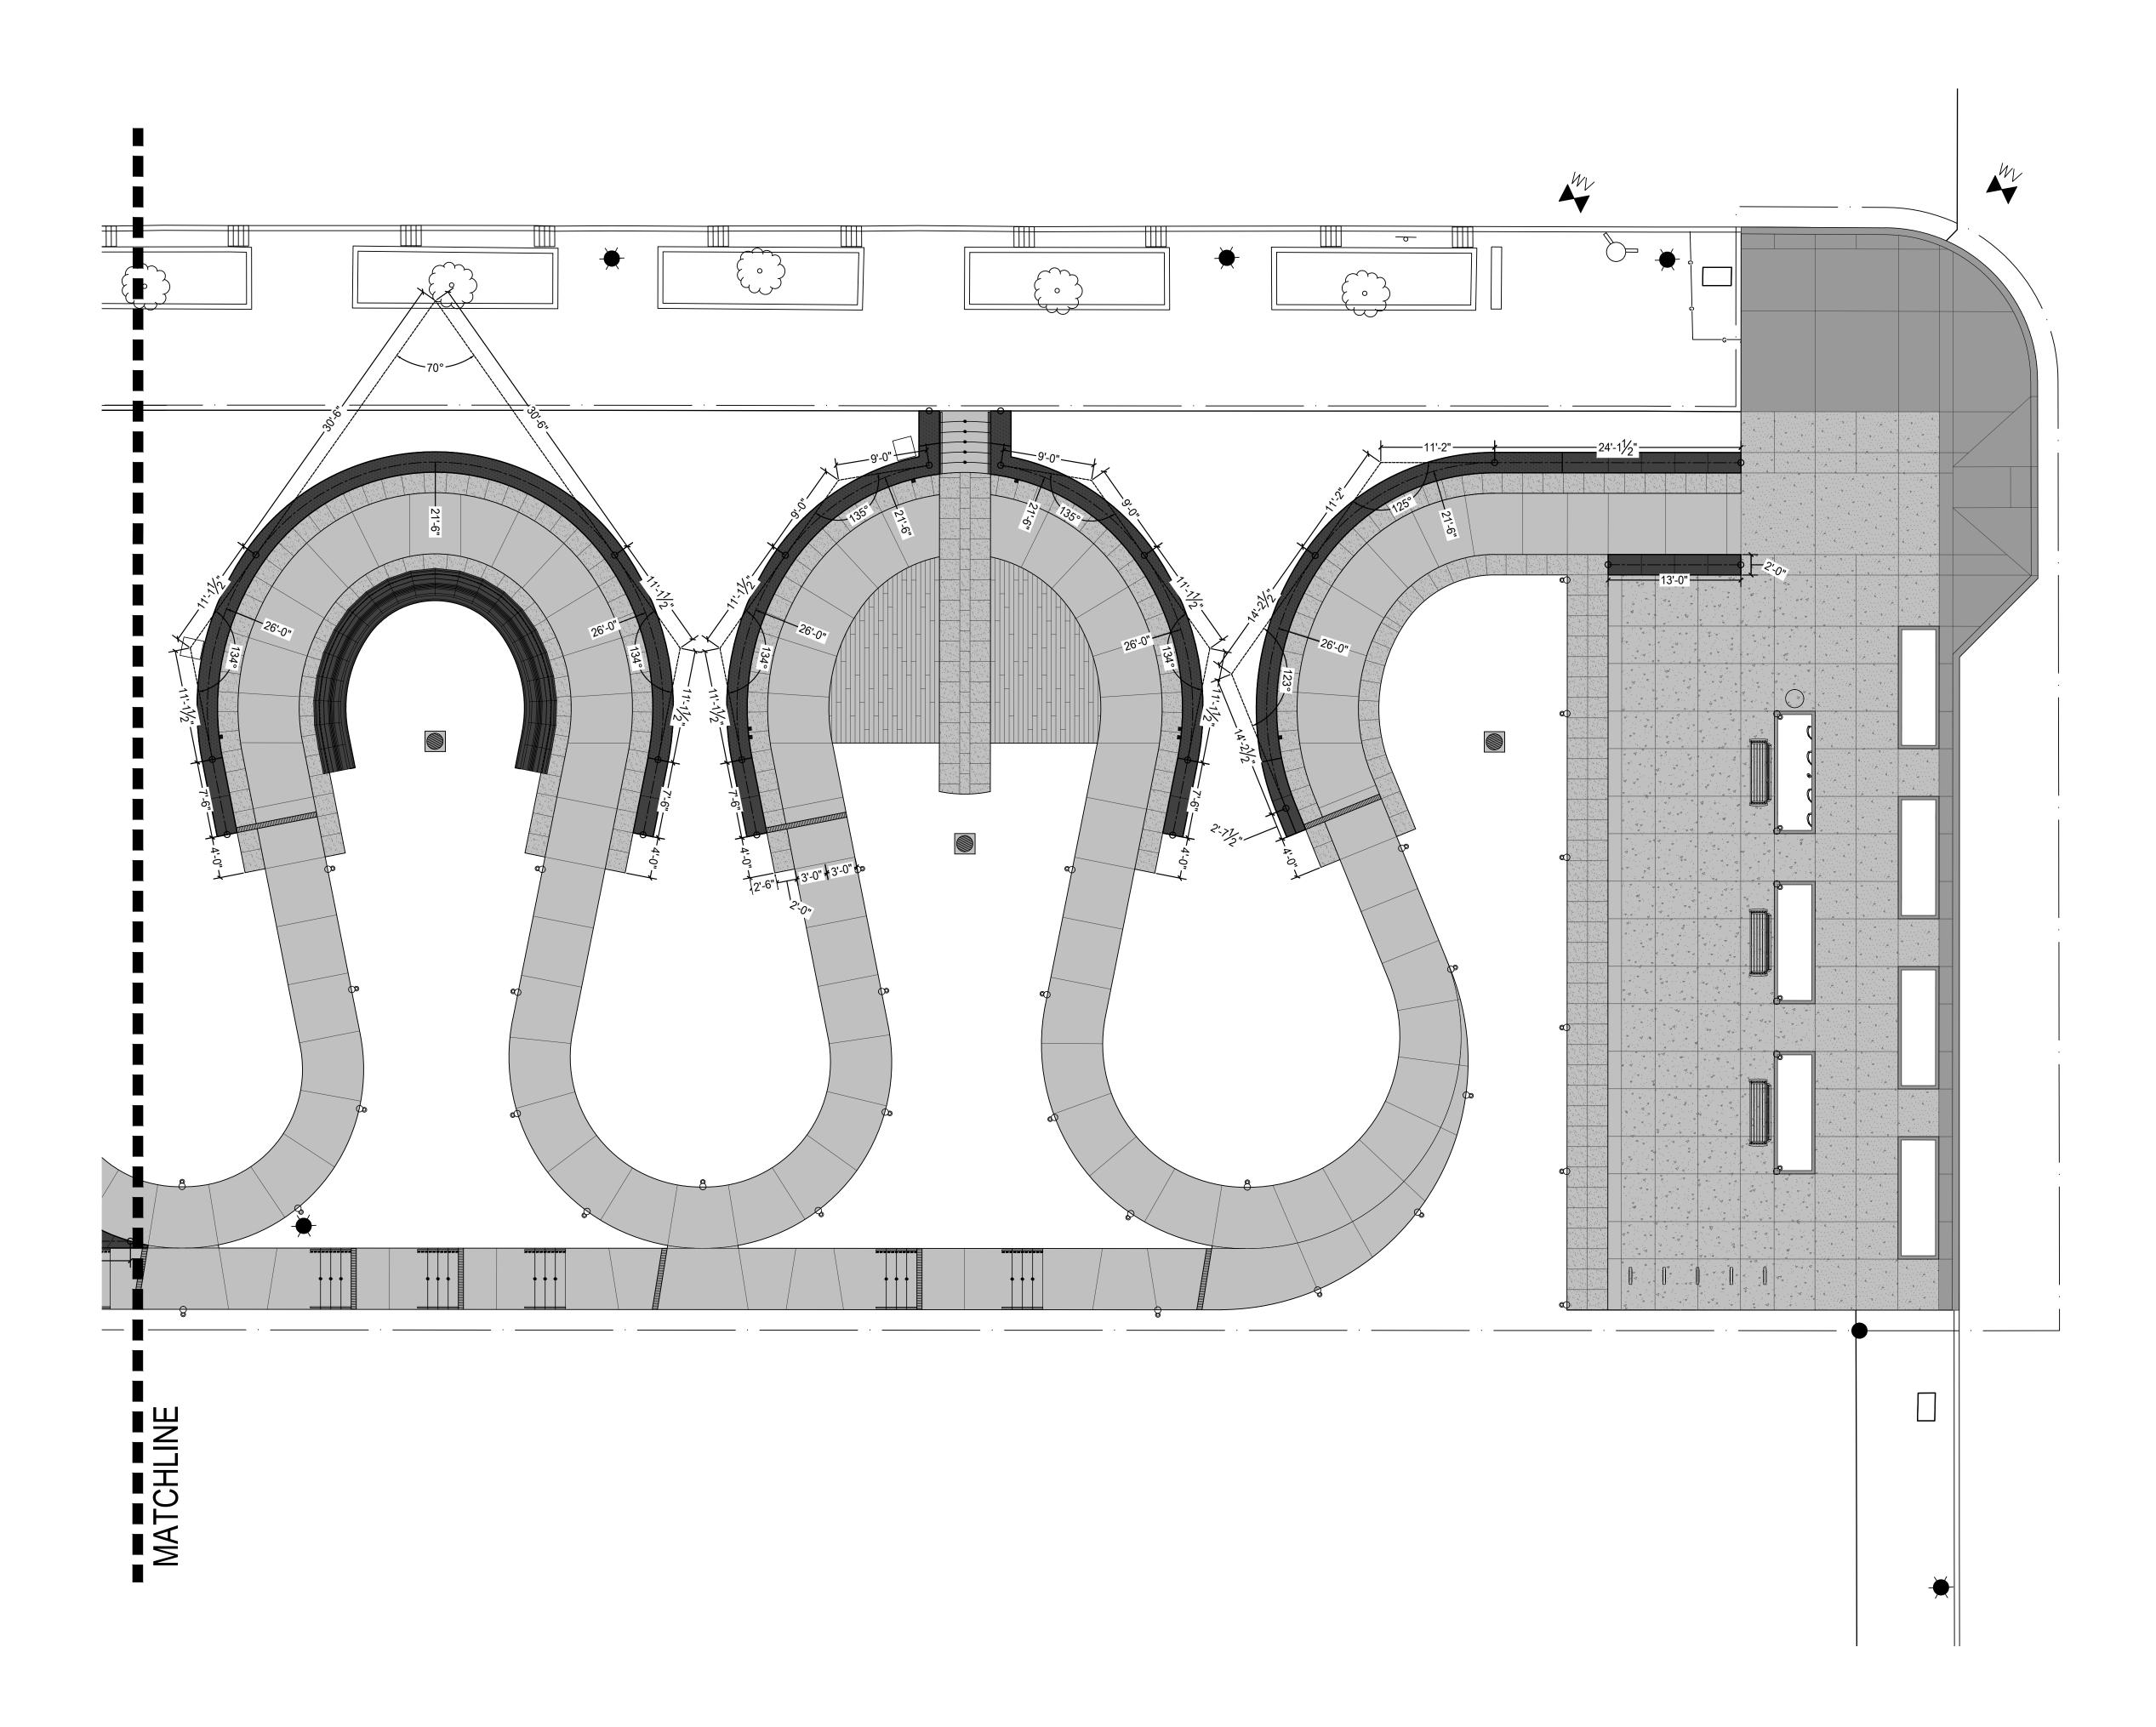Sheet Number:





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Revisions:


Sheet Name:

Site Layout Plan -Walls

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Date: **April 28, 2023**

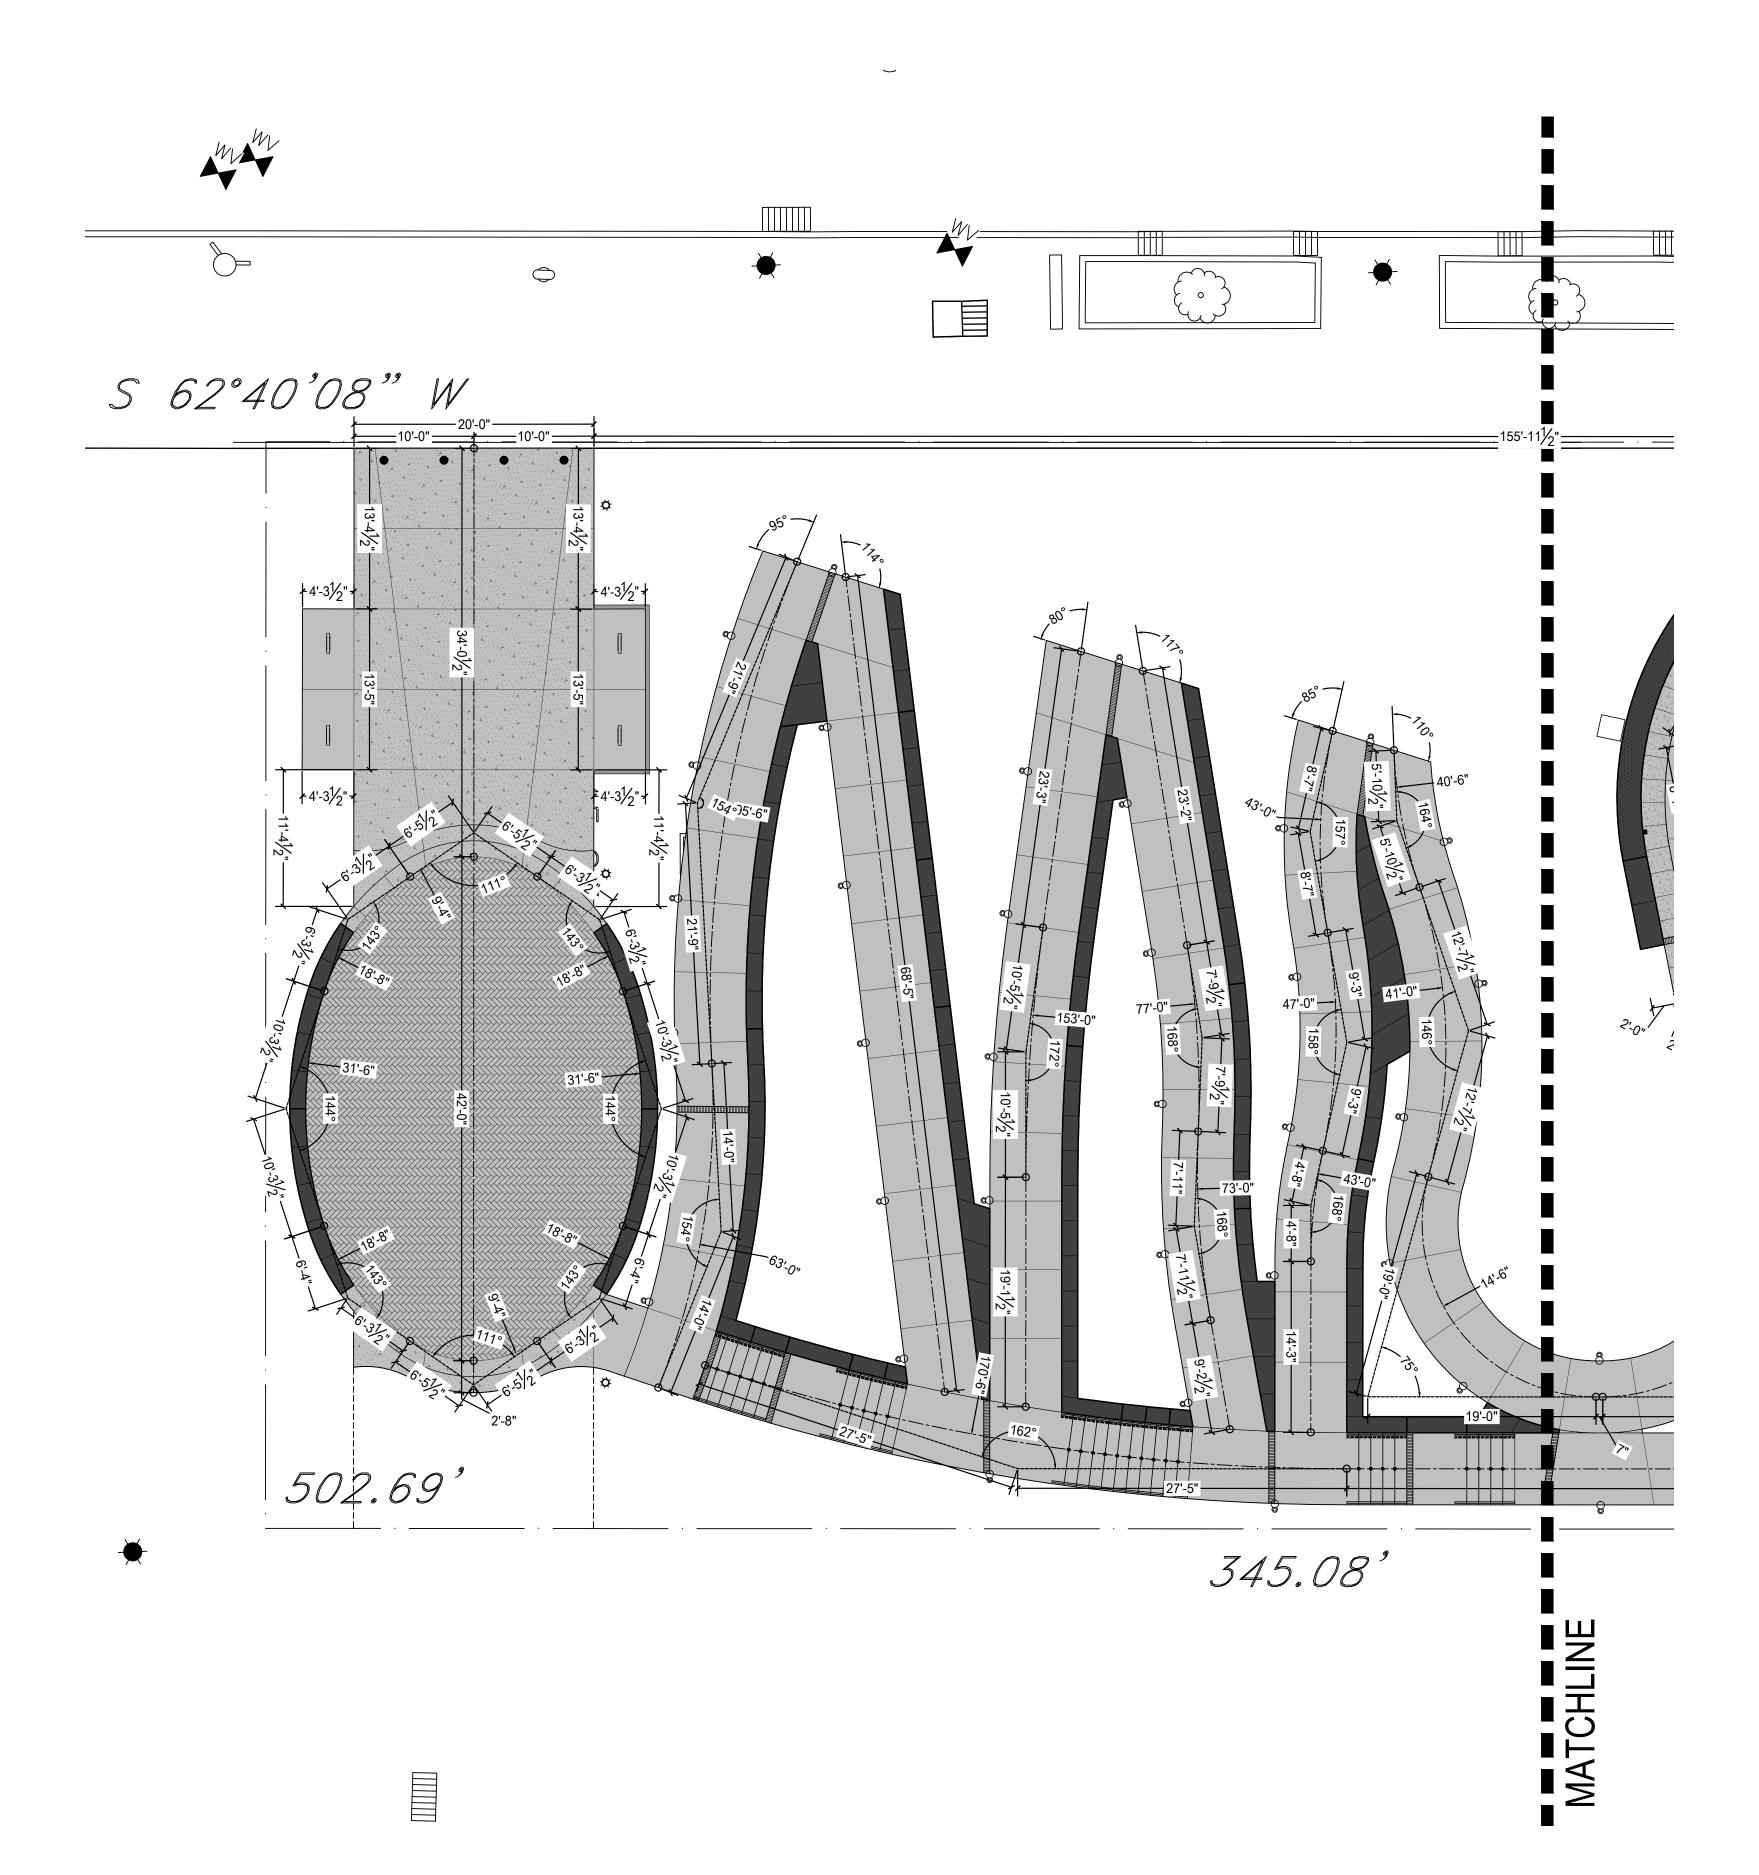Revisions:

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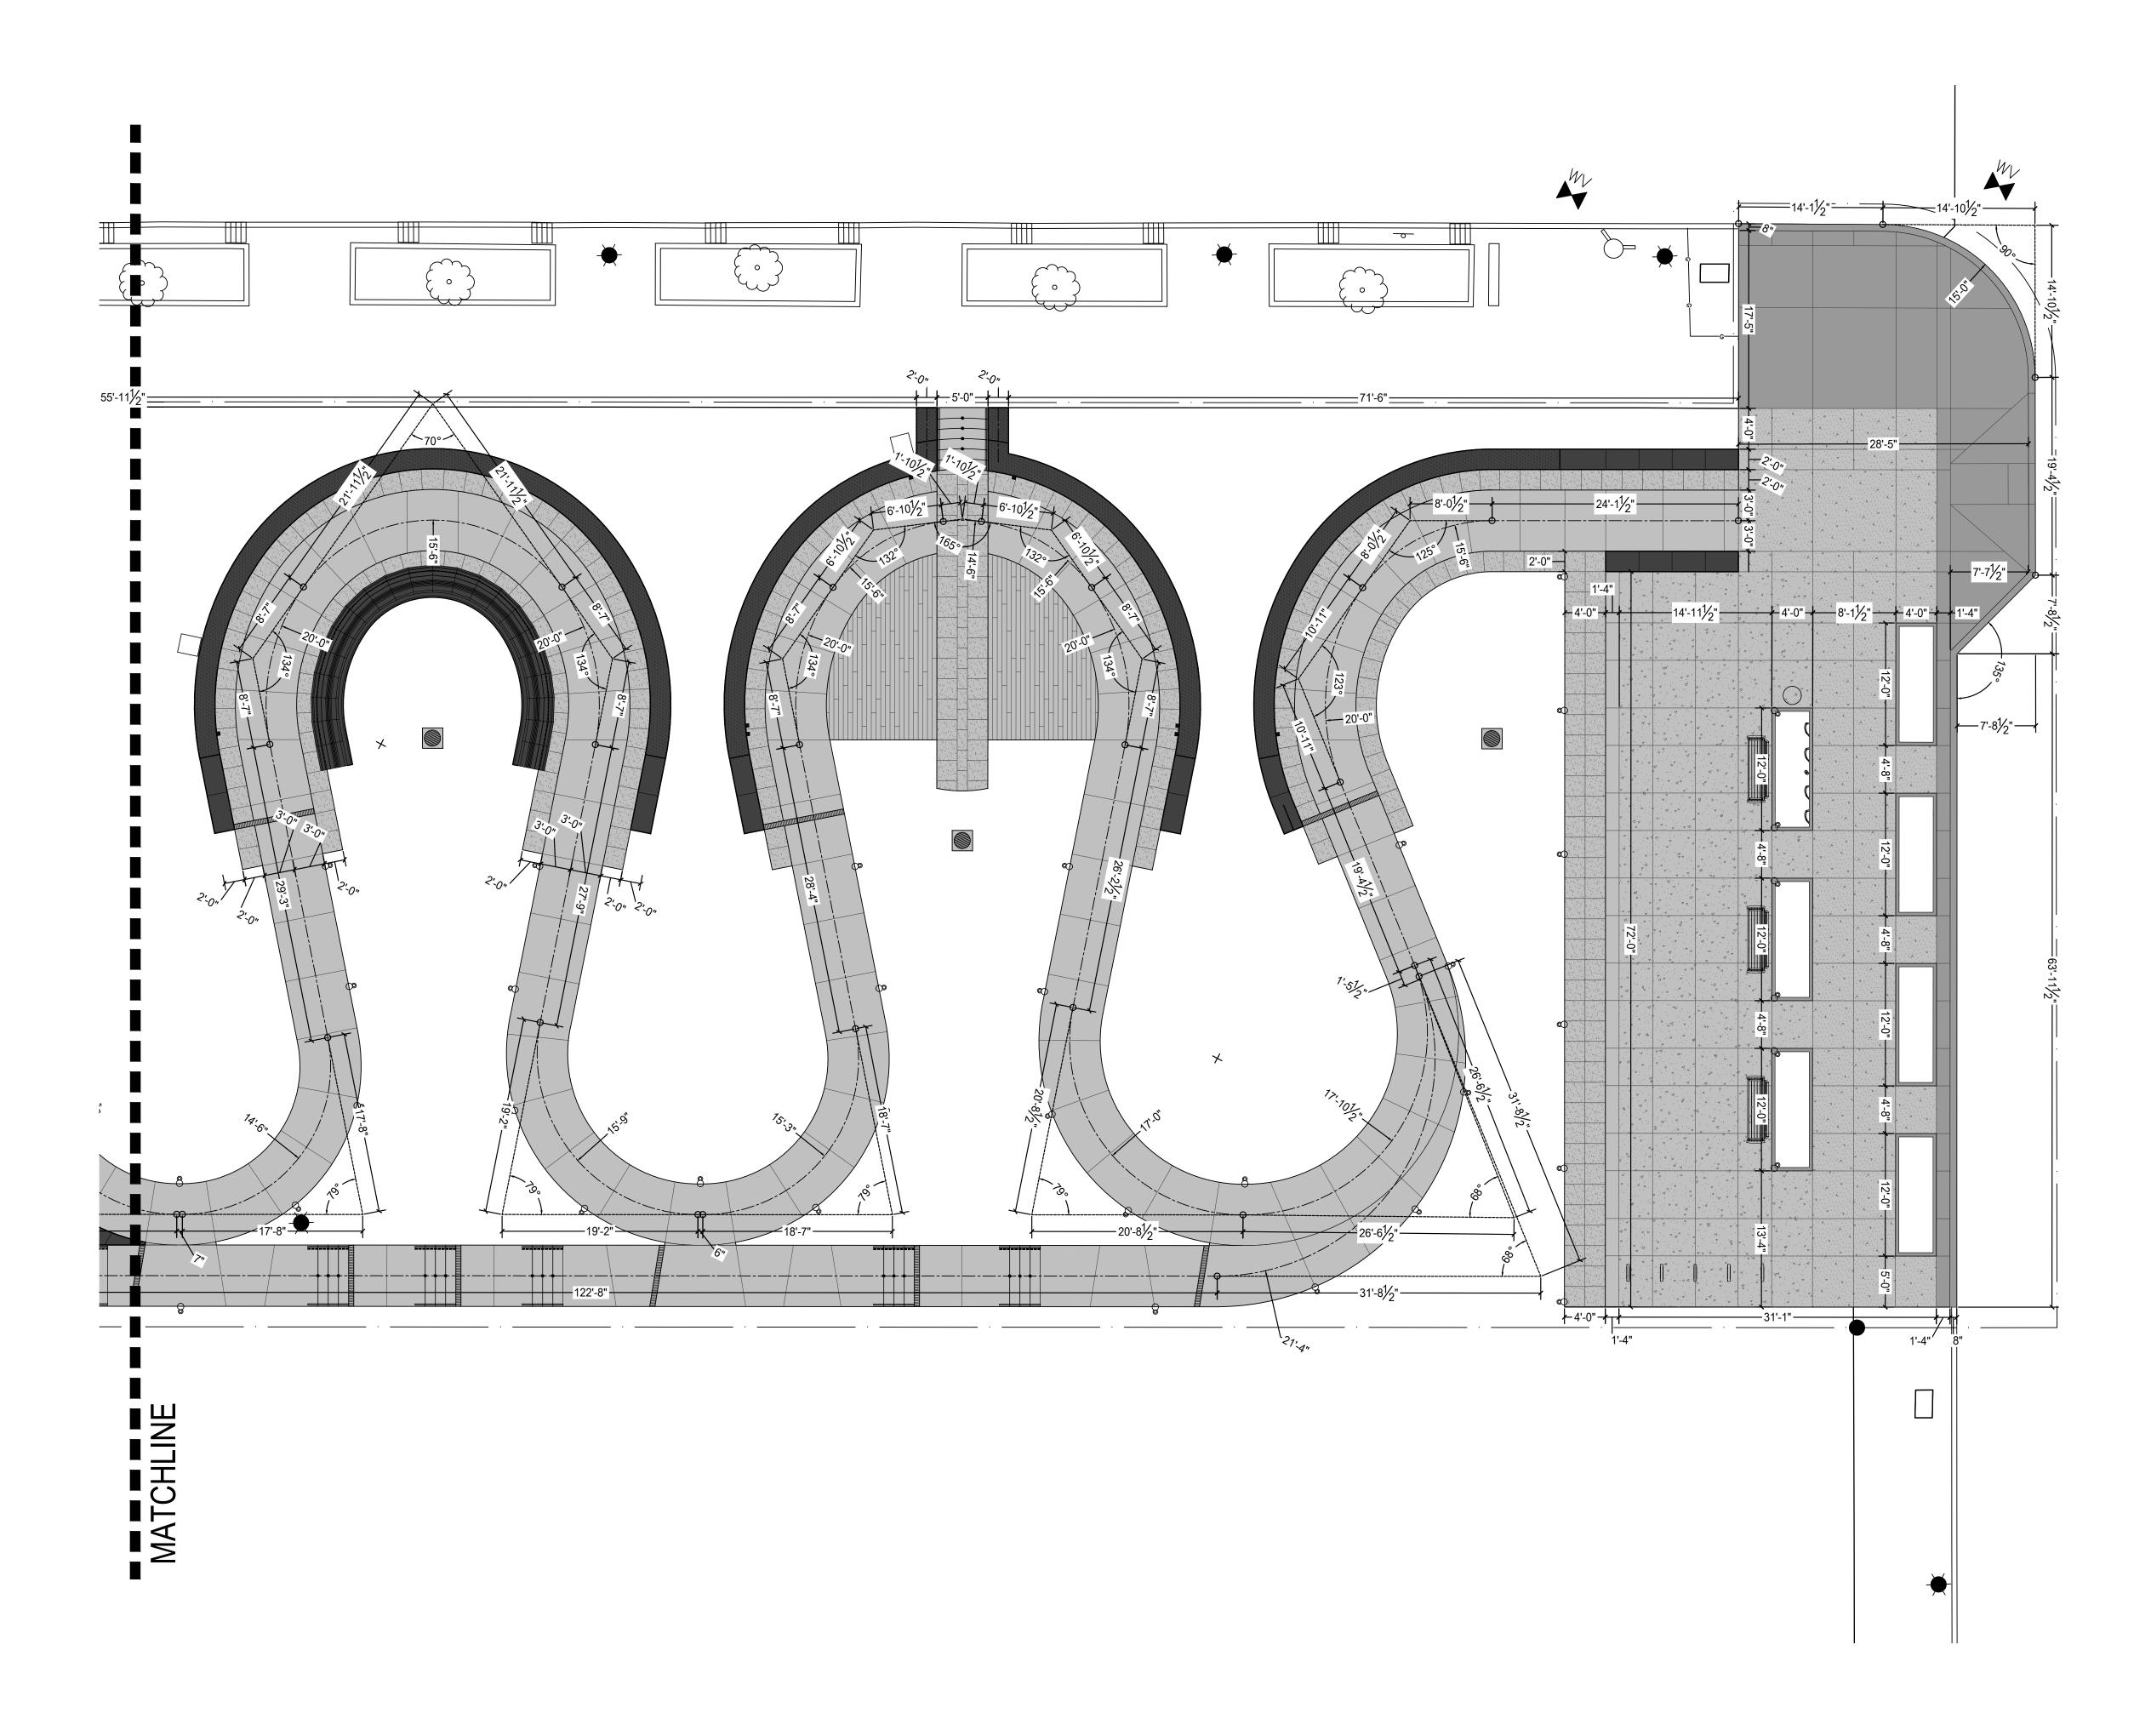
Site Layout Plan -Hardscape

Submission:

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Sheet Number:

L208





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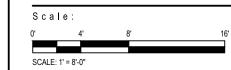
Lower Hill-Curtain Call
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Project Number: 21020:1

Drawn by: DM | CT

Checked by: FB | DM Date: April 28, 2023

Revisions:



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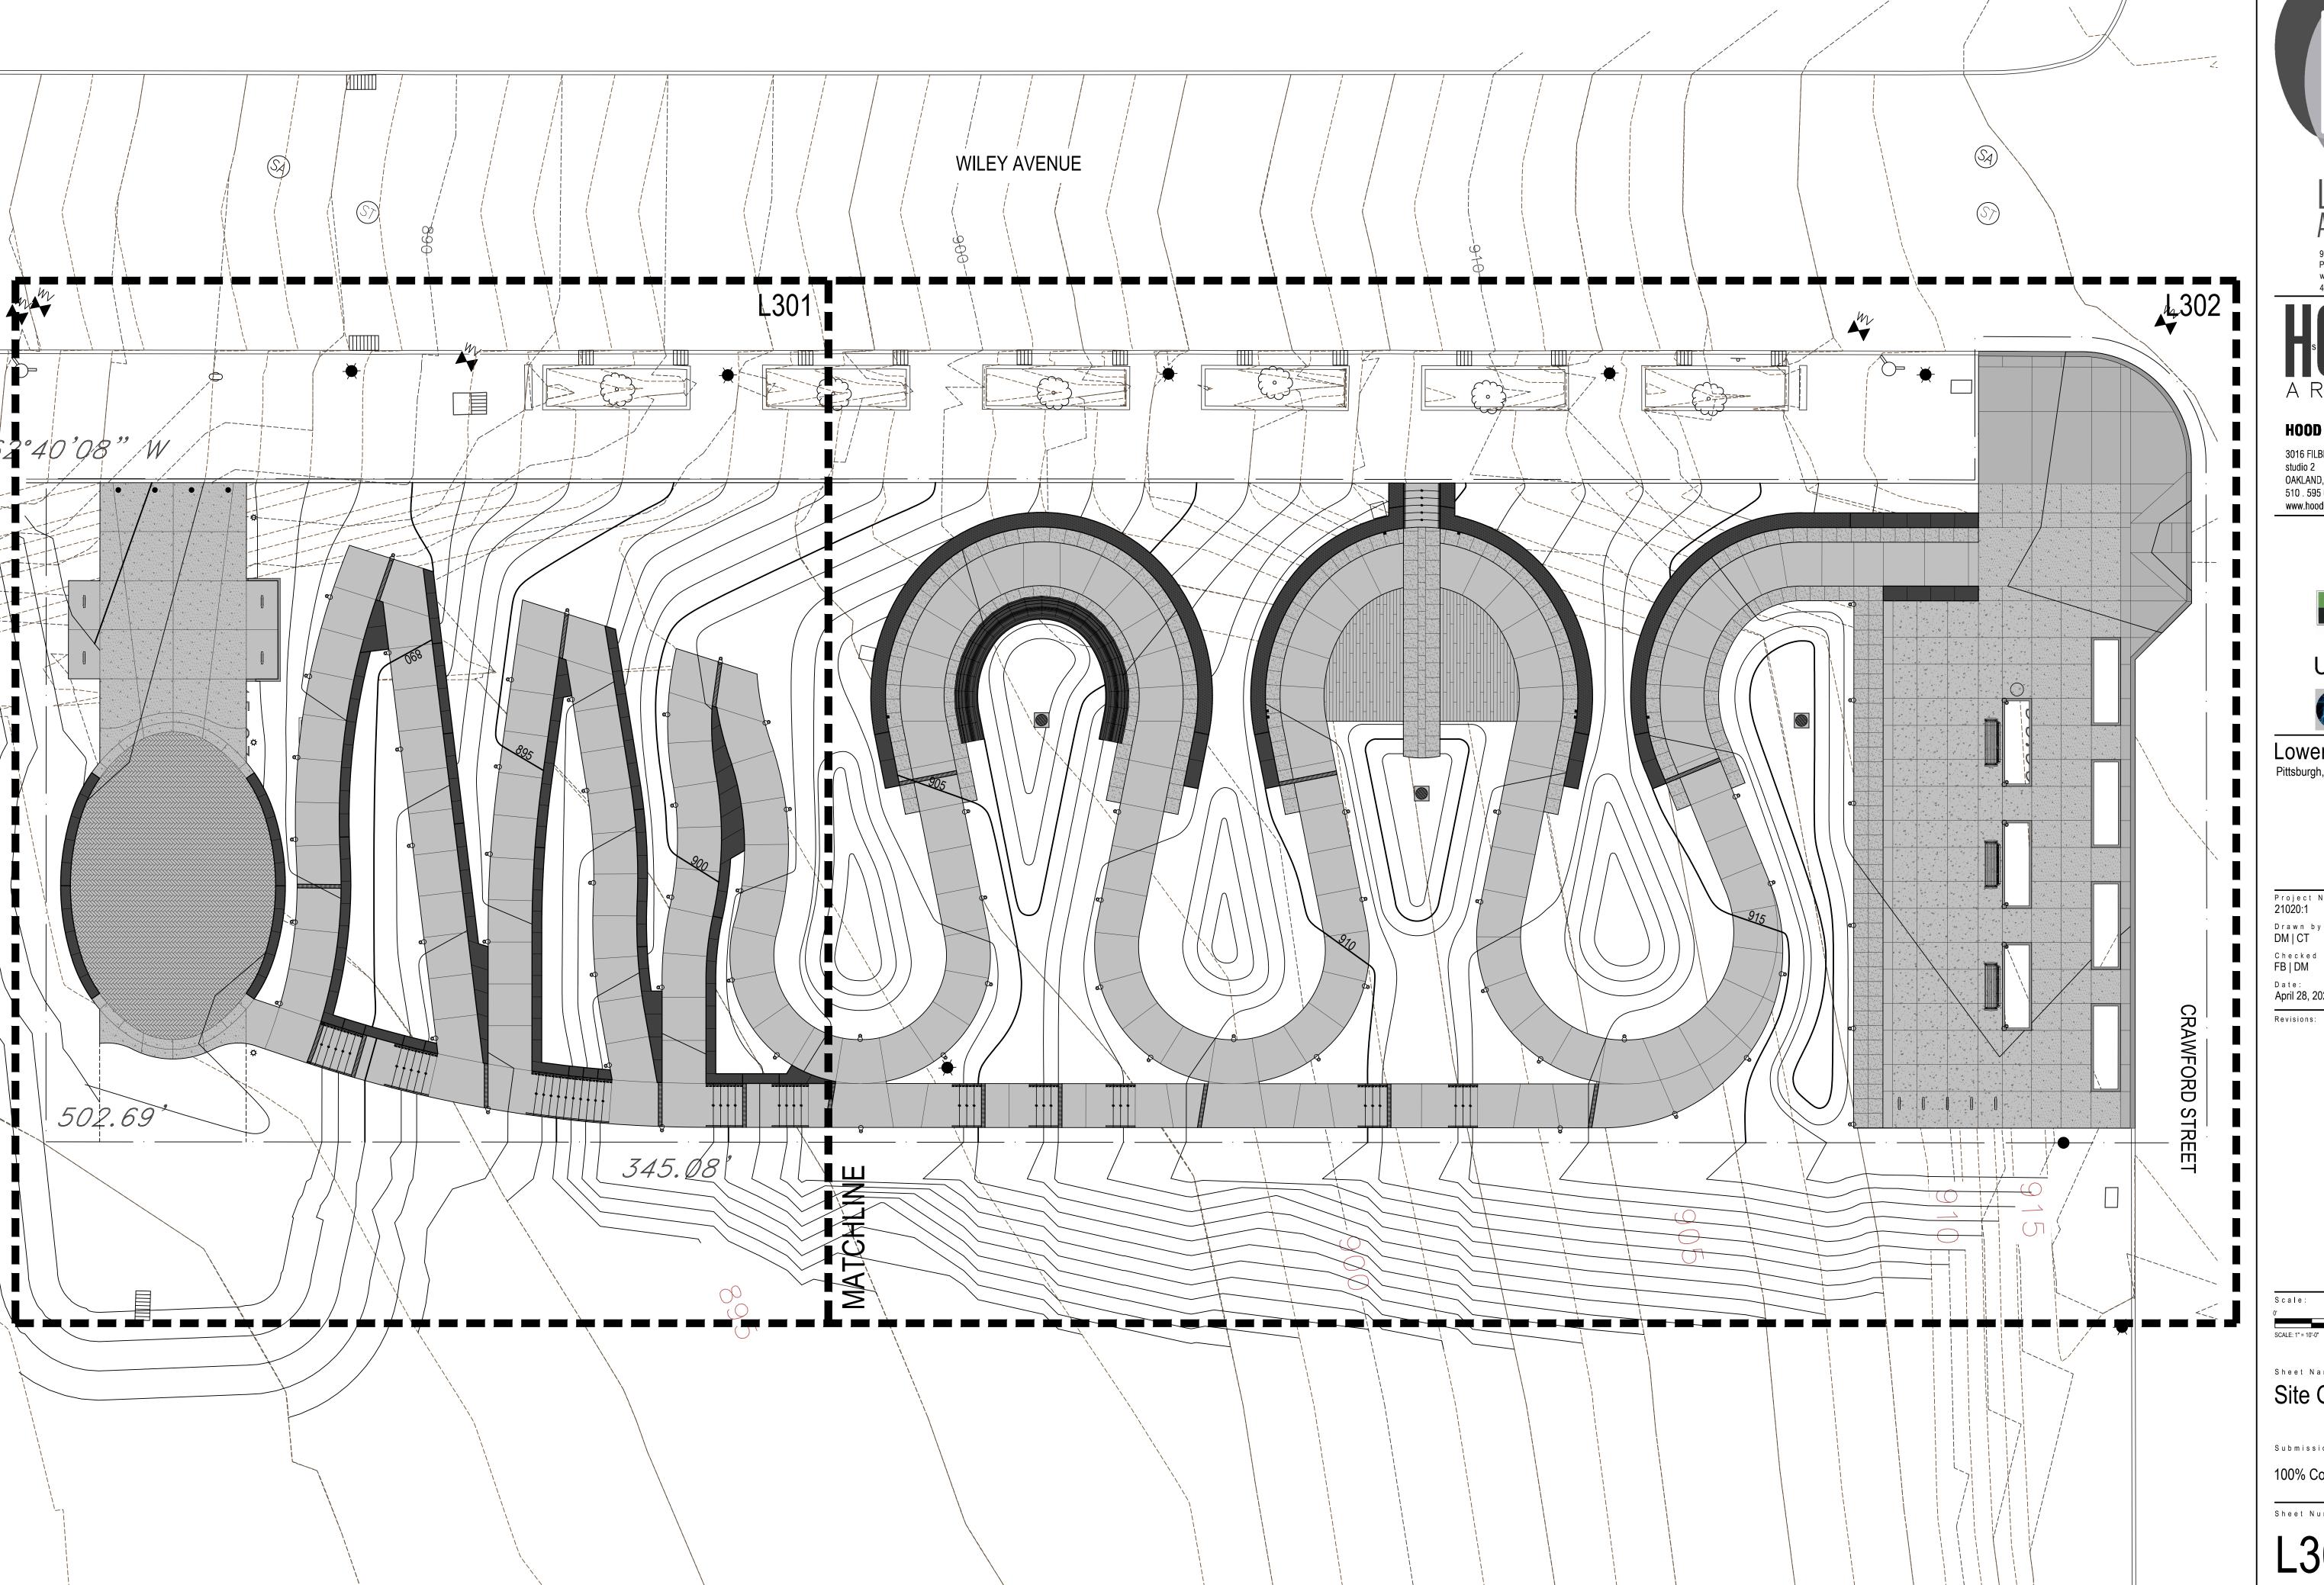
Site Layout Plan -Hardscape

Submission:

100% Construction Documents

Sheet Number:

L209







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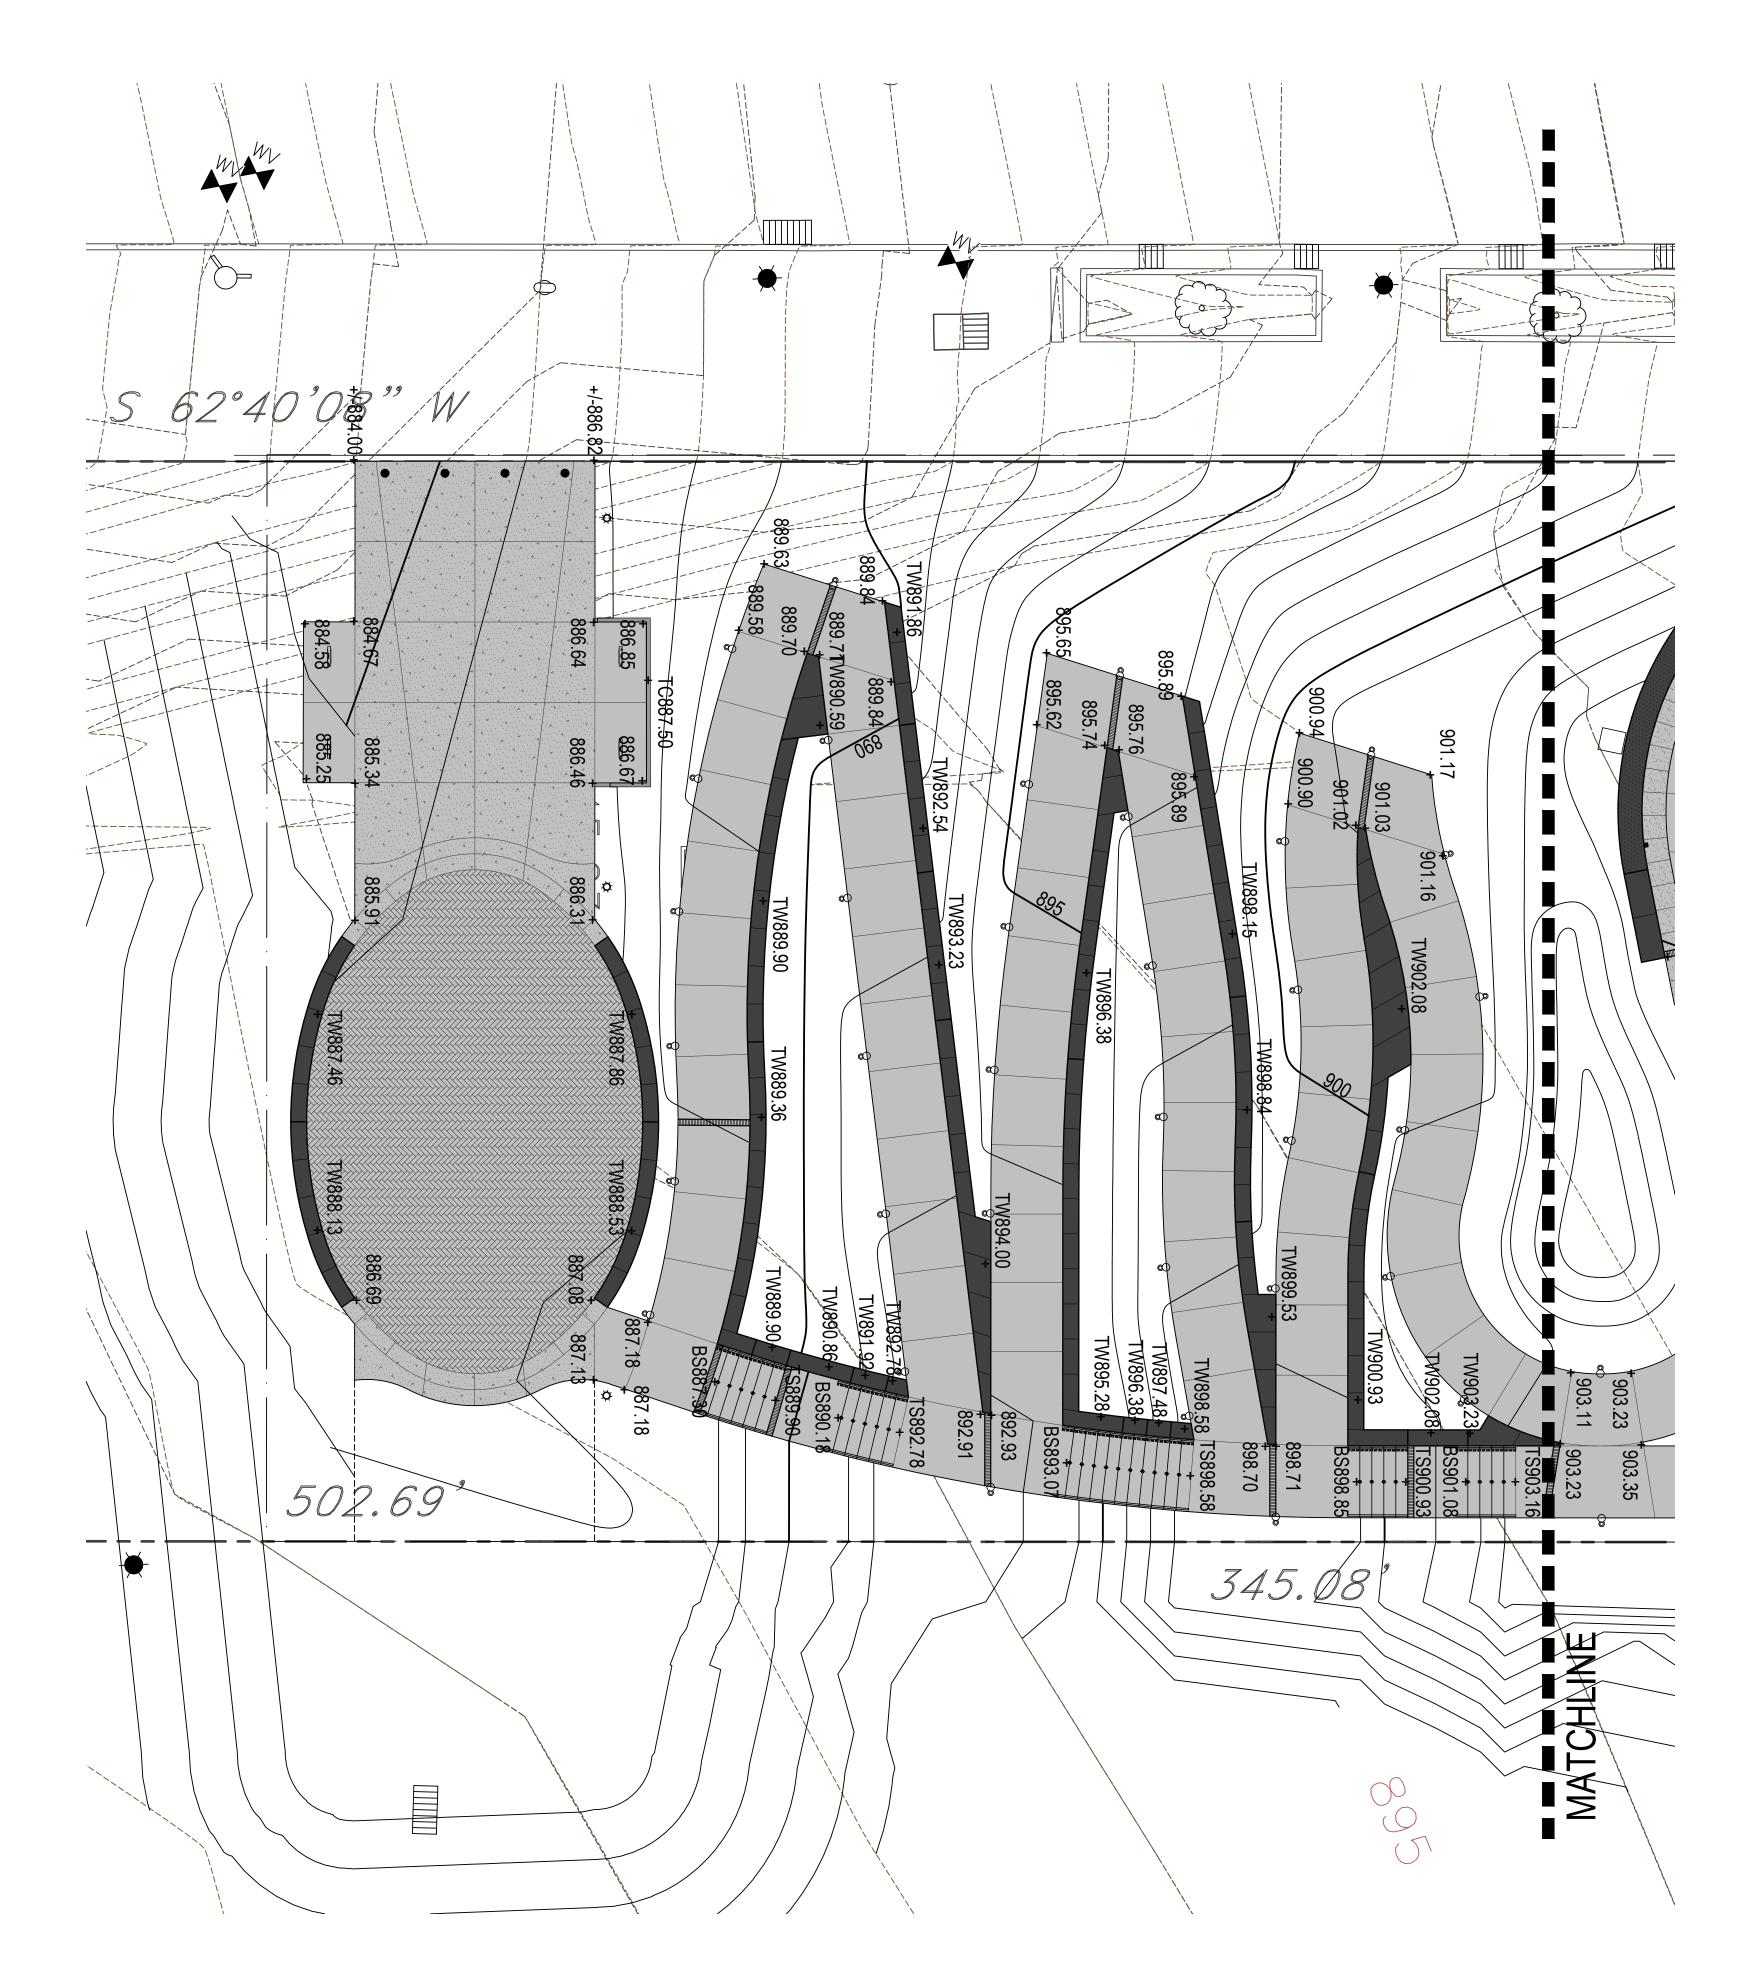
Sheet Name:

Site Grading Plan

Submission:

100% Construction Documents

Sheet Number:







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Revisions:

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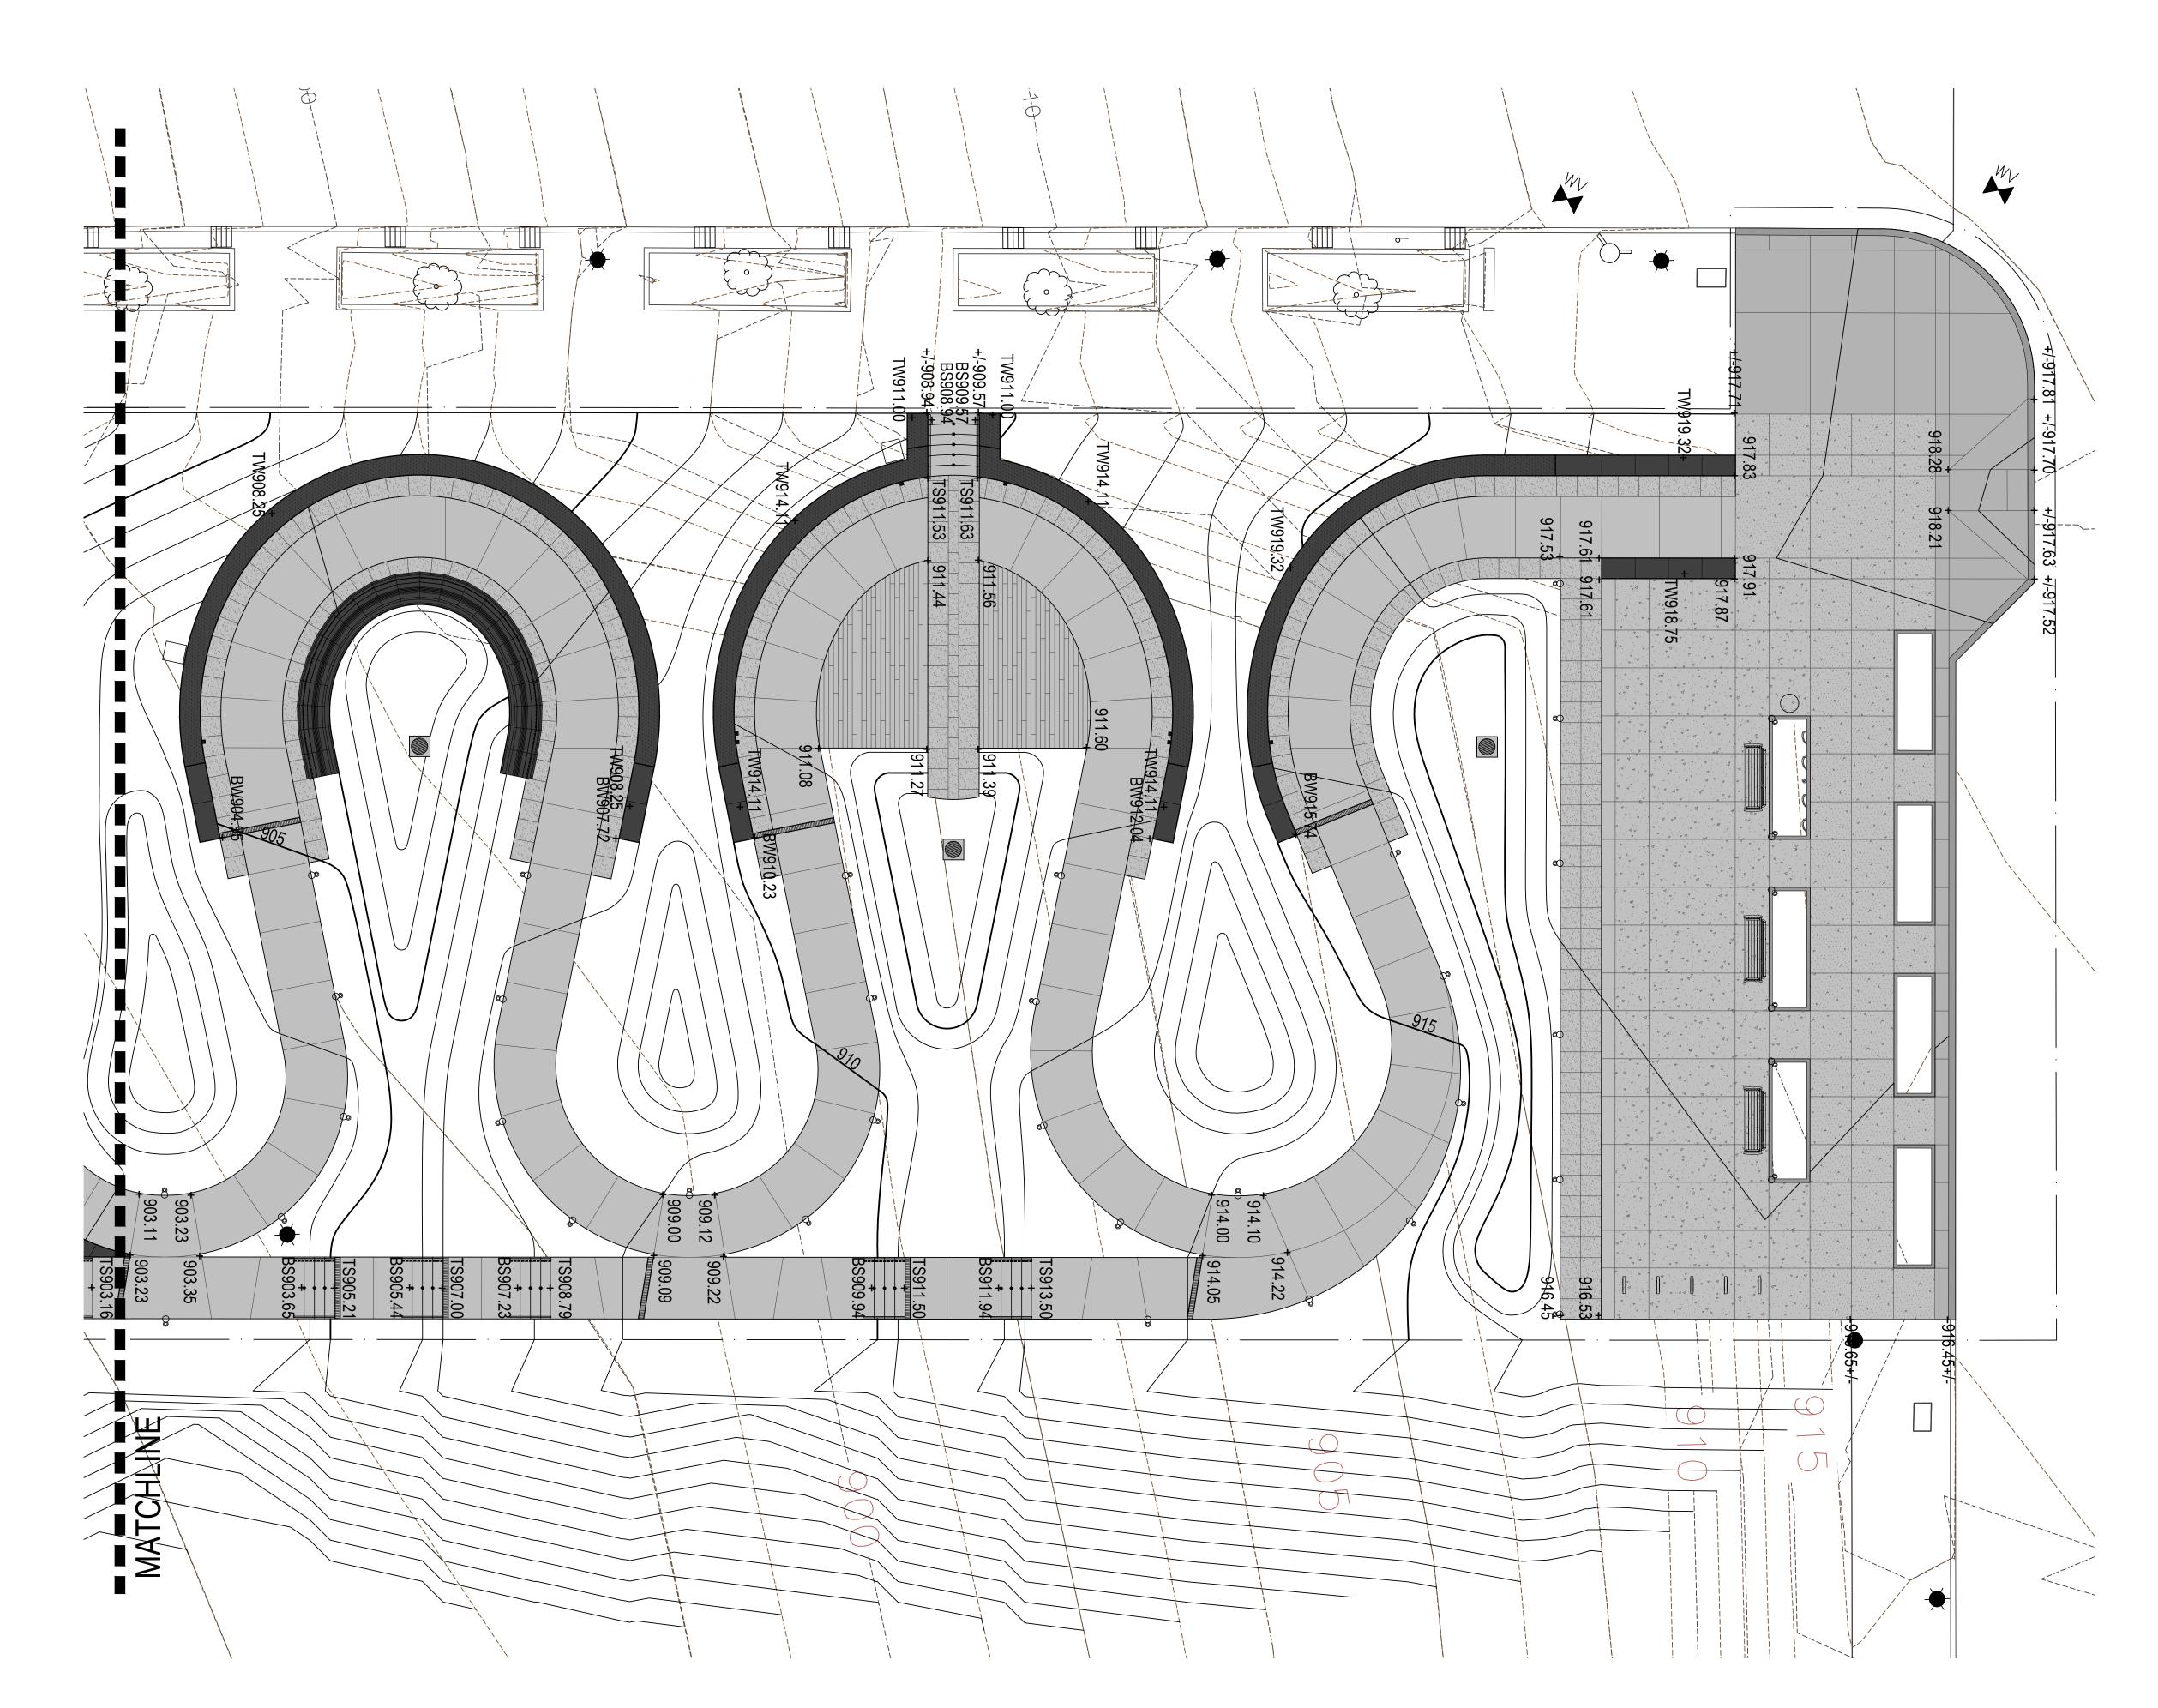
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Site Grading Plan

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Project Number: 21020:1

Drawn by: DM | CT

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Revisions:

S c a l e :

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SCALE: 1' = 8'-0"

Sheet Name:

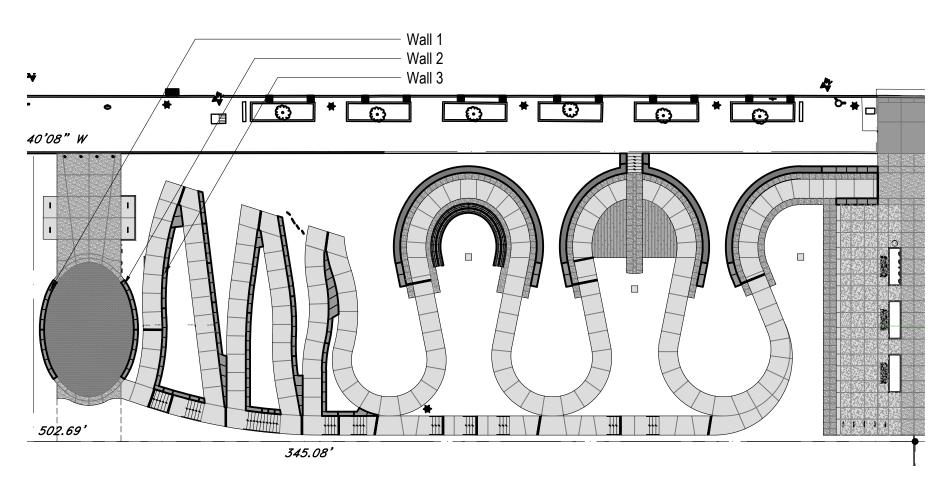
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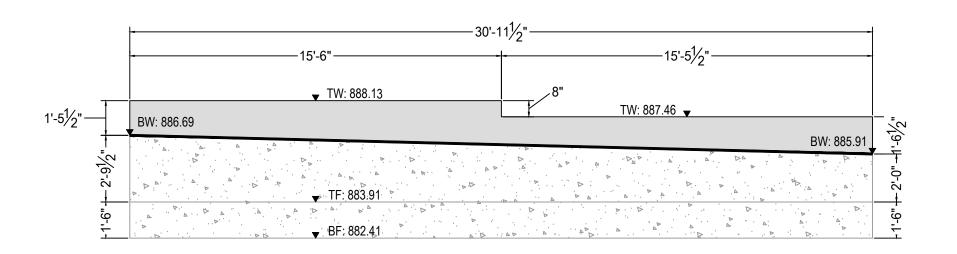
100% Construction Documents

Sheet Number:

L302

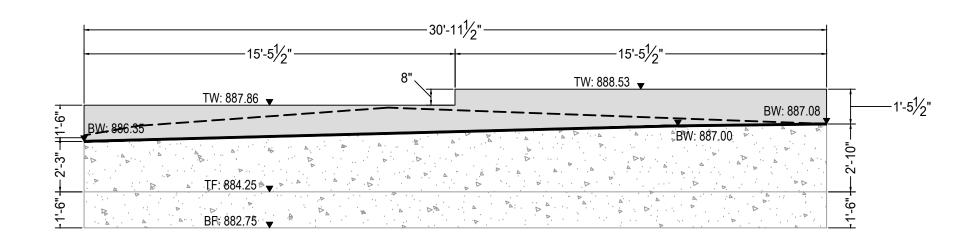


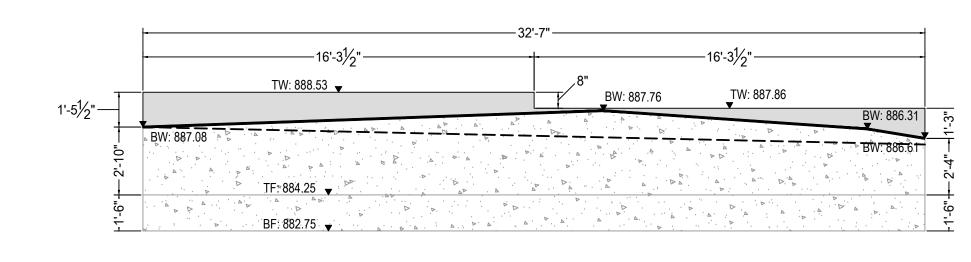
Wall Elevation Key Plan
Scale: 1"=30'-0"



1 Wall Elevation 1


L400 Scale: 1"=4'-0"






Wall Elevation 2 - Side A

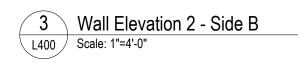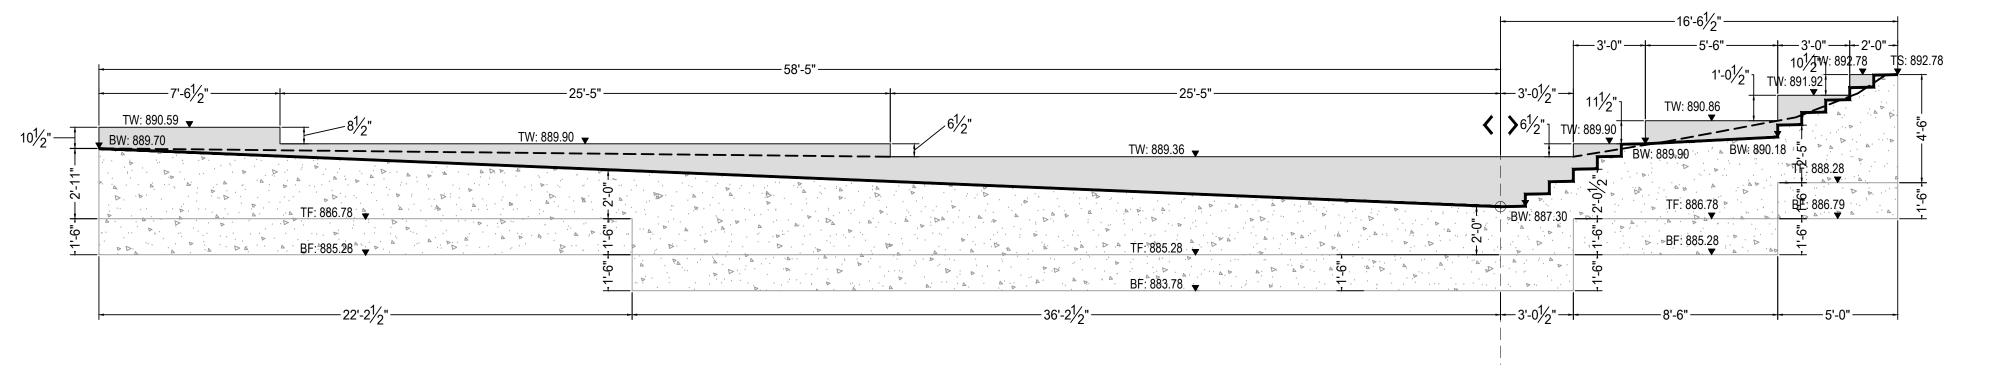
Scale: 1"=4'-0"





Wall Elevation 3 - Side A

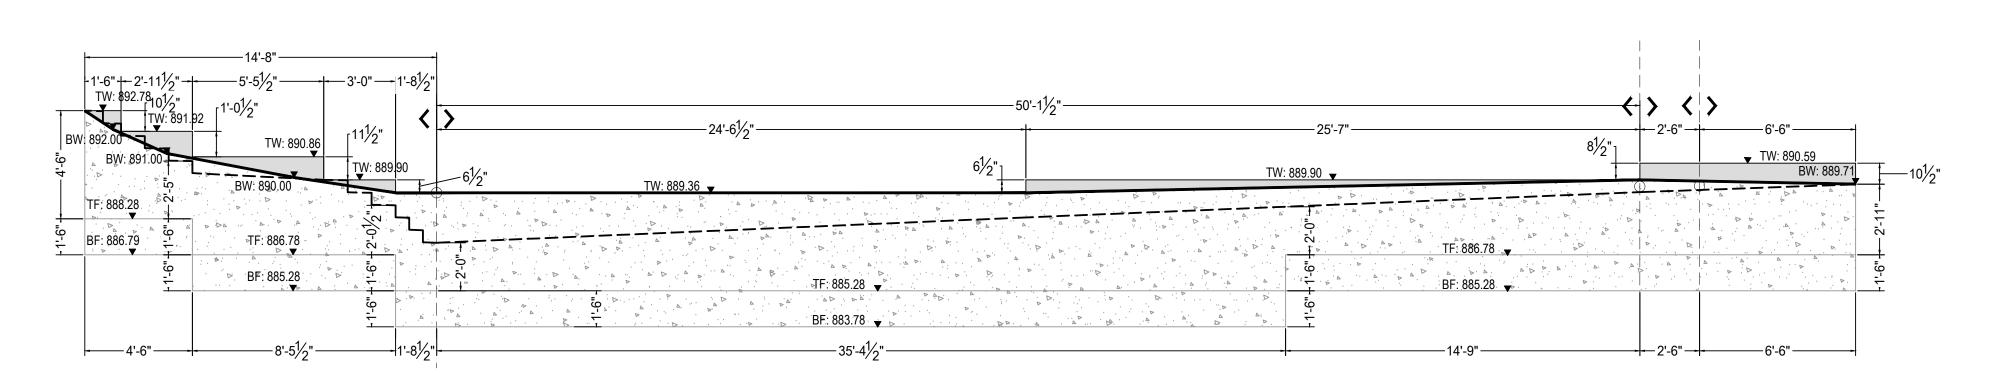Scale: 1"=4'-0"



Wall Elevation 3 - Side B

Scale: 1"=4'-0"



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DM | CT

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Scale:


Developed Wall Elevations

Submission:


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Sheet Number:
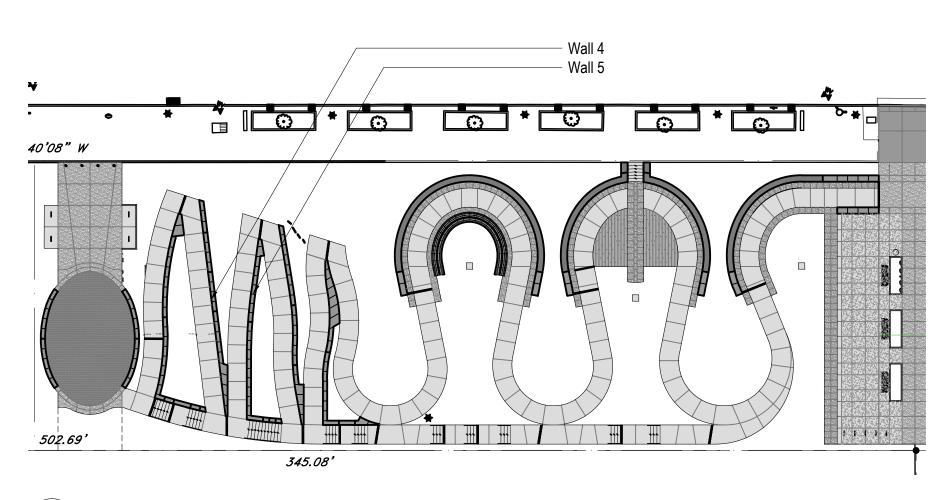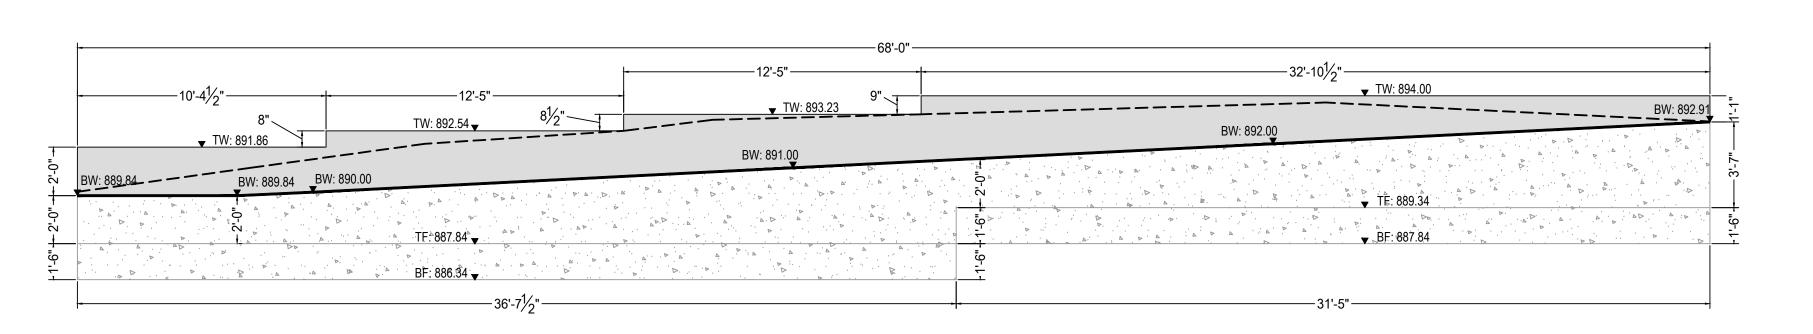
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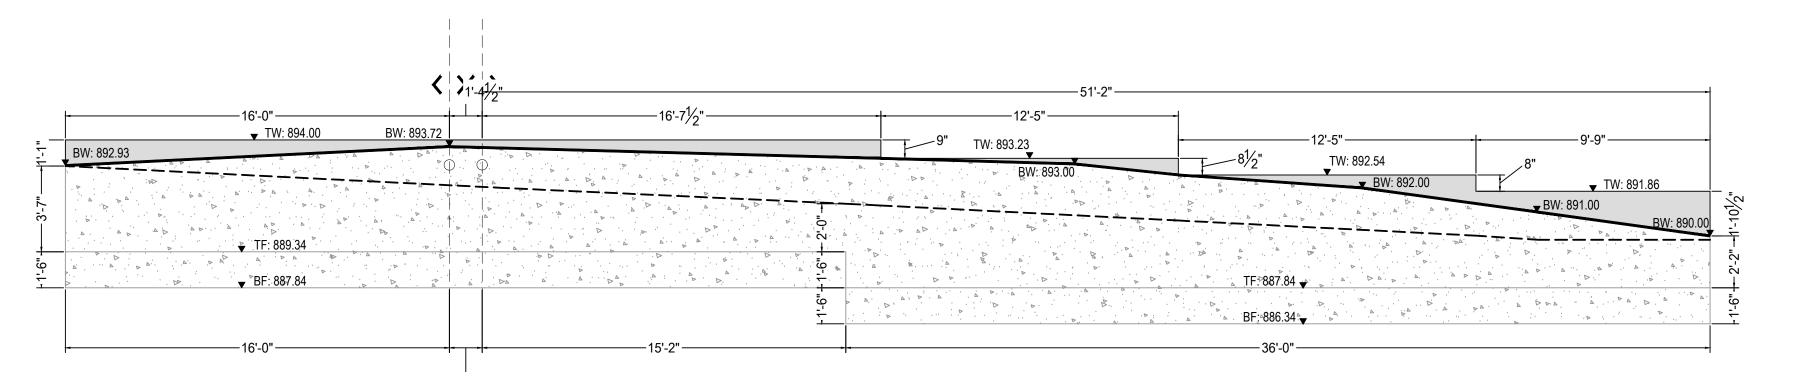


Wall Elevation Key Plan
Scale: 1"=30'-0"



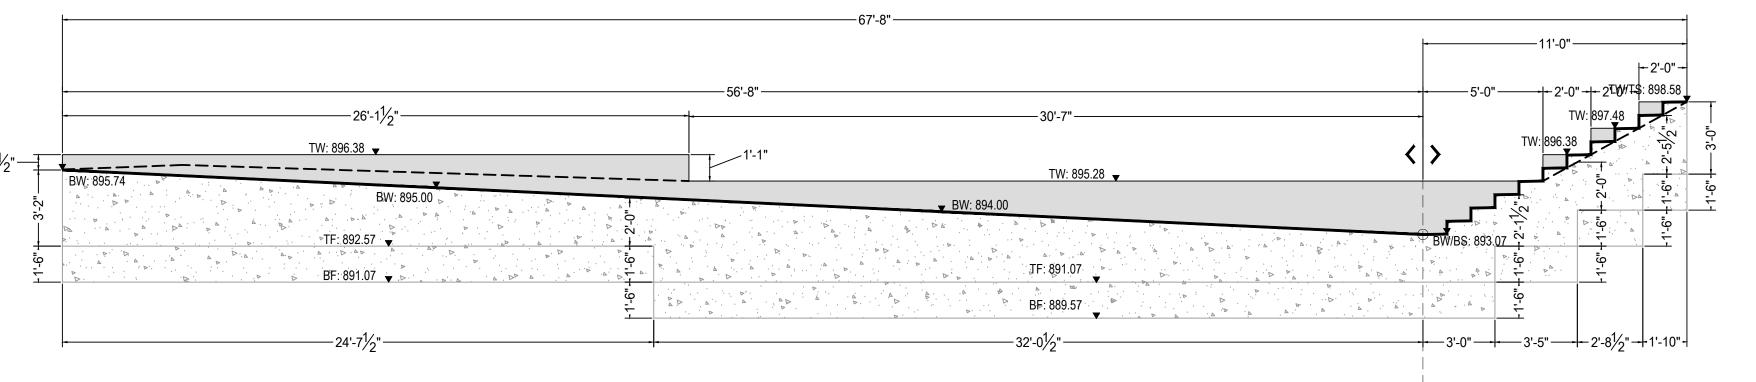
1 Wall Elevation 4 - Side A

Scale: 1"=4'-0"




Wall Elevation 4 - Side B

Scale: 1"=4'-0"



Wall Elevation 5 - Side A

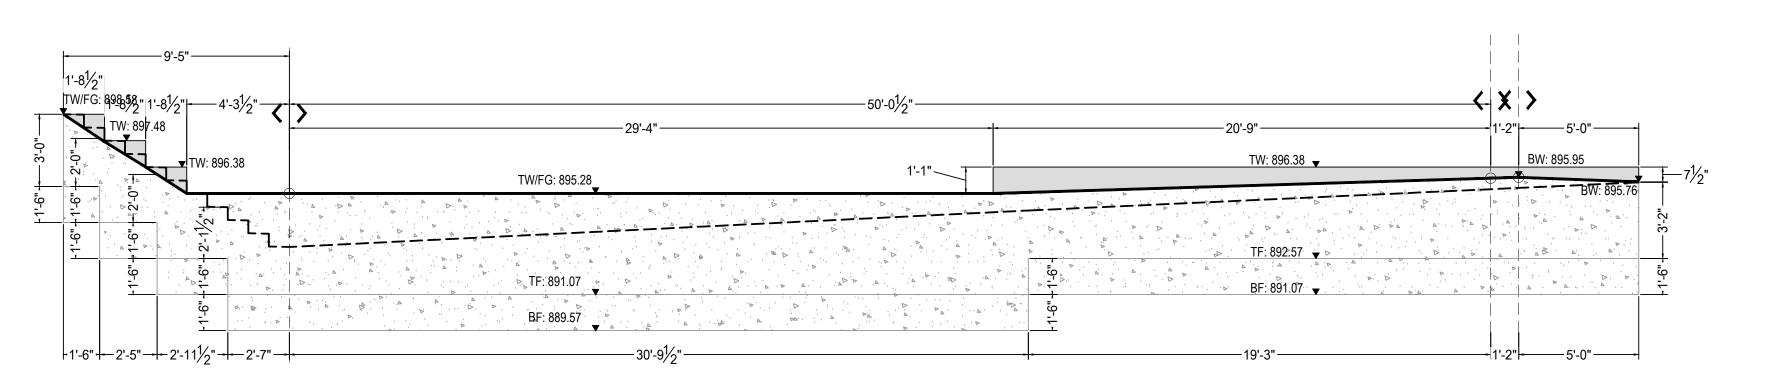Scale: 1"=4'-0"



Wall Elevation 5 - Side B

Scale: 1"=4'-0"



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Project Number: 21020:1

Drawn by: DM | CT Checked by: FB | DM

Date: **April 28, 2023**

Revisions:

Scale: as noted

Sheet Name:

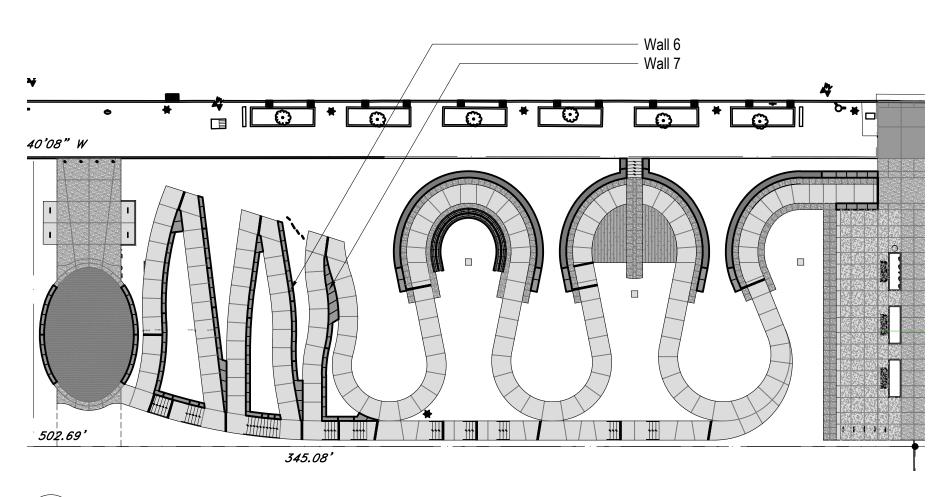
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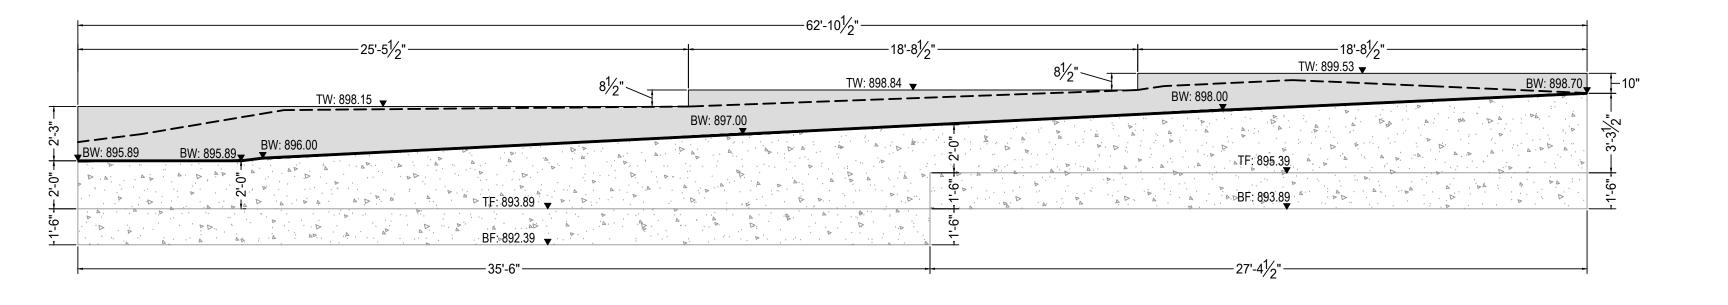
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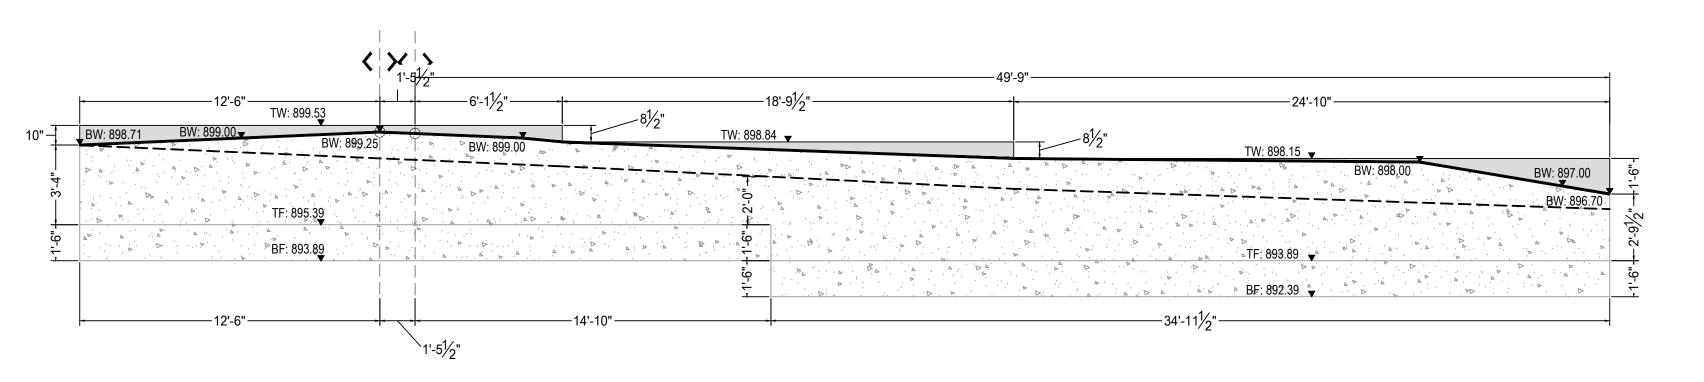
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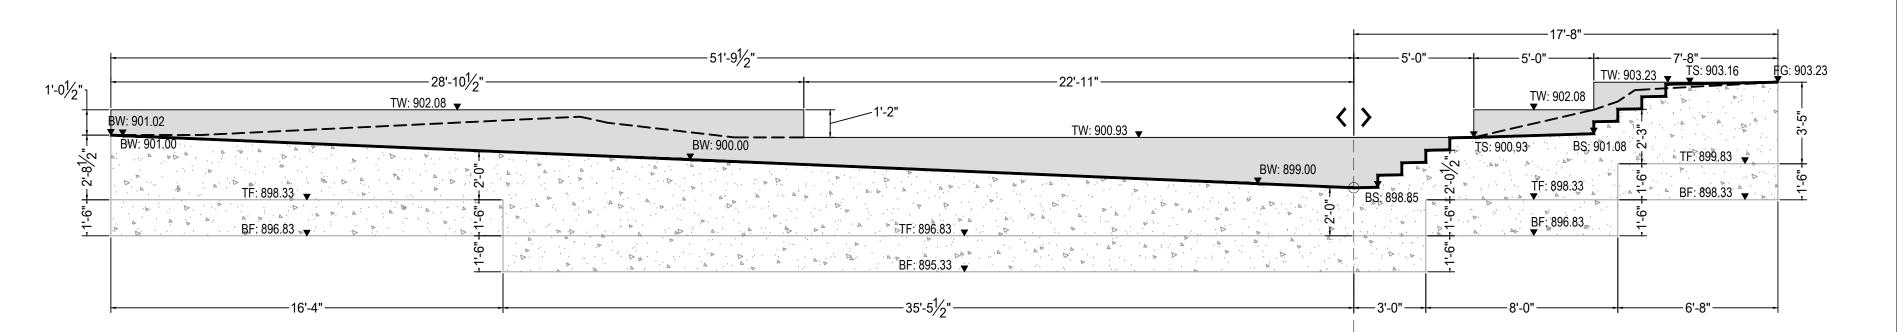
Wall Elevation Key Plan
Scale: 1"=30'-0"



1 Wall Elevation 6 - Side A Scale: 1"=4'-0"



Wall Elevation 6 - Side B Scale: 1"=4'-0"



Wall Elevation 7 - Side A Scale: 1"=4'-0"

6'.5½" 993.23 BW: 903.00 BW: 902.90 TW: 903.23 TW: 902.08 TF: 898.83 TF: 896.83 TF: 896.

Wall Elevation 7 - Side B

Scale: 1"=4'-0"

1'-(41/2"



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Project Number: 21020:1 Drawn by: DM | CT

Checked by: FB | DM

Date:
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Revisions:

Scale: as noted

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Sheet Name:

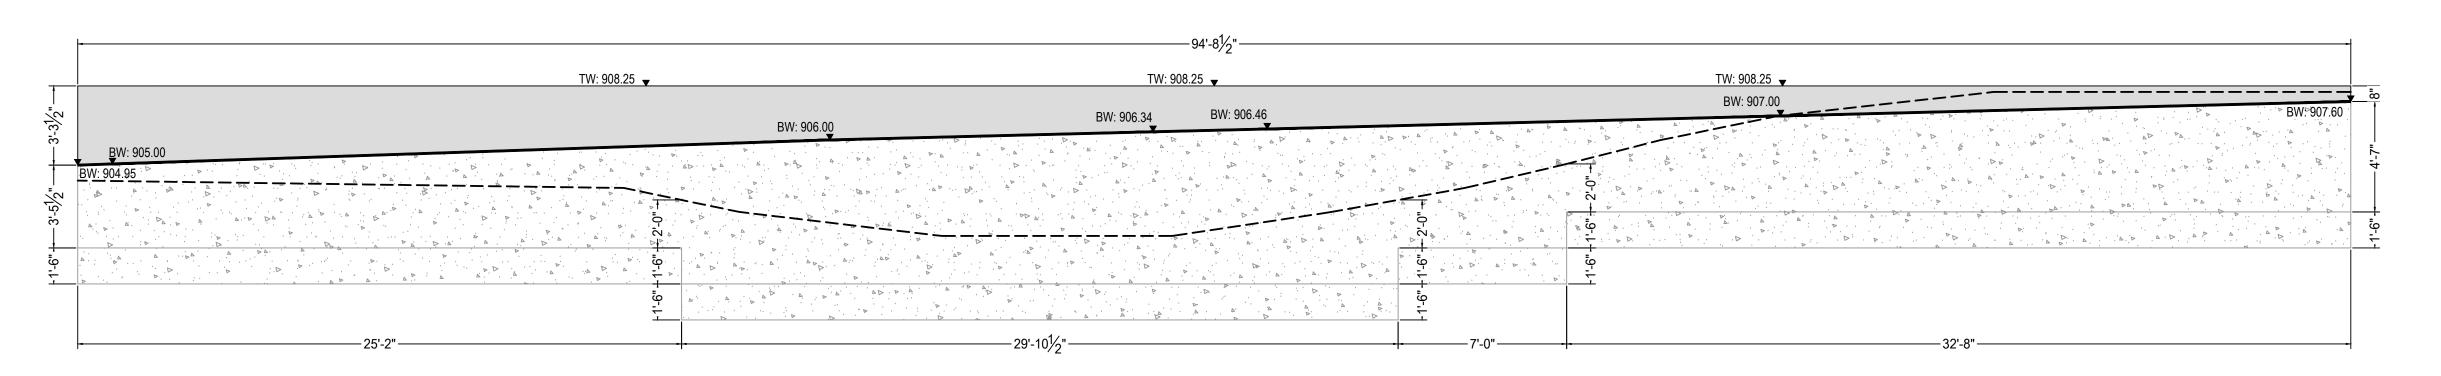
Developed Wall Elevations

Submission:

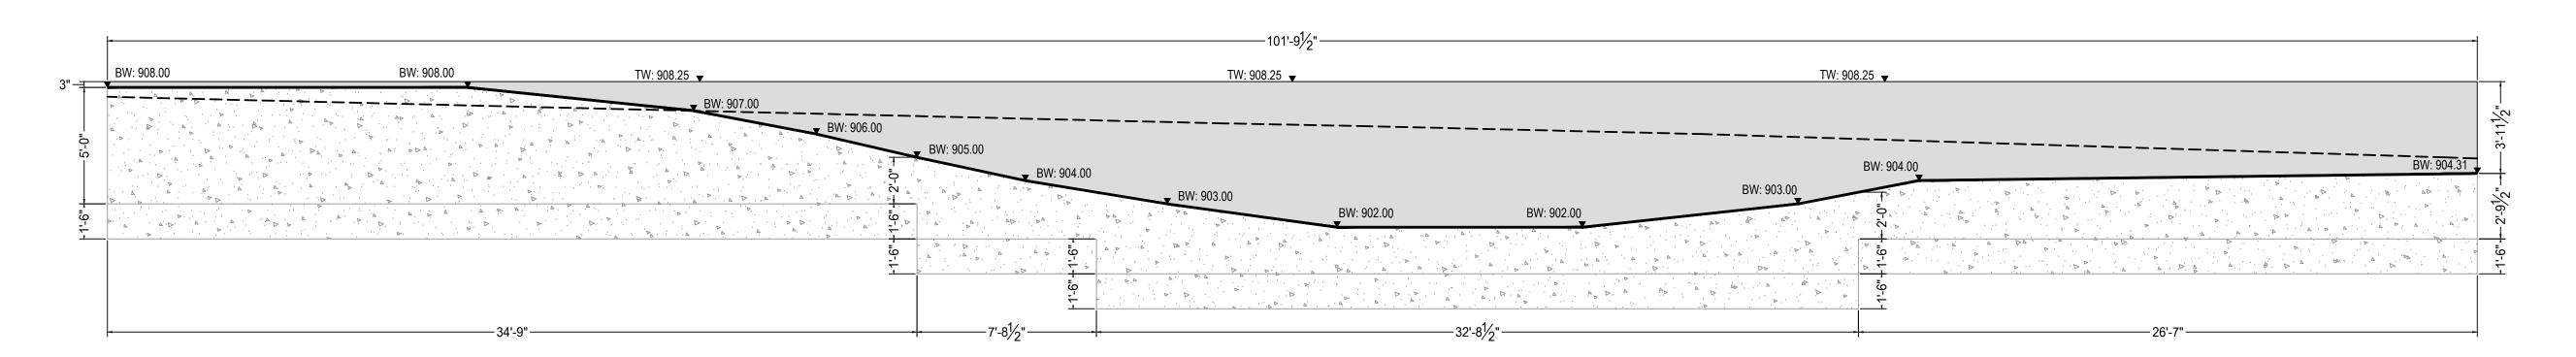
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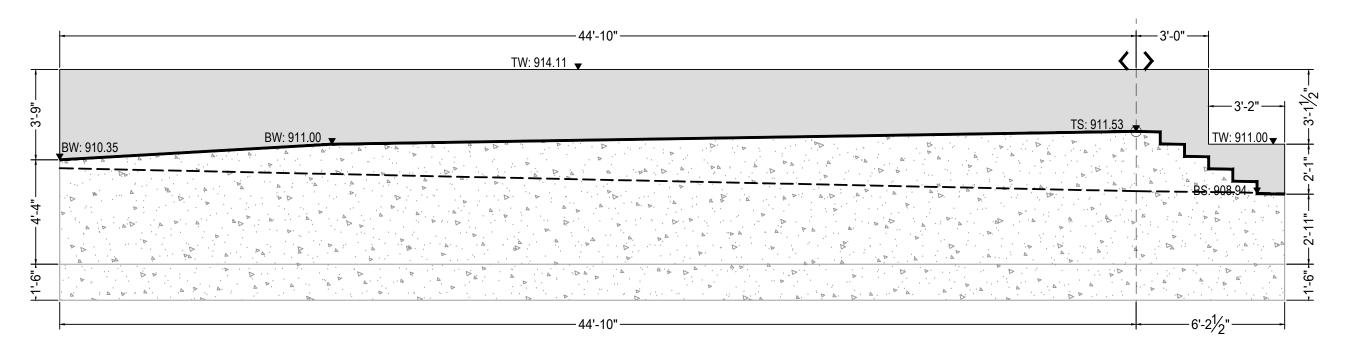
L402



1 Wall Elevation 8 - Side A L403 Scale: 1"=4'-0"

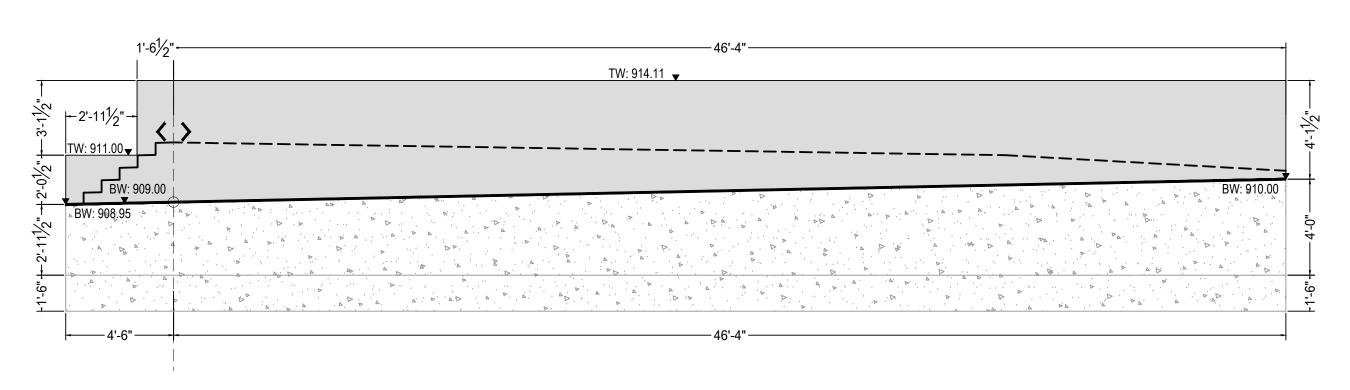


2 Wall Elevation 8 - Side B L403 Scale: 1"=4'-0"




Wall Elevation 9 - Side A

Scale: 1"=4'-0"



Wall Elevation 9 - Side B

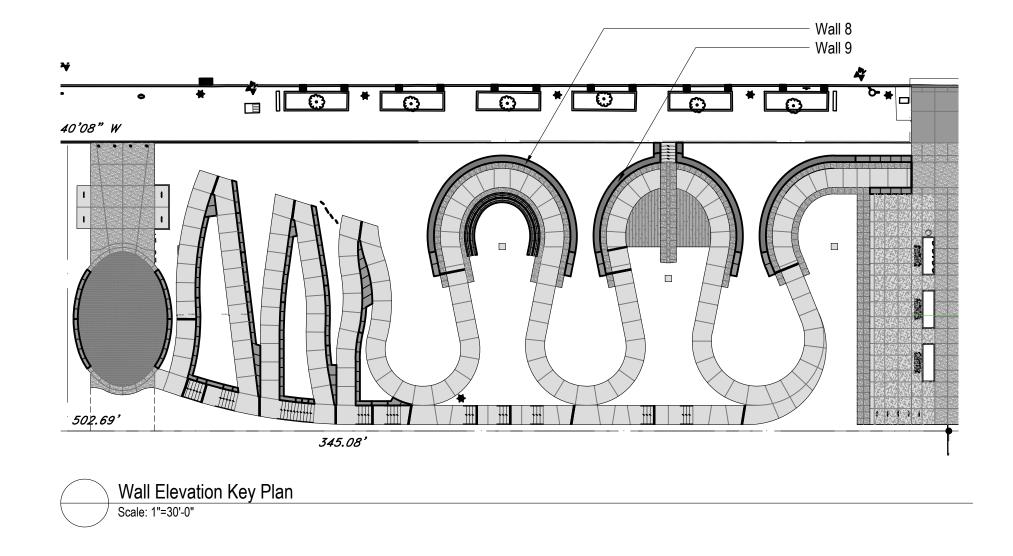Scale: 1"=4'-0"



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Project Number: 21020:1

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Scale: as noted

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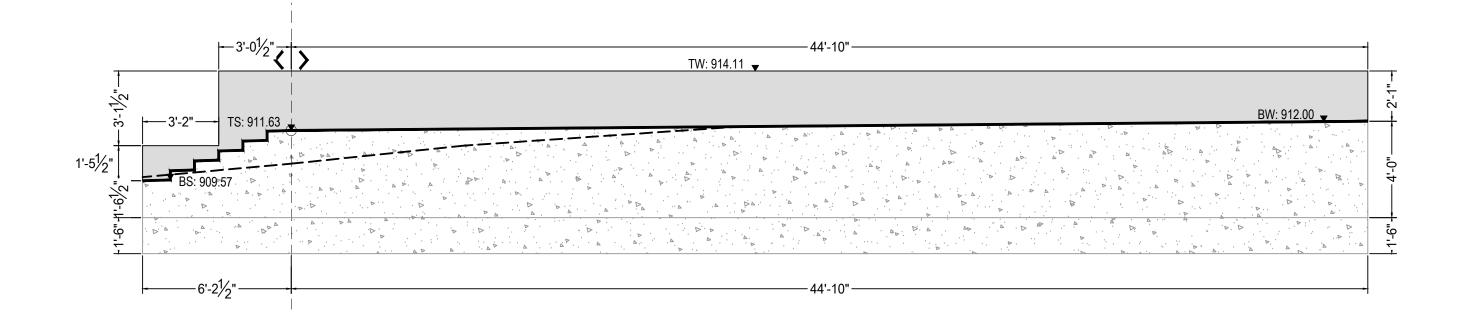
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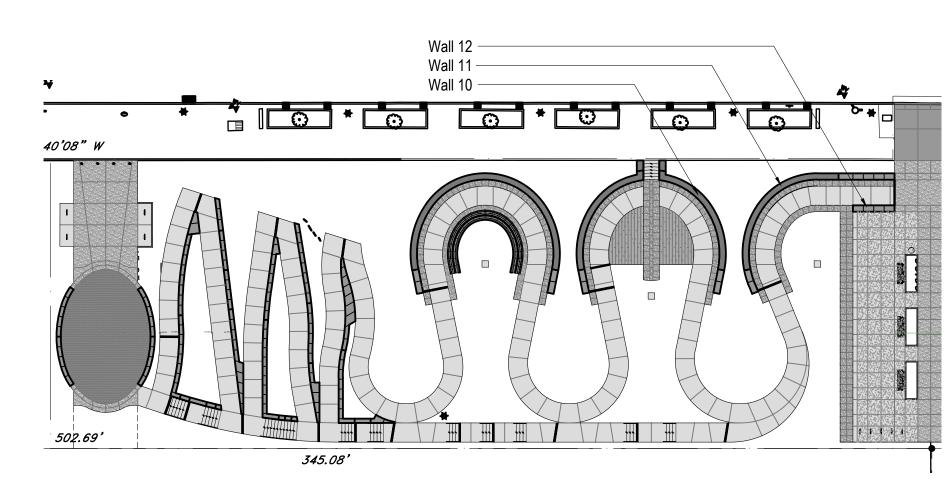
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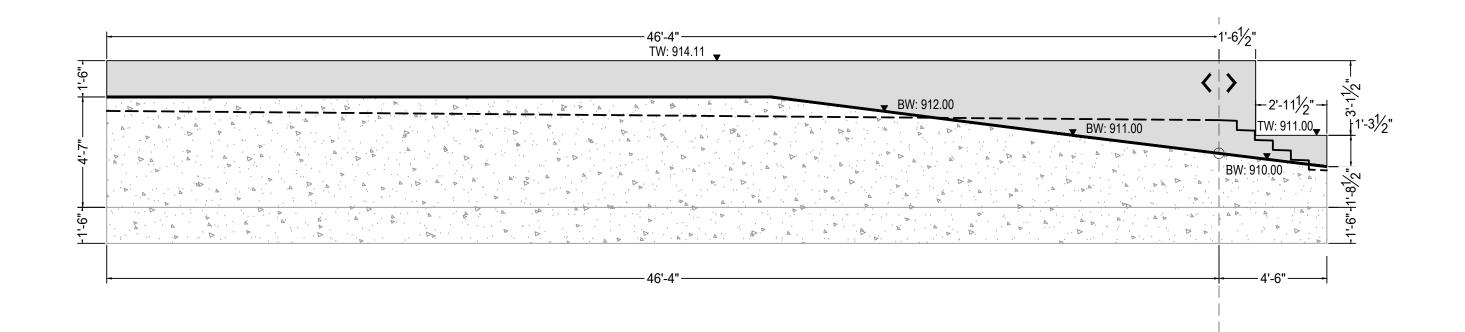





Wall Elevation Key Plan
Scale: 1"=30'-0"

1 Wall Elevation 10 - Side A

Scale: 1"=4'-0"



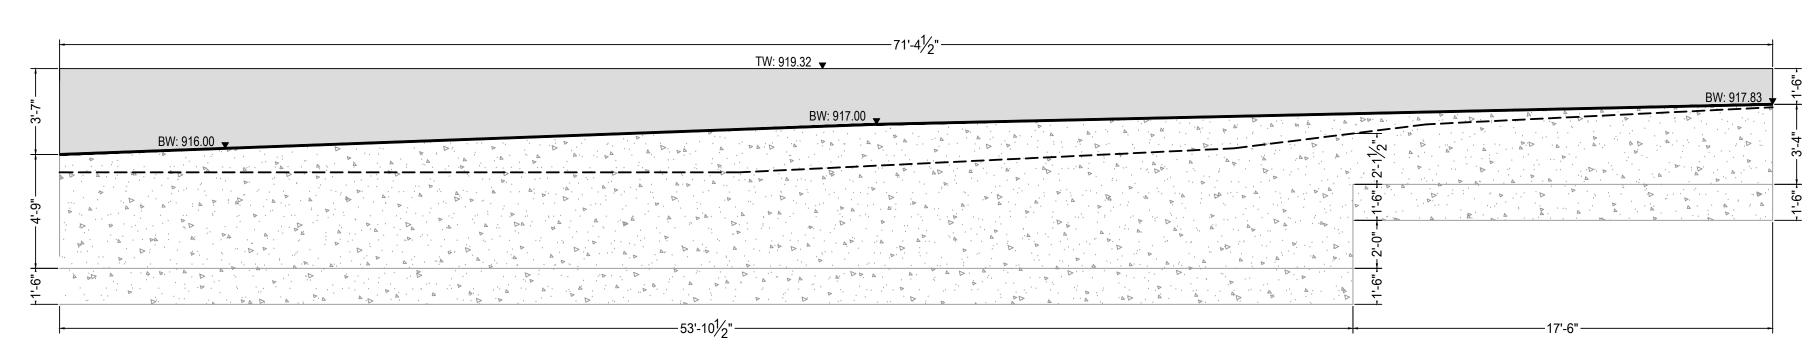2 Wall Elevation 10 - Side B L404 Scale: 1"=4'-0"




▼ TW: 919.32 BW: 917.87

5 Wall Elevation 12 - Side A

Scale: 1"=4'-0"

Wall Elevation 11 - Side A

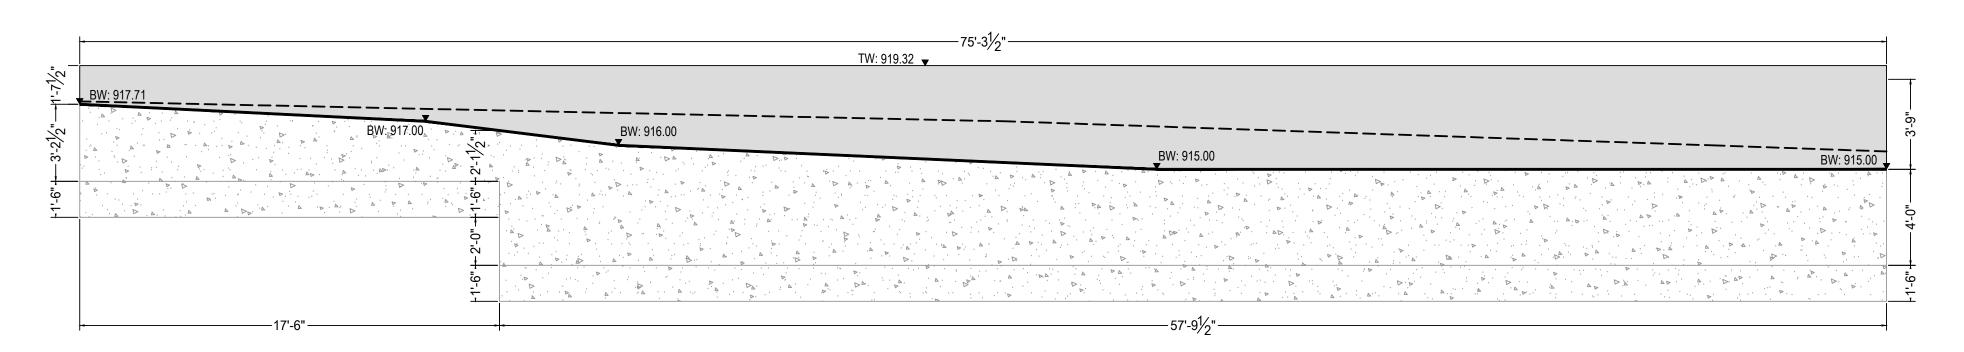Scale: 1"=4'-0"



6 Wall Elevation 12 - Side B
L404 Scale: 1"=4'-0"



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Scale: as noted

Sheet Name:

Developed Wall Elevations

Submission:


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Wall Elevation 11 - Side B

L404 Scale: 1"=4'-0"





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Project Number: 21020:1
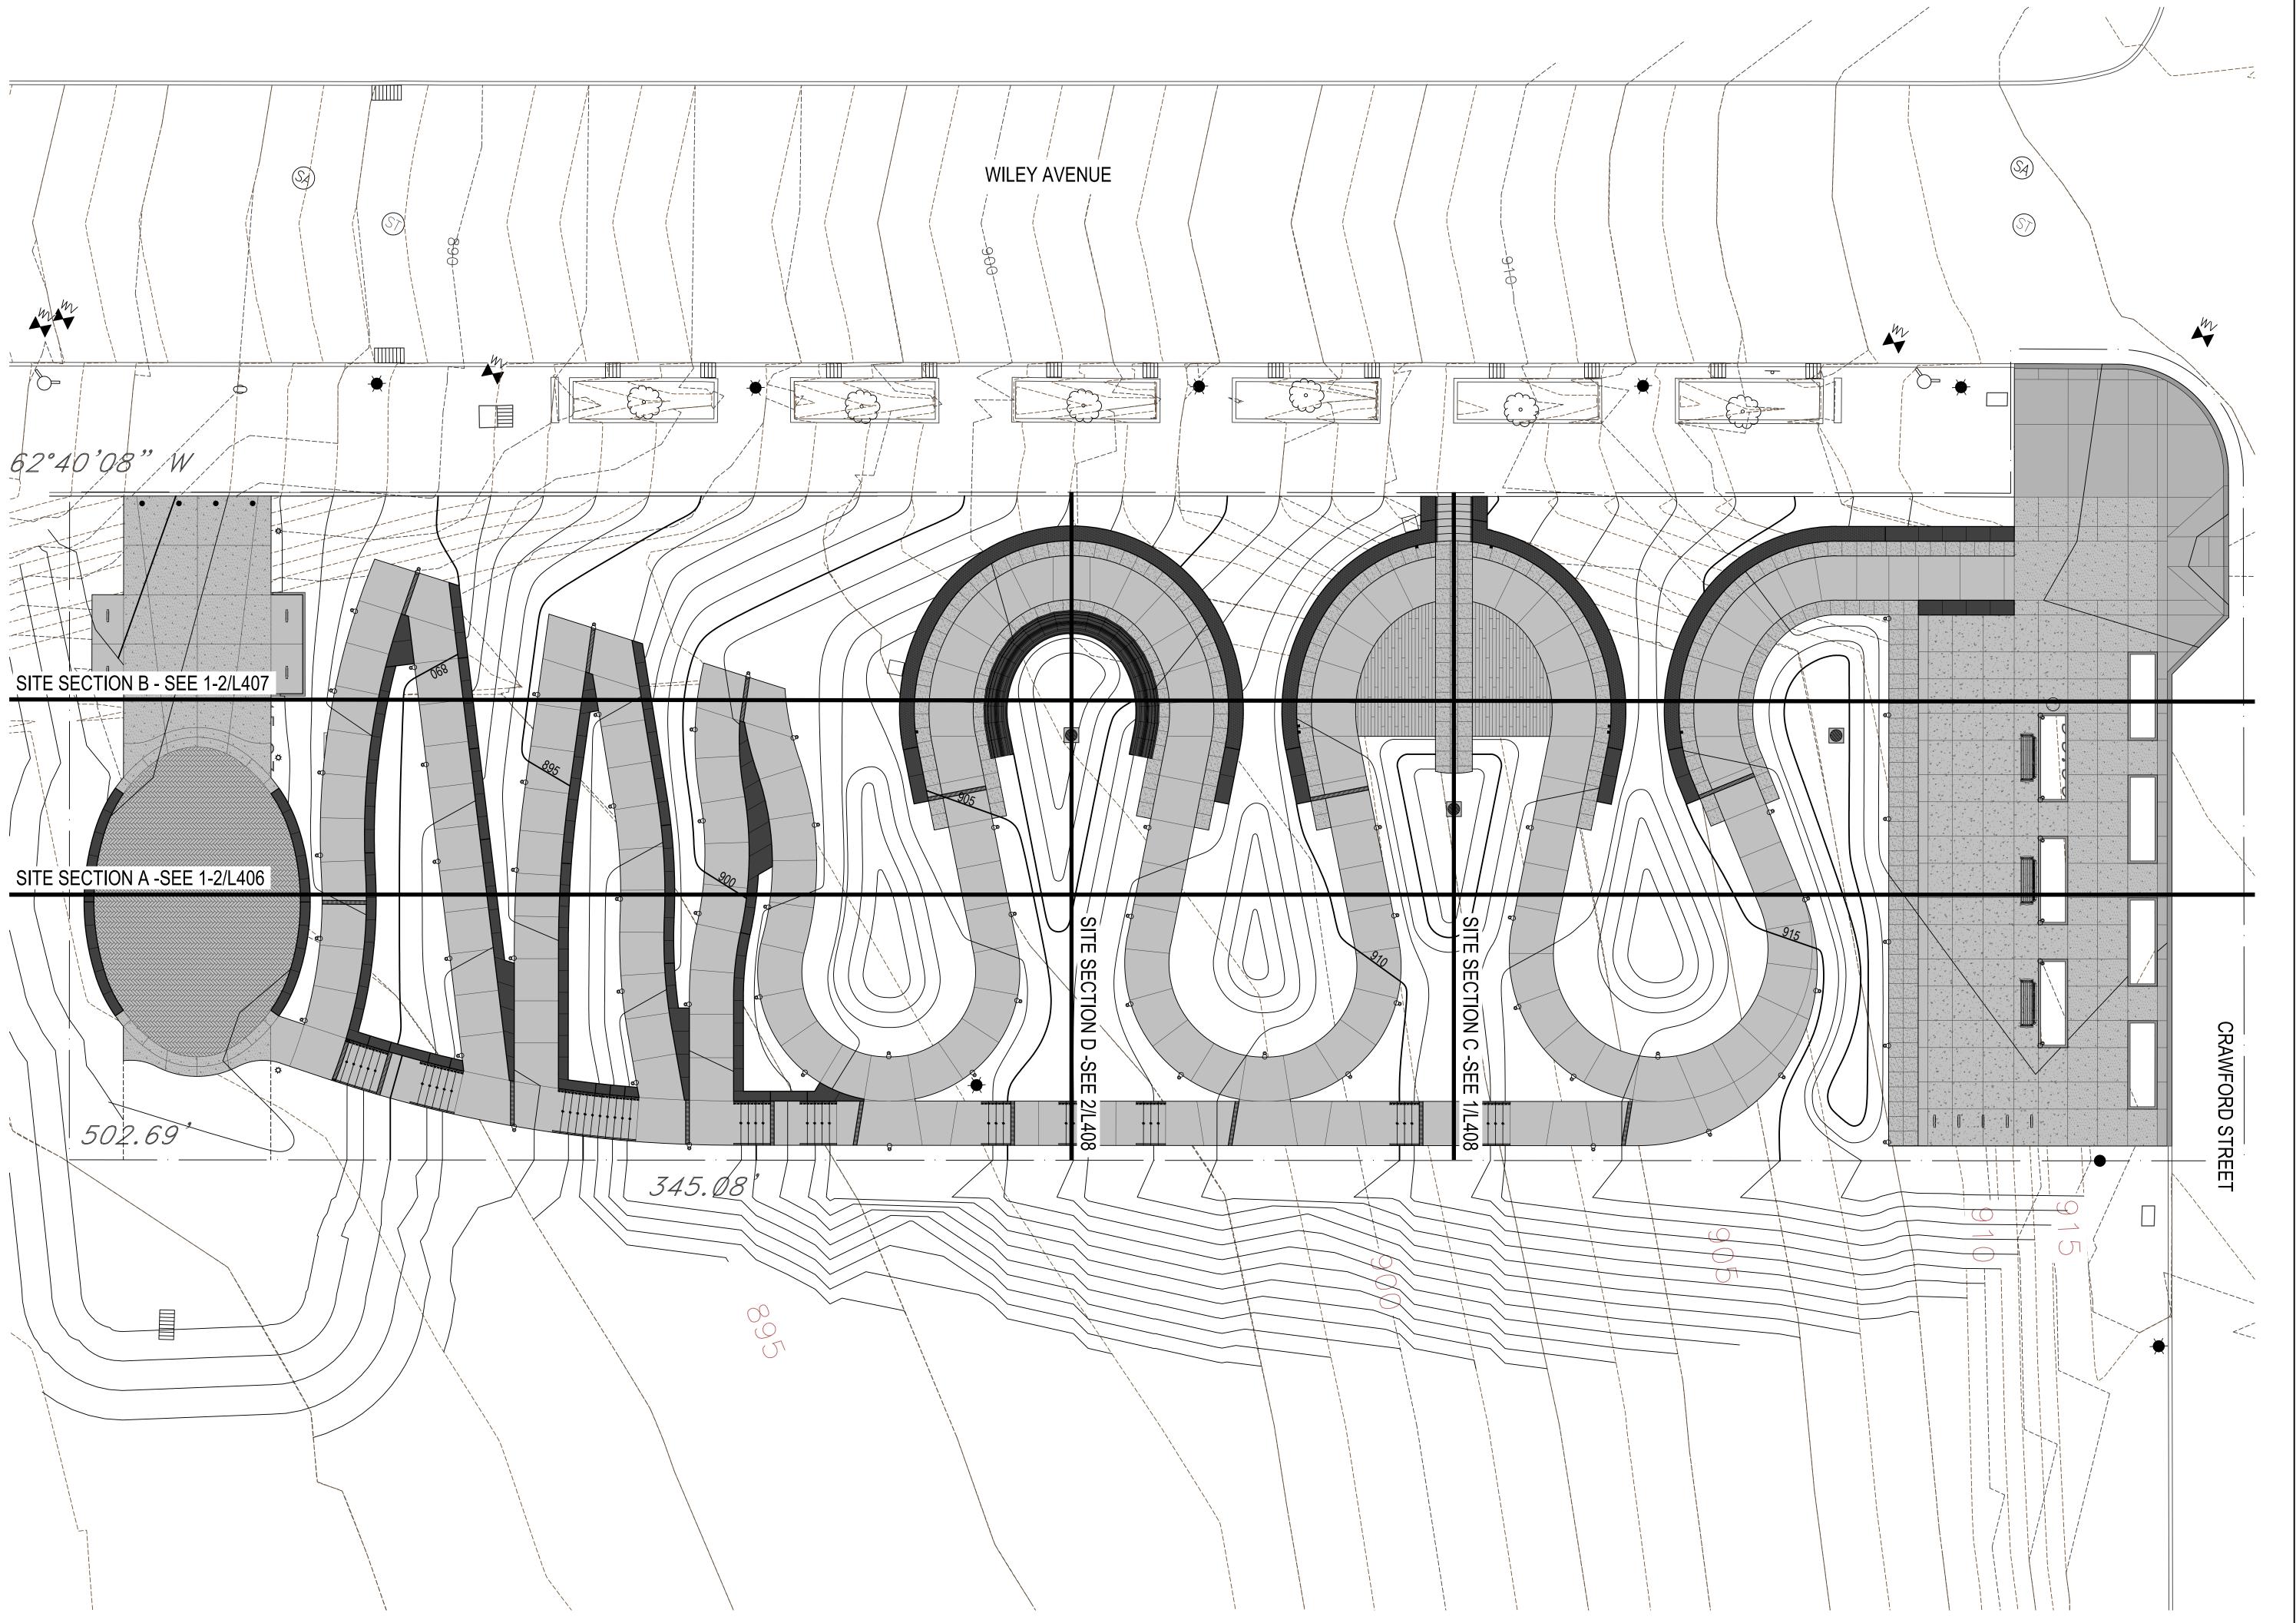
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Date:
April 28, 2023
Revisions:

S c a l e :
0' 10'

SCALE: 1" = 10'-0"

Sheet Name:


Site Section Reference Plan

Submission:


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L405



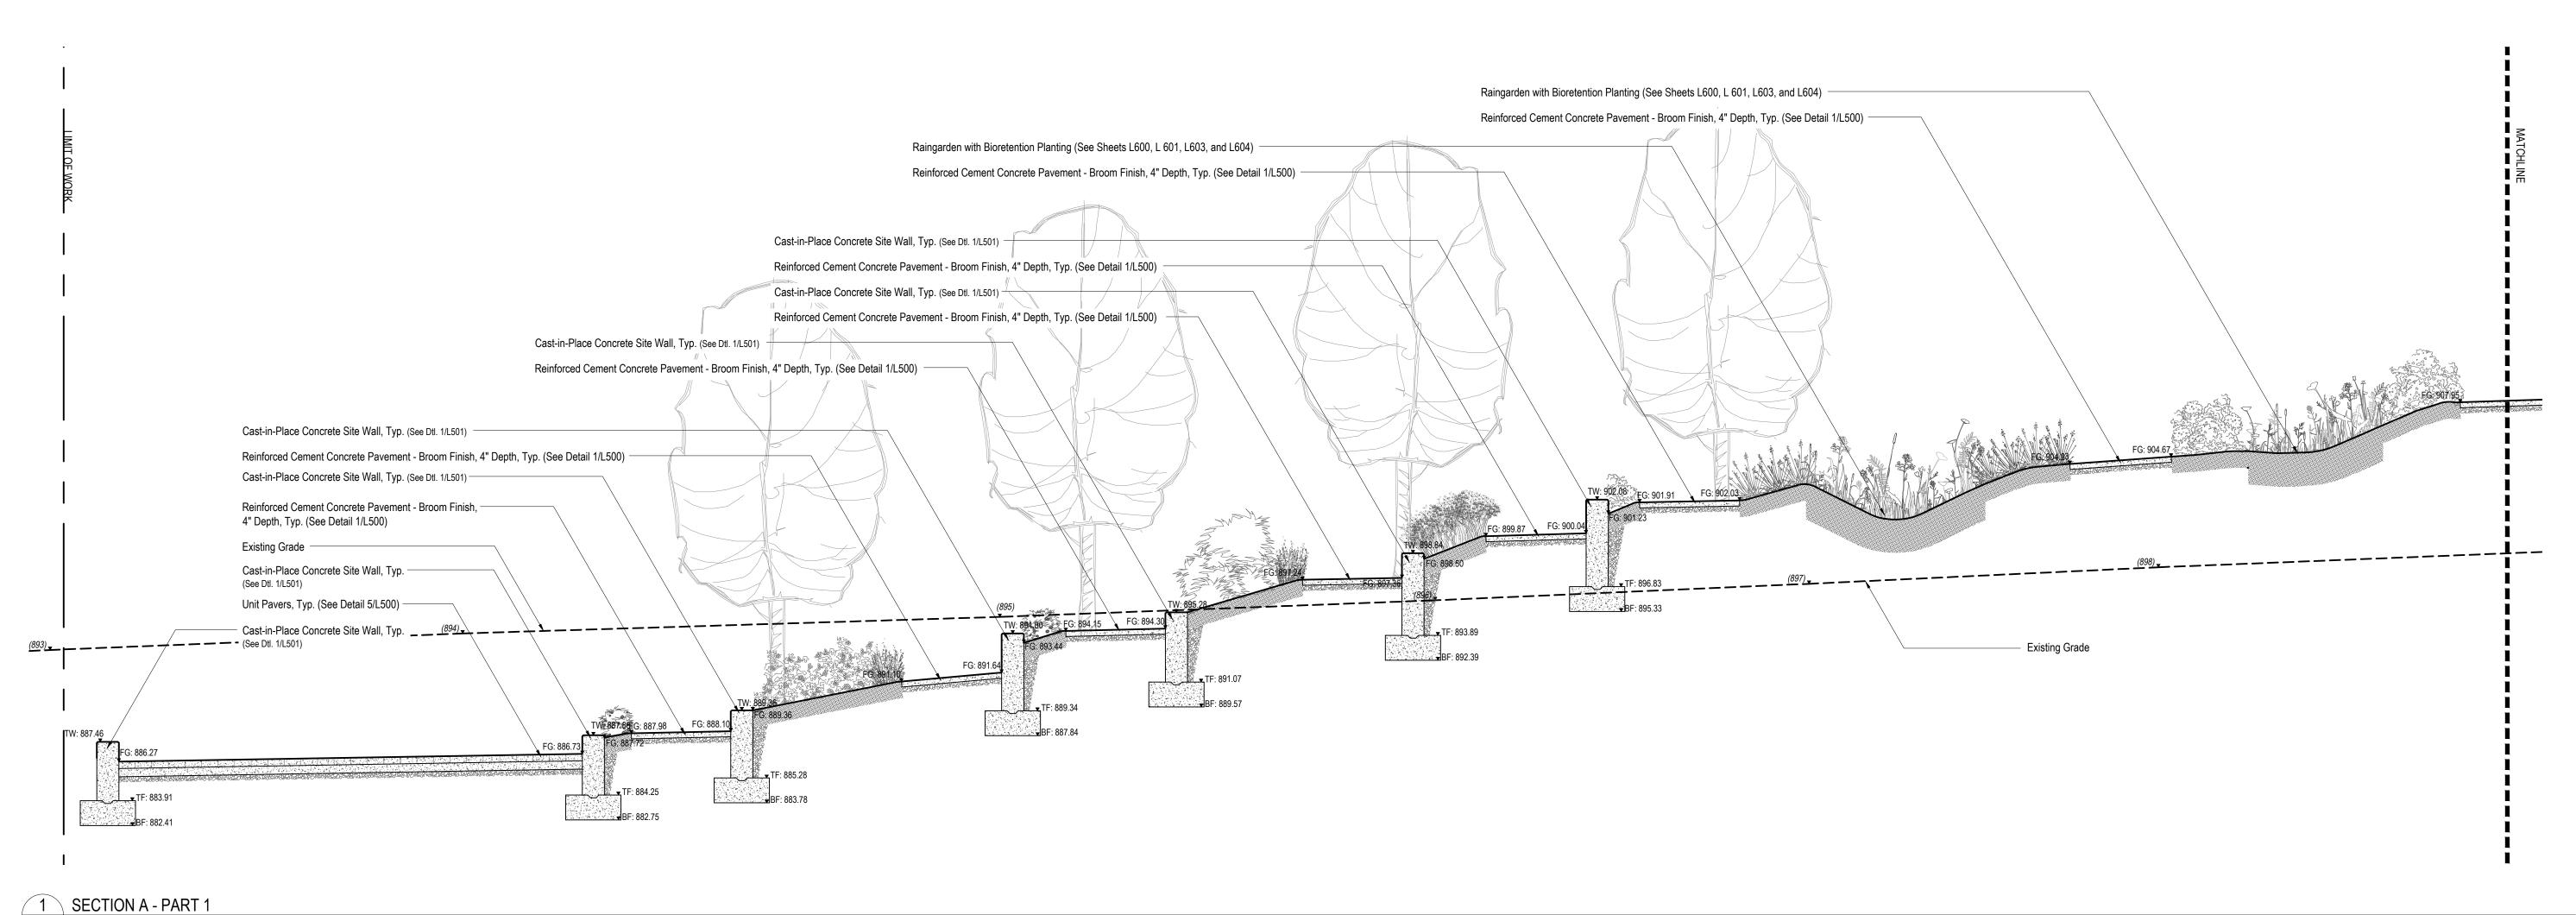L406 SCALE: 1"=5'



2 SECTION A - PART 2 SCALE: 1"=5"

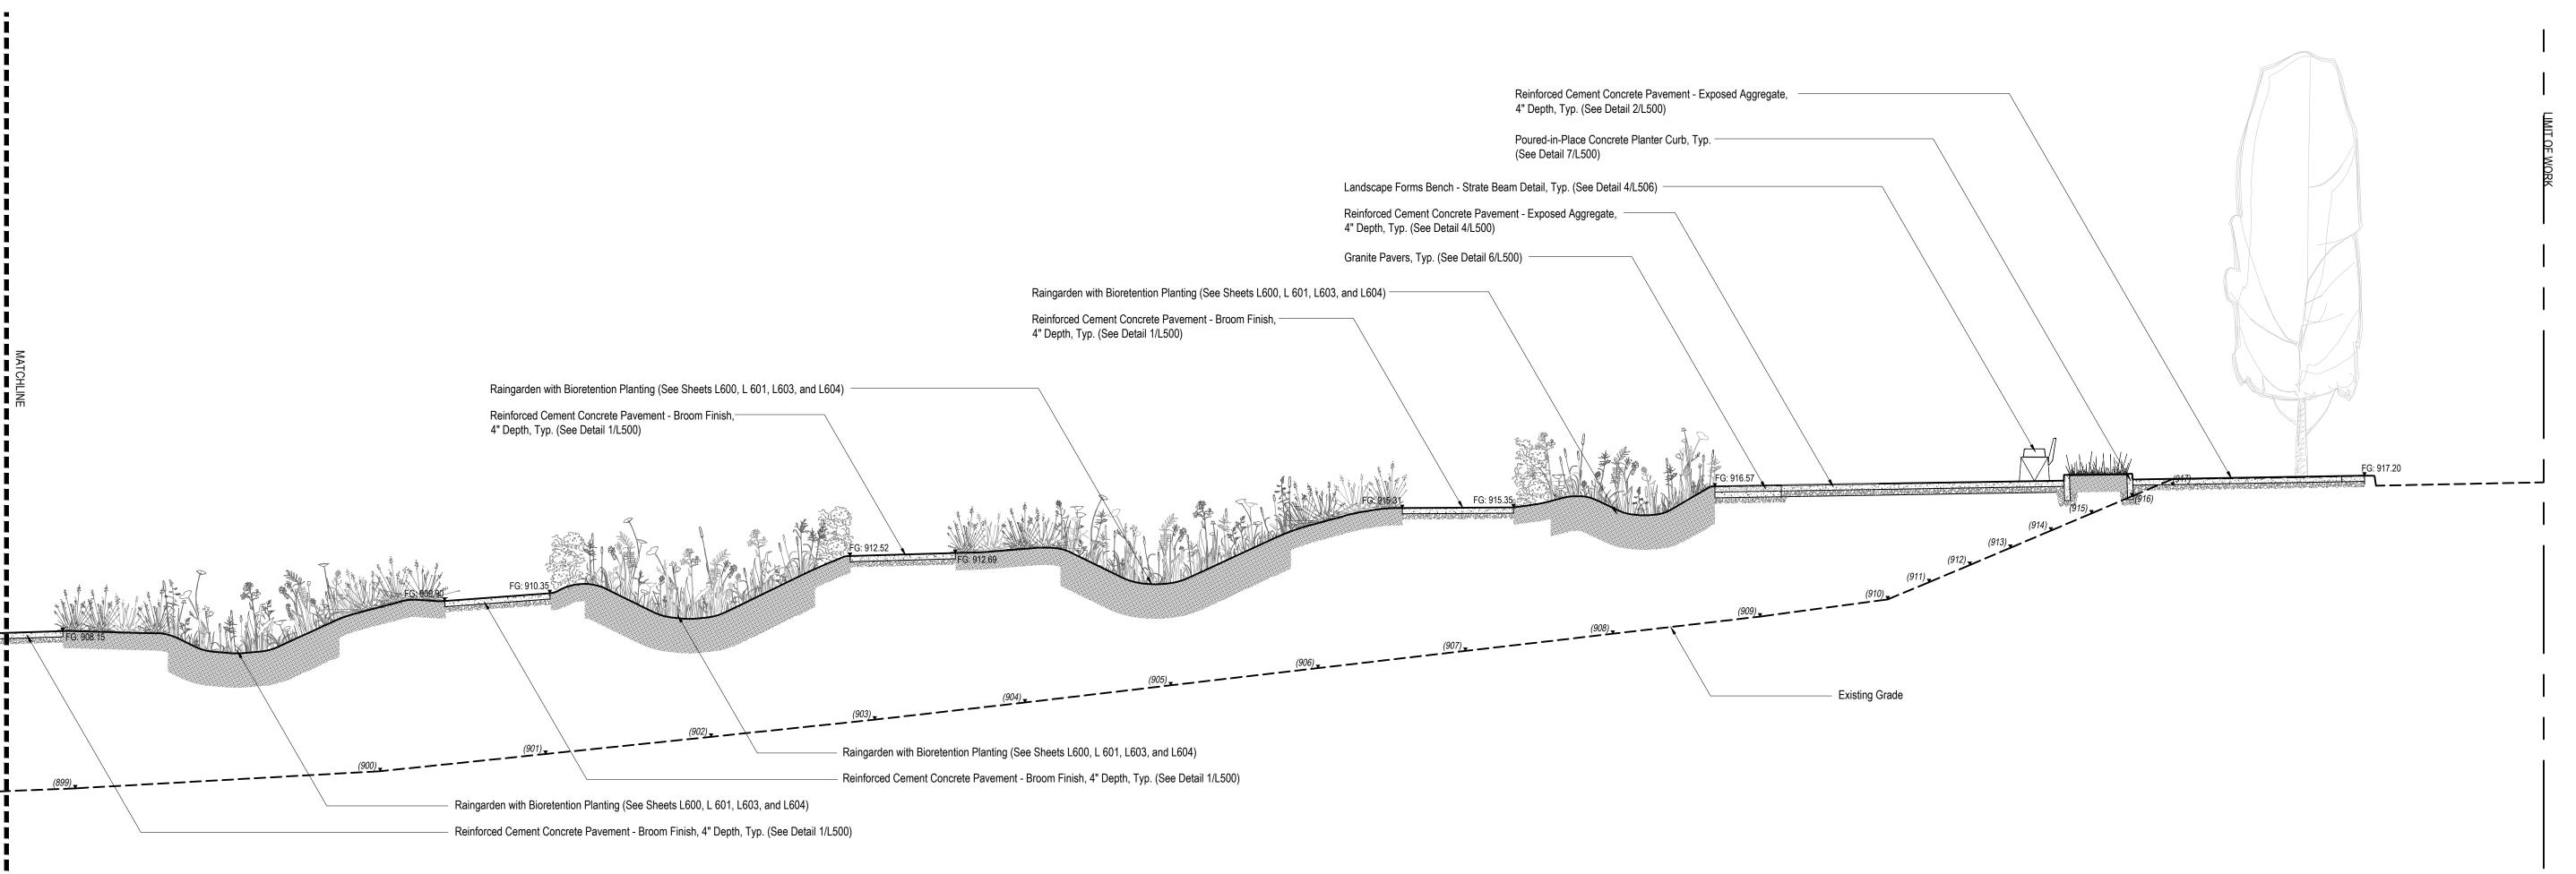

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Lower Hill-Curtain Call Pittsburgh, PA

Project Number: 21020:1

Drawn by:
DM | CT
Checked by:

D a t e : **April 28, 2023**

FB | DM

Revisions:

Scale: as noted

Sheet Name:

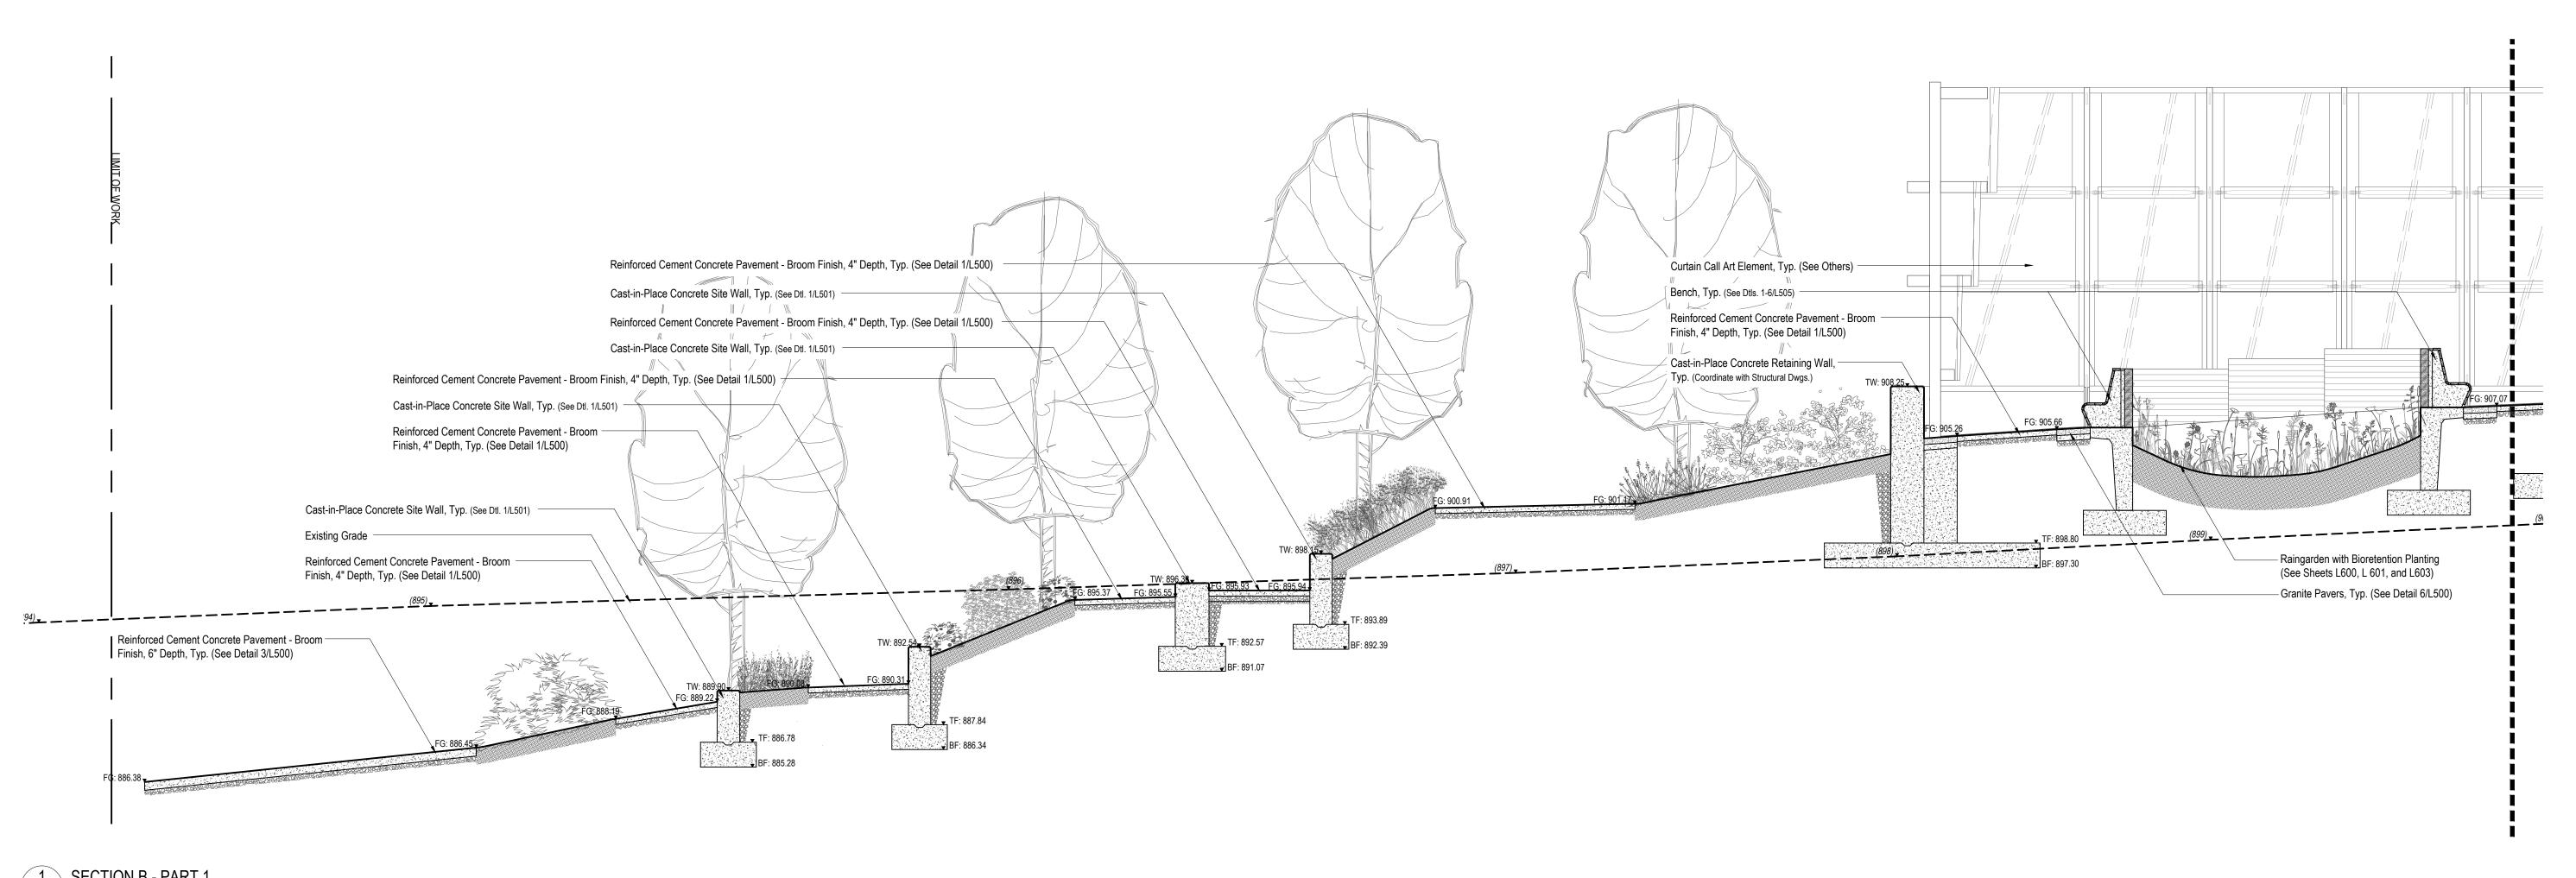
Site Sections

Submission:

100% Construction Documents

Sheet Number:

L406



1 SECTION B - PART 1
L407 SCALE: 1"=5' Reinforced Cement Concrete Pavement - Exposed Aggregate, 4" Depth, Typ. (See Detail 2/L500) Poured-in-Place Concrete Planter Curb, Typ. (See Detail 7/L500) -Reinforced Cement Concrete Pavement - Exposed Aggregate, 4" Depth, Typ. (See Detail 4/L500) Granite Pavers, Typ. (See Detail 6/L500) Raingarden with Bioretention Planting (See Sheets L600, L 601, L603, and L604) Reinforced Cement Concrete Pavement - Broom Finish, 4" Depth, Typ. (See Detail 1/L500) Cast-in-Place Concrete Retaining Wall, Typ. (Coordinate with Structural Dwgs.) Granite Pavers, Typ. (See Detail 6/L500) TW: 919.32 Reinforced Cement Concrete Pavement - Broom Finish, 4" Depth, Typ. (See Detail 1/L500) Existing Grade Granite Pavers, Typ. (See Detail 6/L500) - Cast-in-Place Concrete Retaining Wall, Typ. (Coordinate with Structural Dwgs.) - Granite Pavers, Typ. (See Detail 6/L500) Reinforced Cement Concrete Pavement - Broom Finish, 4" Depth, Typ. (See Detail 1/L500) Cast-in-Place Concrete Retaining Wall, Typ. Wood Decking, Typ. (See Dtls. 1-7/L502) (Coordinate with Structural Dwgs.) Granite Pavers & Pier (See Dtls. 6/L500 & 1-7/L502) Granite Pavers, Typ. (See Detail 6/L500) Wood Decking, Typ. (See Dtls. 1-7/L502)

Reinforced Cement Concrete Pavement - Broom

Finish, 4" Depth, Typ. (See Detail 1/L500)

2 SECTION B - PART 2

L407 SCALE: 1"=5'

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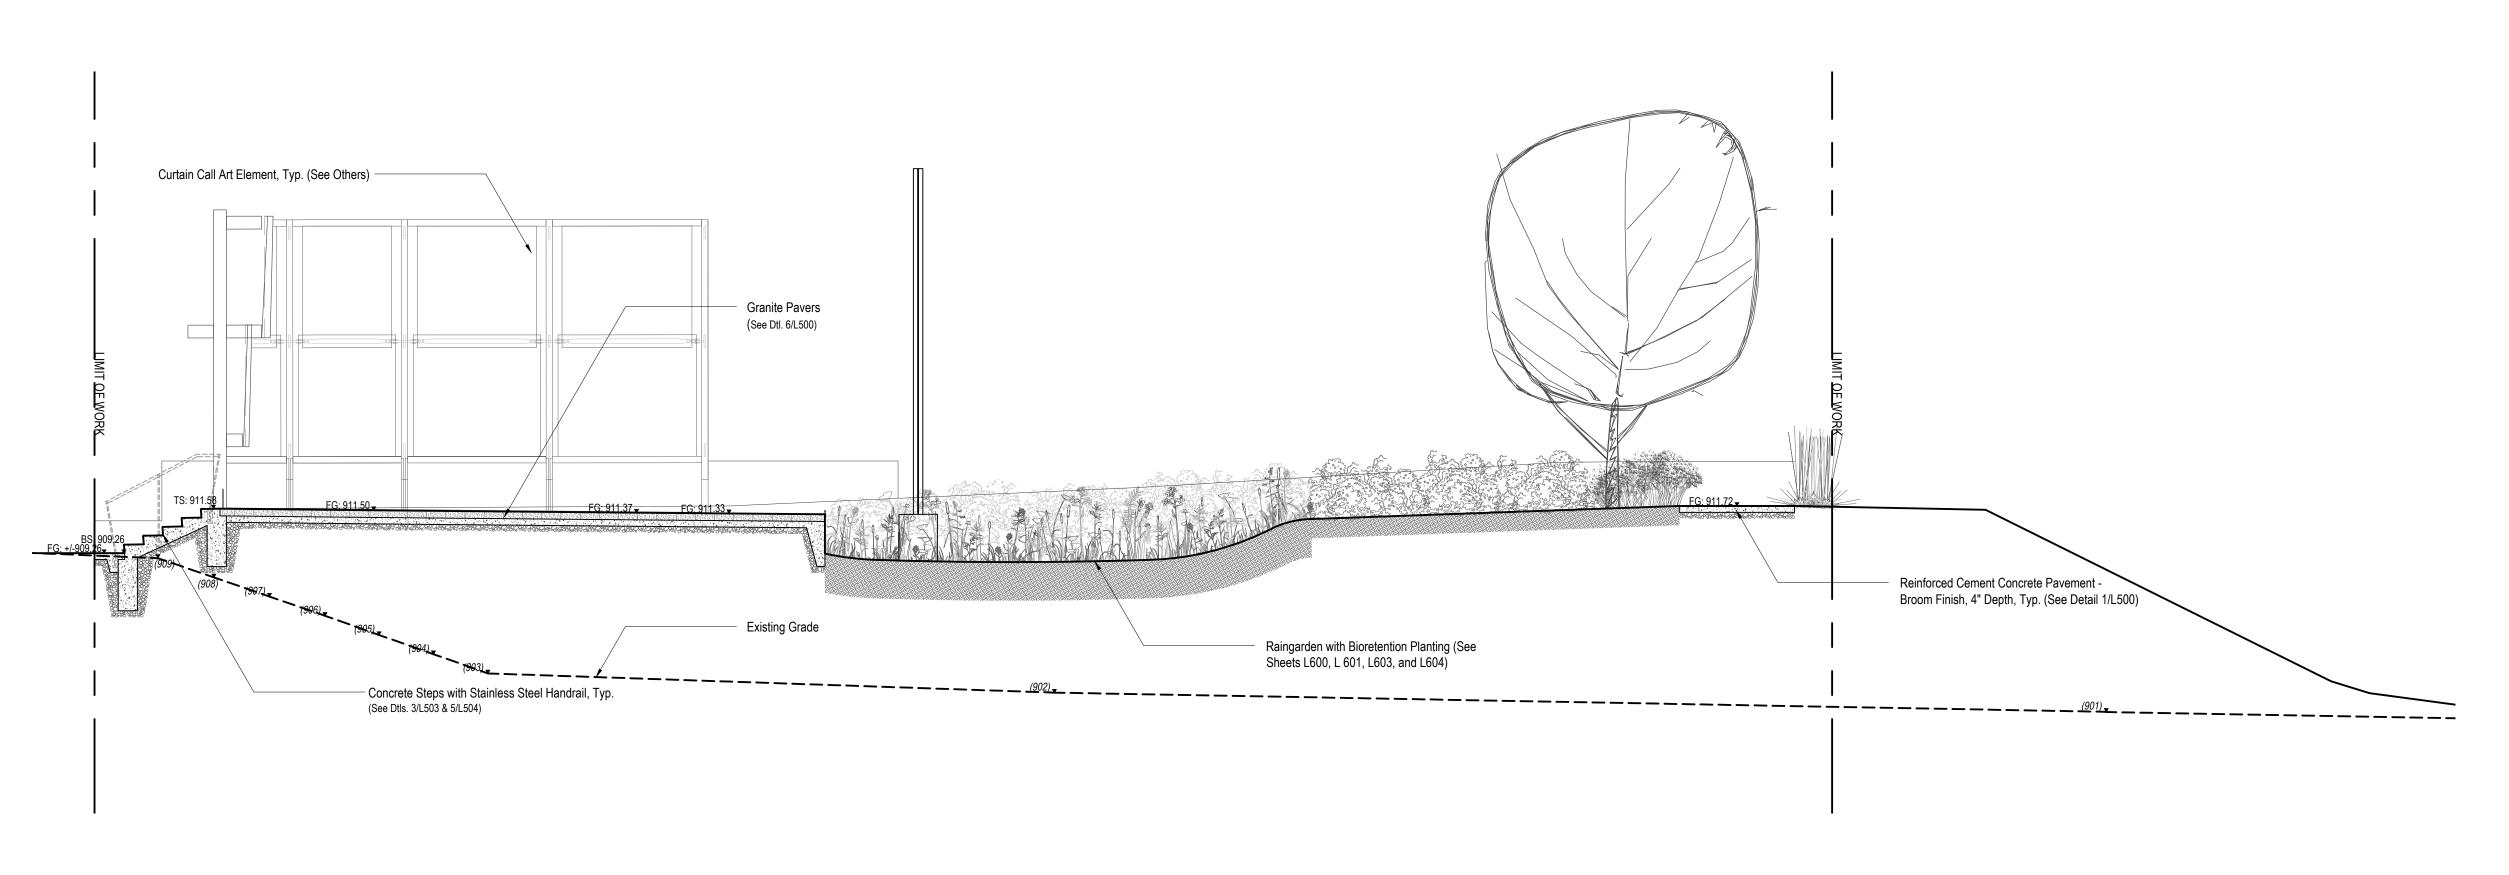
Site Sections

Submission:

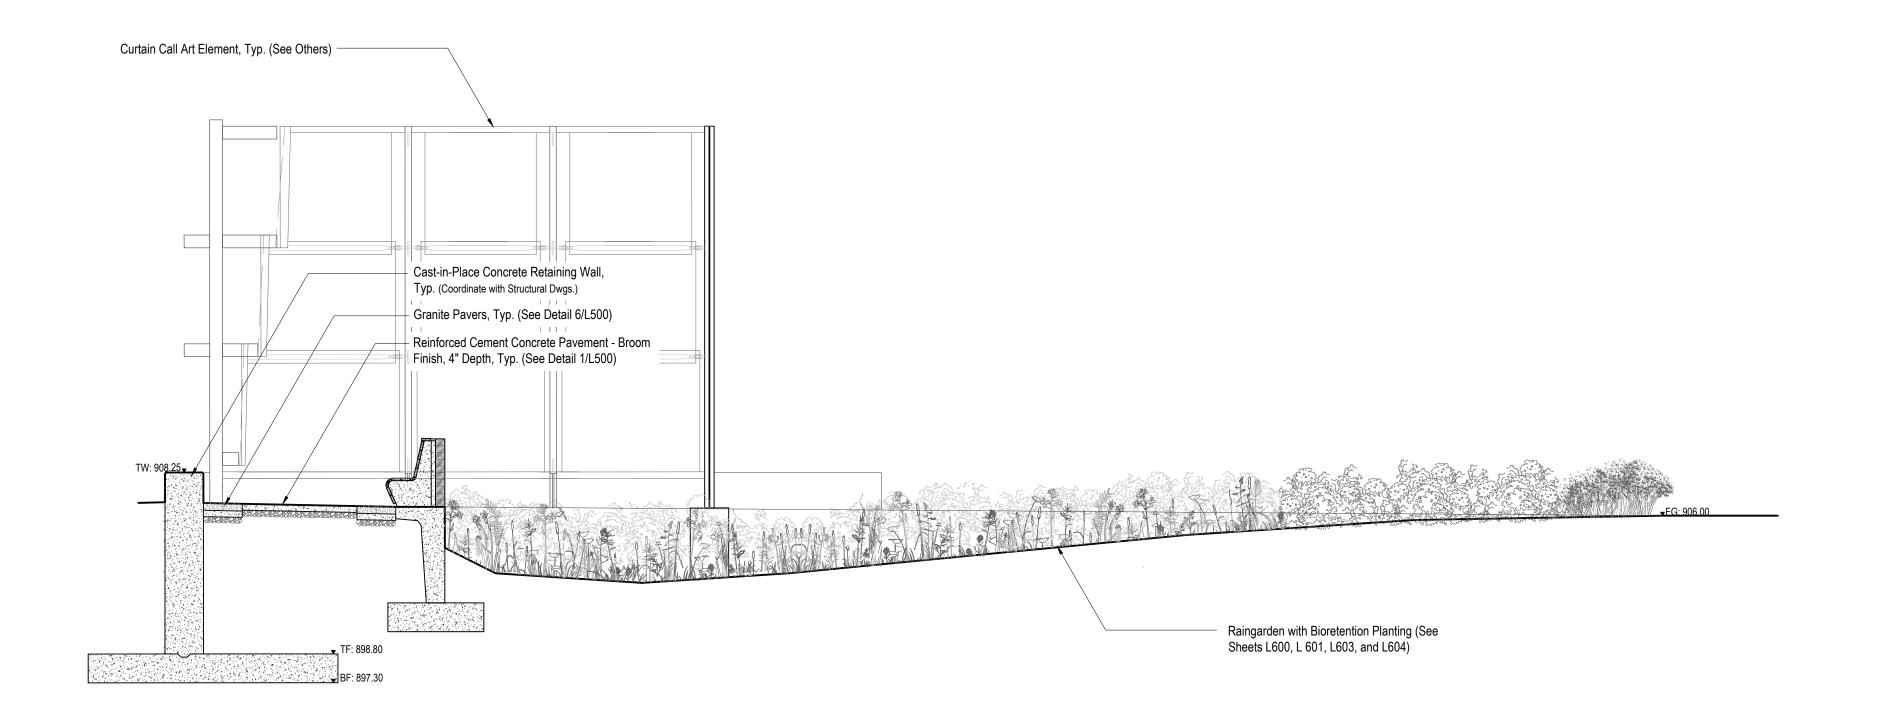
100% Construction Documents

Sheet Number:

L407











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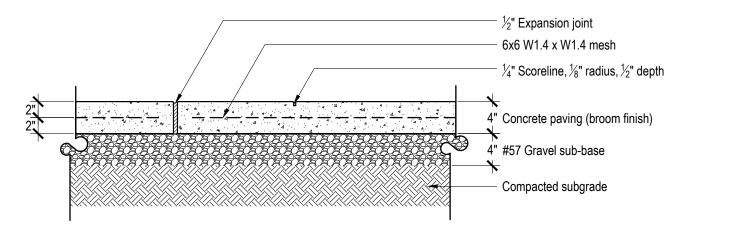
Site Sections

Submission:

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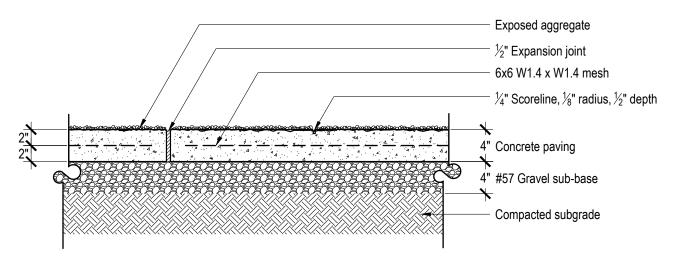
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408




Reinforced Cement Concrete Pavement - Broom Finish, 4" Depth

Scale: 1"=1'-0"




Reinforced Cement Concrete Pavement - Exposed Aggregate, 4" Depth

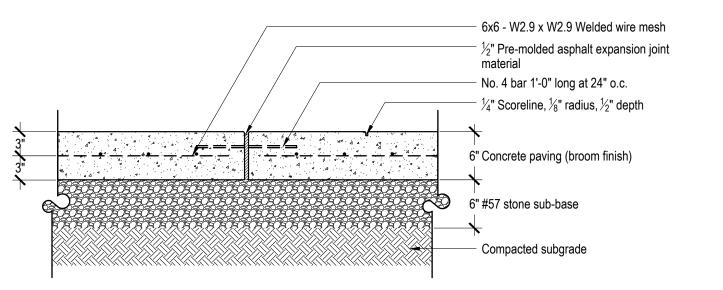Scale: 1"=1'-0"




Reinforced Cement Concrete Pavement - Broom Finish, 6" Depth

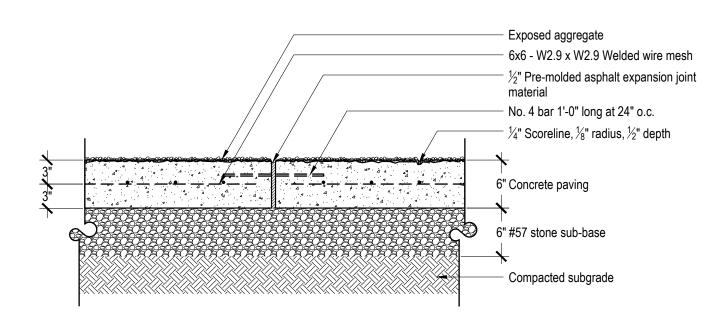Scale: 1"=1'-0"




Reinforced Cement Concrete Pavement - Exposed Aggregate, 6" Depth

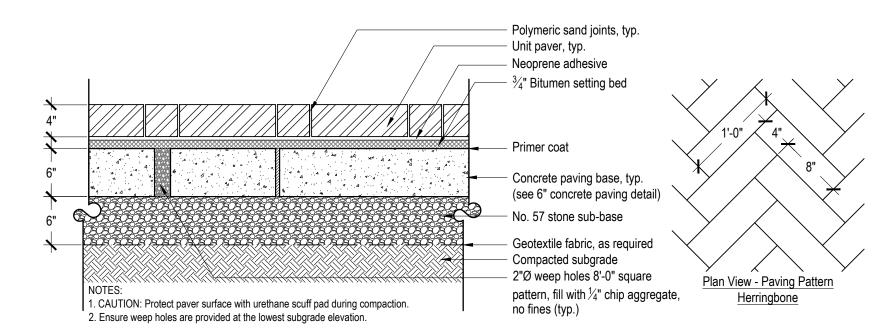Scale: 1"=1'-0"




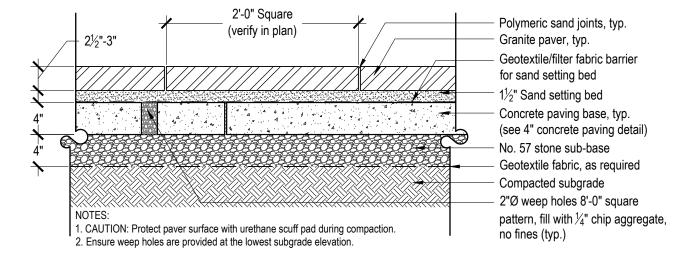5 Unit Paver Detail
L500 Scale: 1"=1'-0"



6 Granite Paver Detail

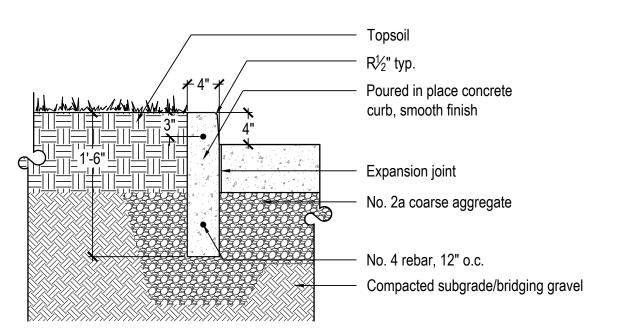Scale: 1"=1'-0"



7 Poured In Place Concrete Planter Curb

Scale: 1"=1'-0"



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Site Details

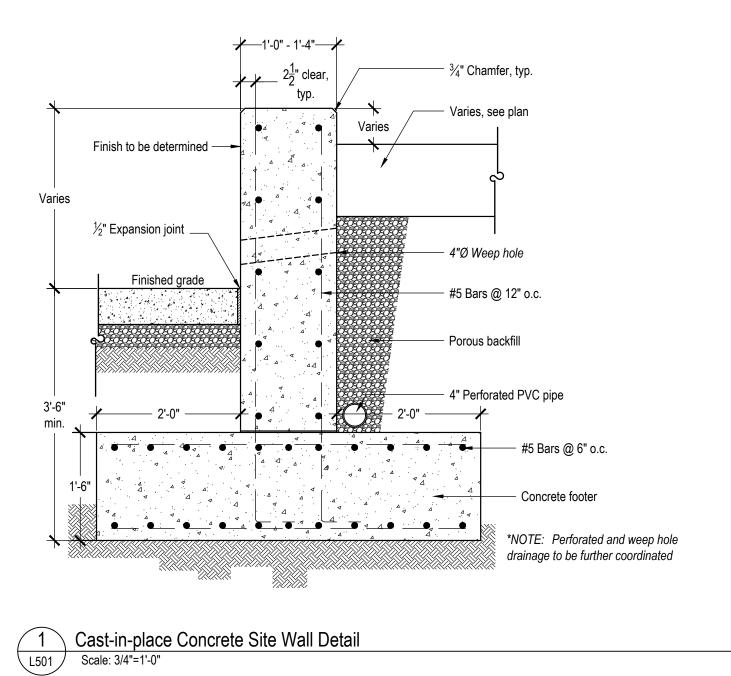
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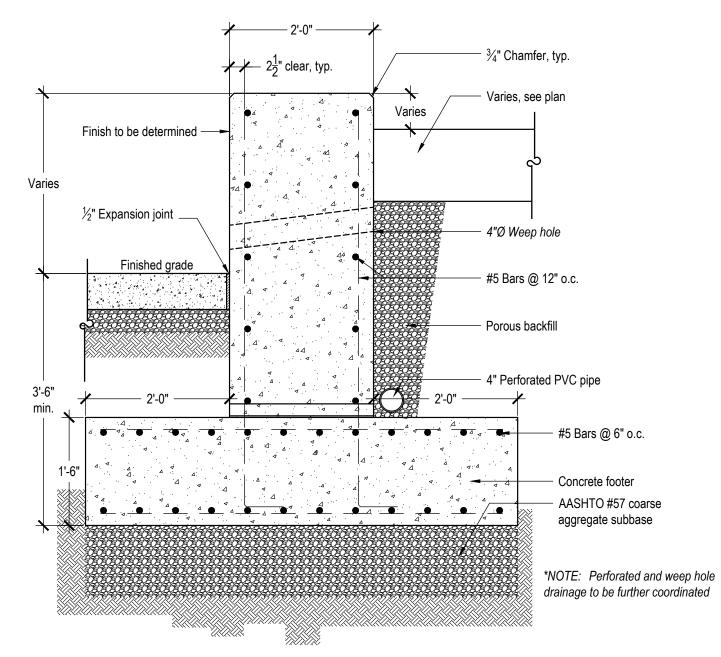
100% Construction Documents

Sheet Number:

_500

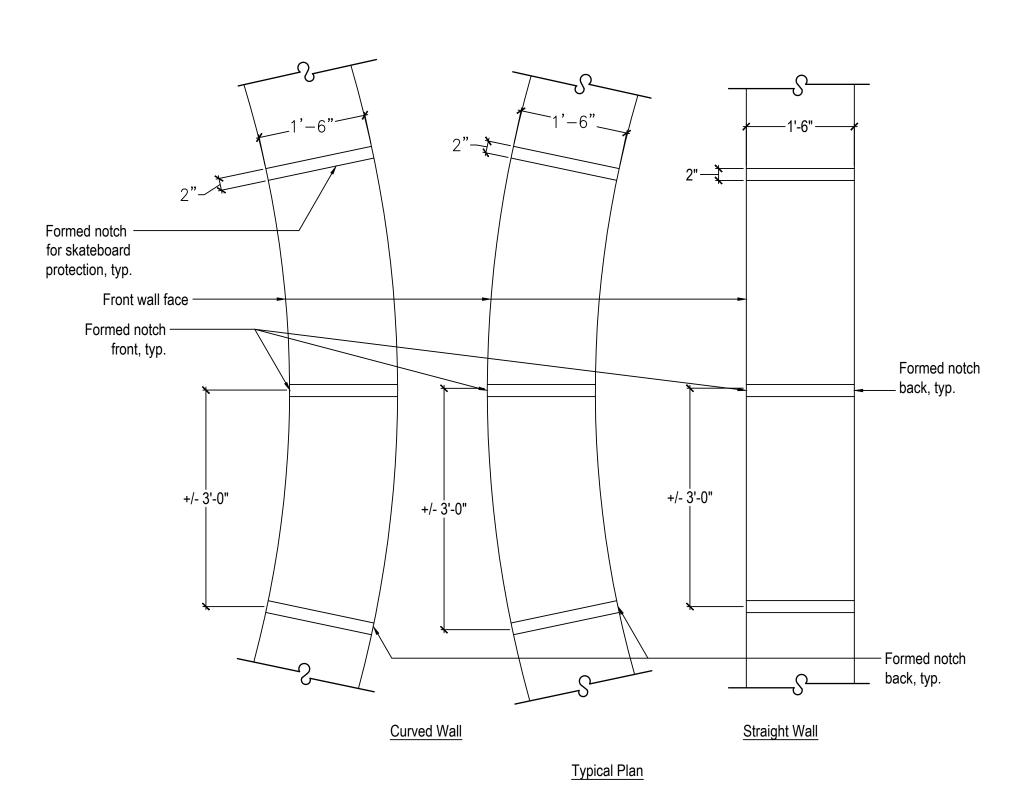
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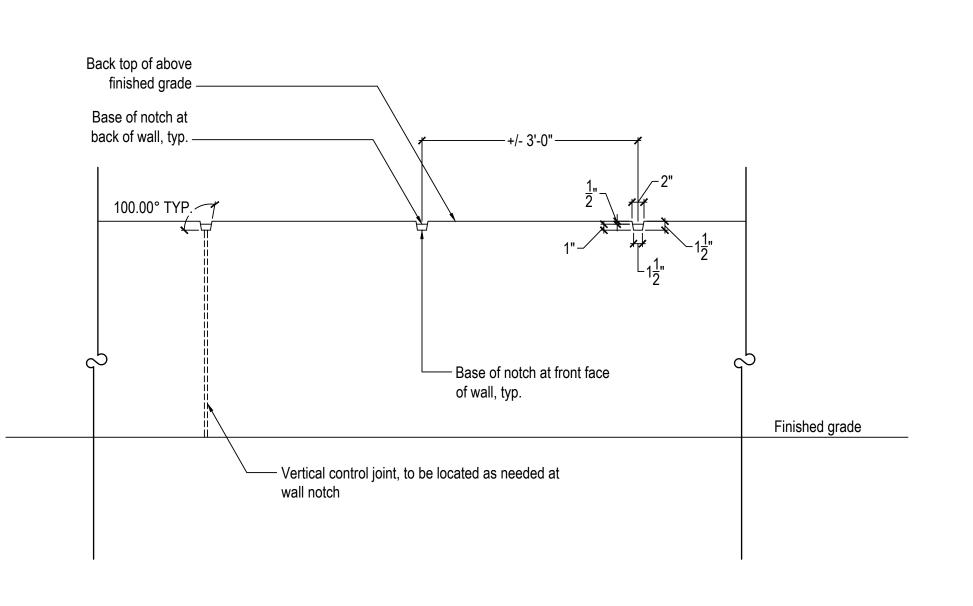





2 Cast-in-place Concrete Site Wall Detail

Scale: 3/4"=1'-0"





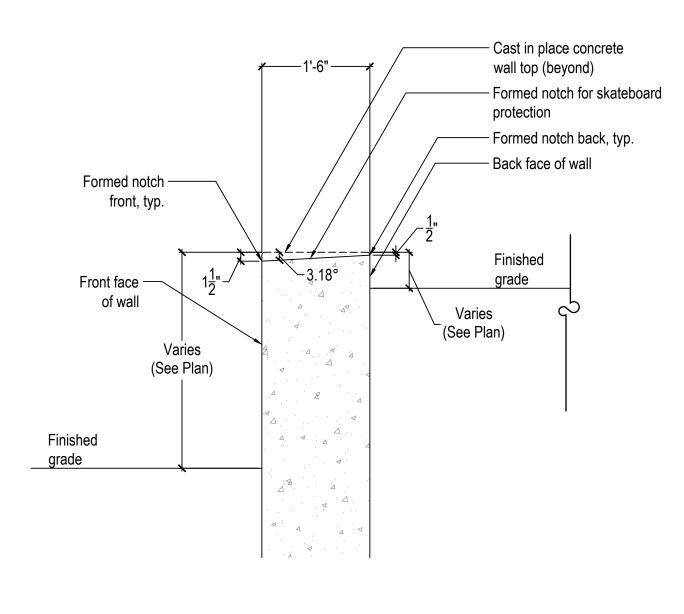Elevation



3 Cast-In-Place Concrete Wall Notch

Scale: 3/4"=1'-0"

Section



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Scale: as noted

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Sheet Name:


Site Details


Submission:

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Sheet Number:

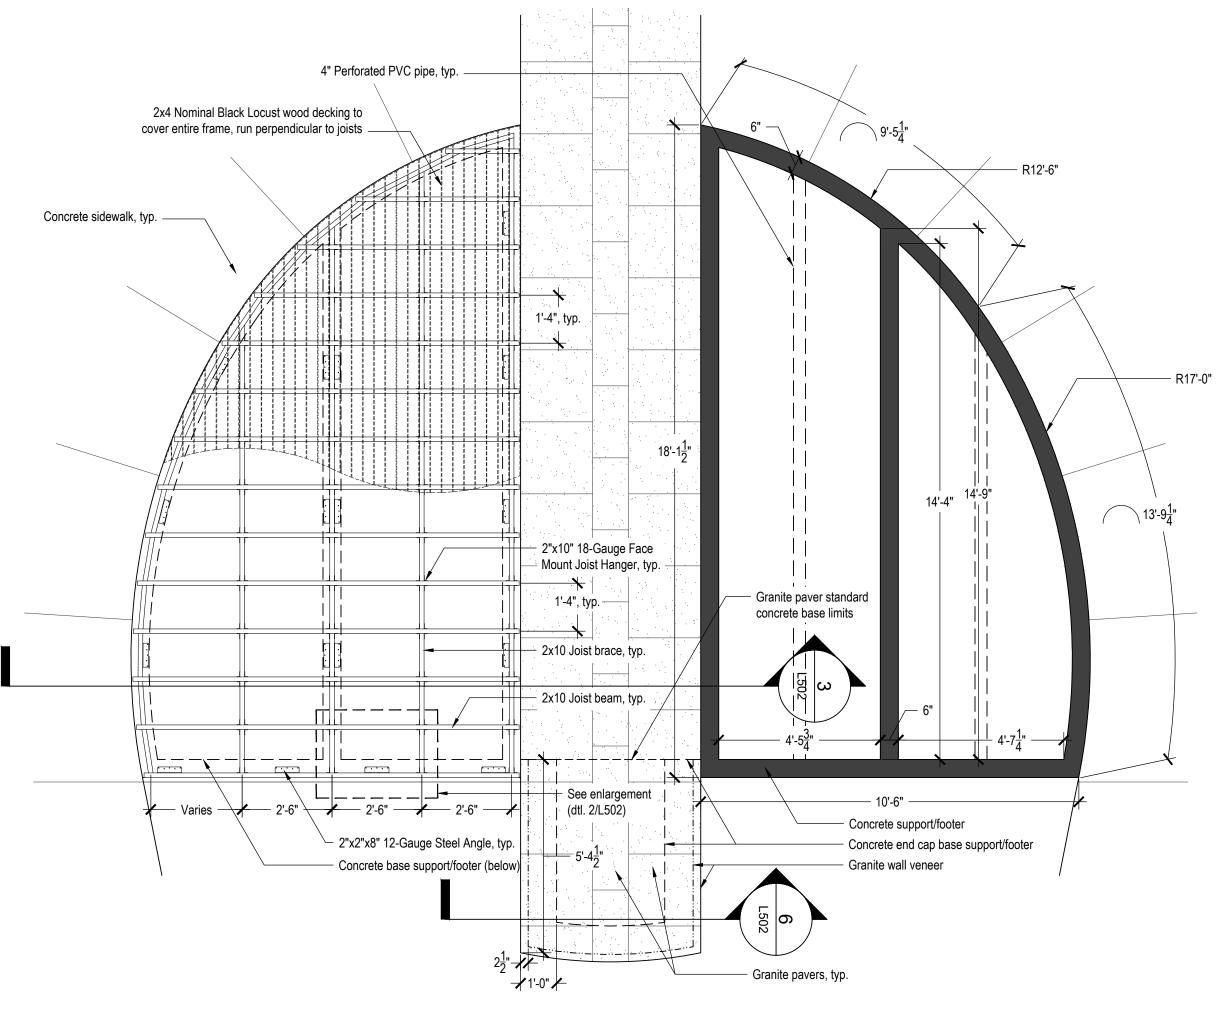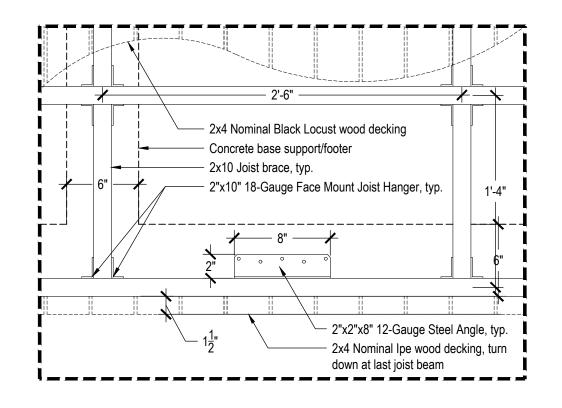
501





Deck Frame Enlarged Plan

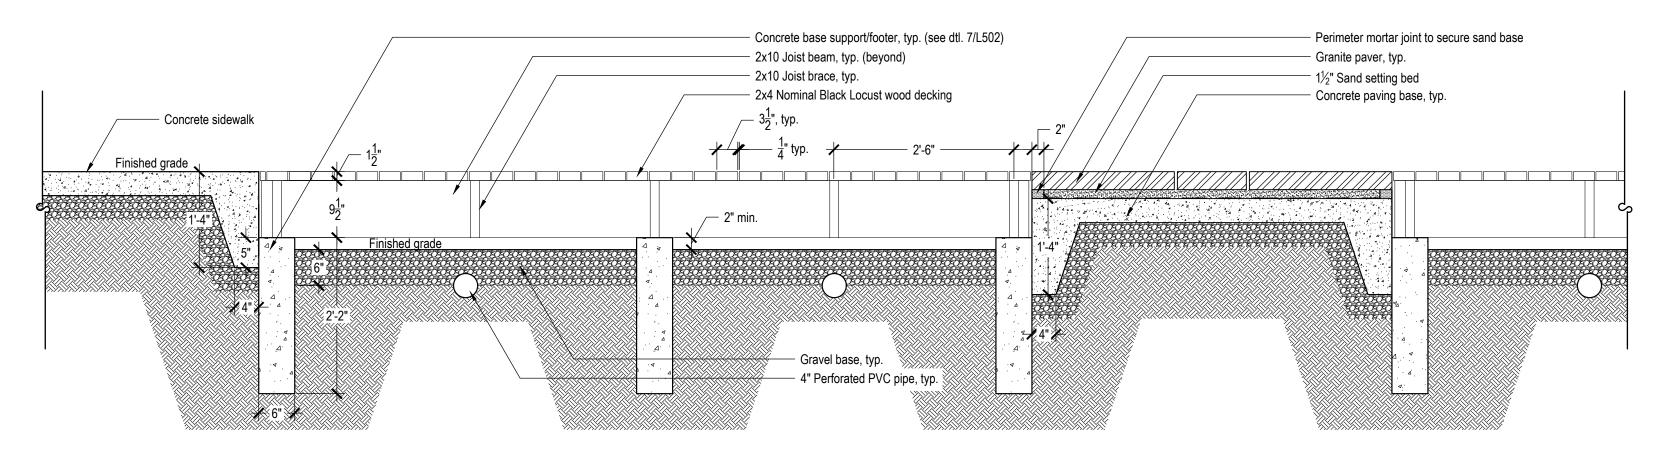
Scale: 1 1/2"=1'-0"





Deck | Granite Pier Detailed Plan


Scale: 1/32"=1'-0"

3 Deck | Granite Pier Section Detail
| Scale: 3/4"=1'-0"

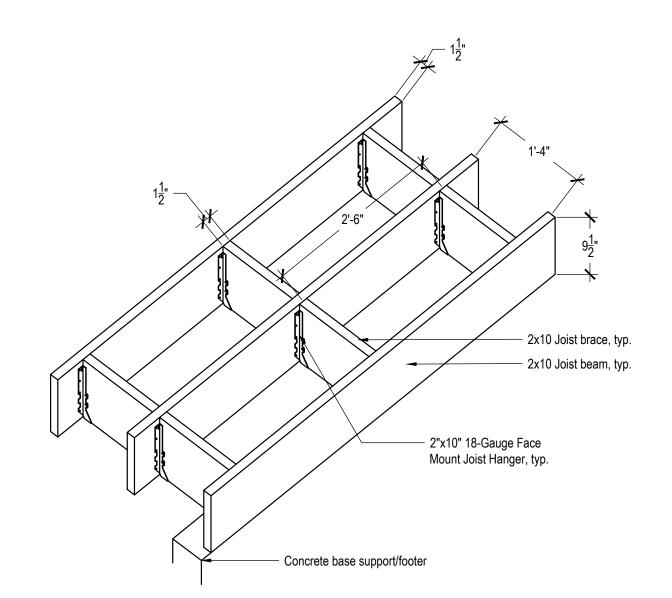

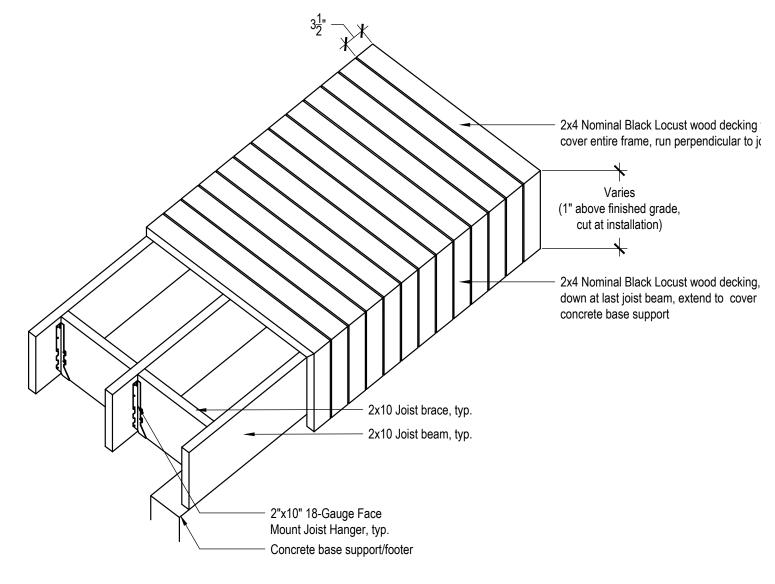

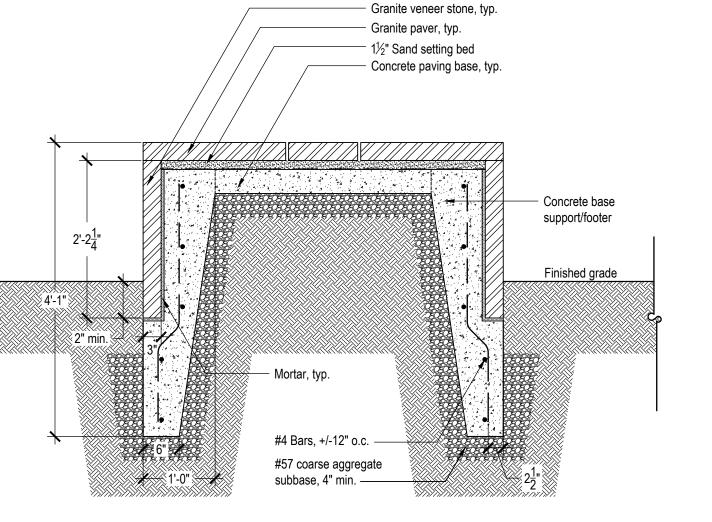

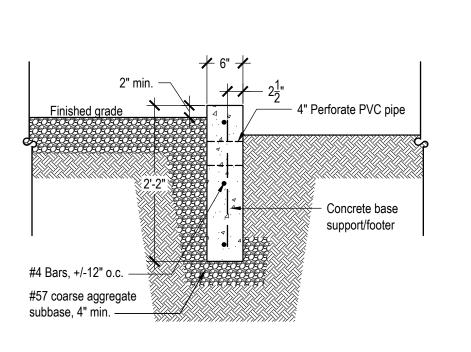

Deck Frame Detail

Scale: 3/4"=1'-0"

5 Deck Frame/Cover Detail
L502 Scale: 3/4"=1'-0"

6 Granite Paver Pier Detail
L502 Scale: 3/4"=1'-0"

7 Concrete Base Support/Footer Detail

Scale: 3/4"=1'-0"



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JPSTUDIO LANDSCAPES



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Date: **April 28, 2023**

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Scale:

Sheet Name:

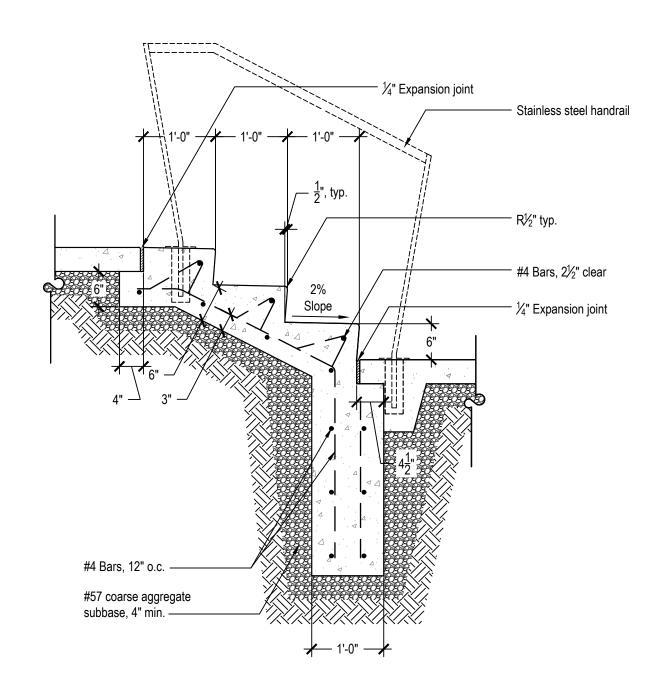
Site Details

Submission:

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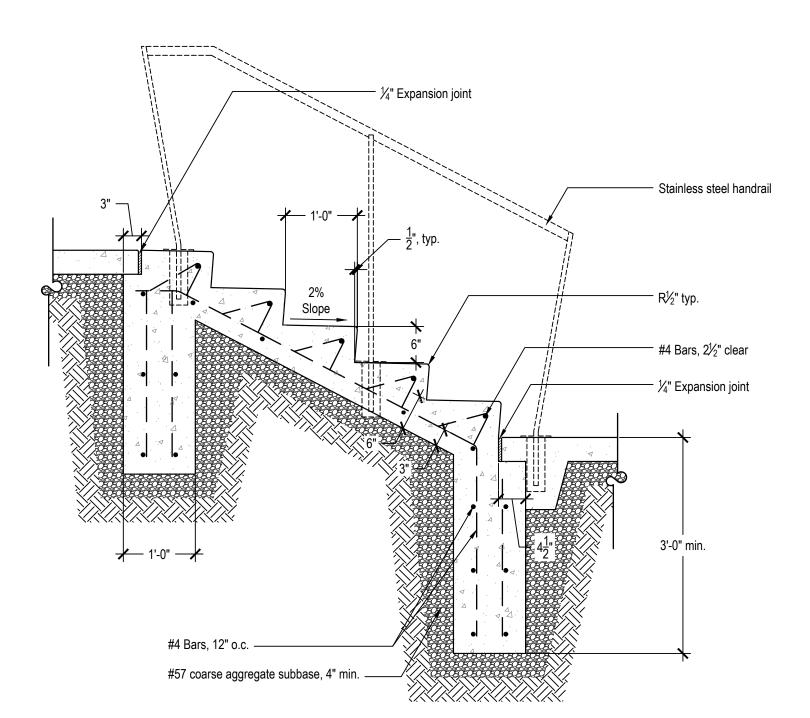
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L502




Poured In Place Concrete Stairs - Broom Finish - Three Steps

Scale: 3/4"=1'-0"




Poured In Place Concrete Stairs - Broom Finish - Five Steps

| Scale: 3/4"=1'-0"

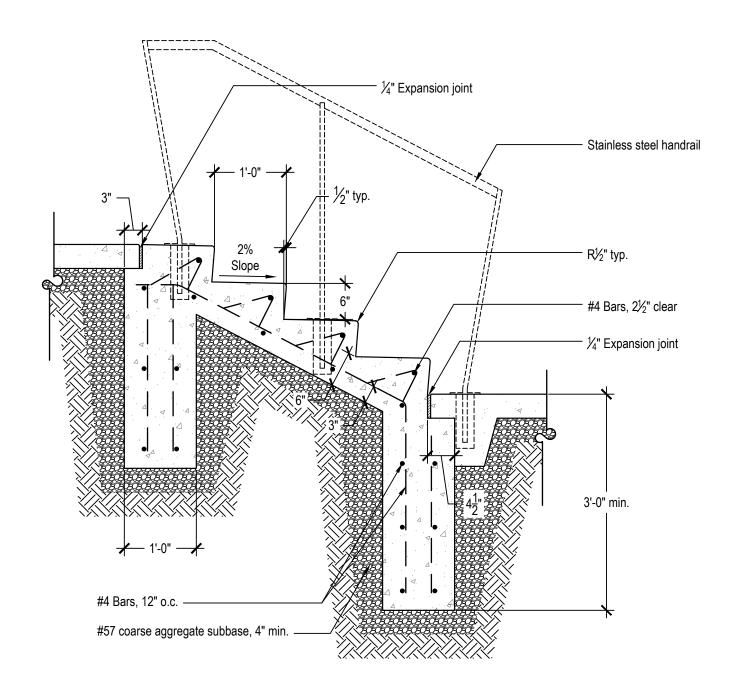

Poured In Place Concrete Stairs - Broom Finish - Four Steps

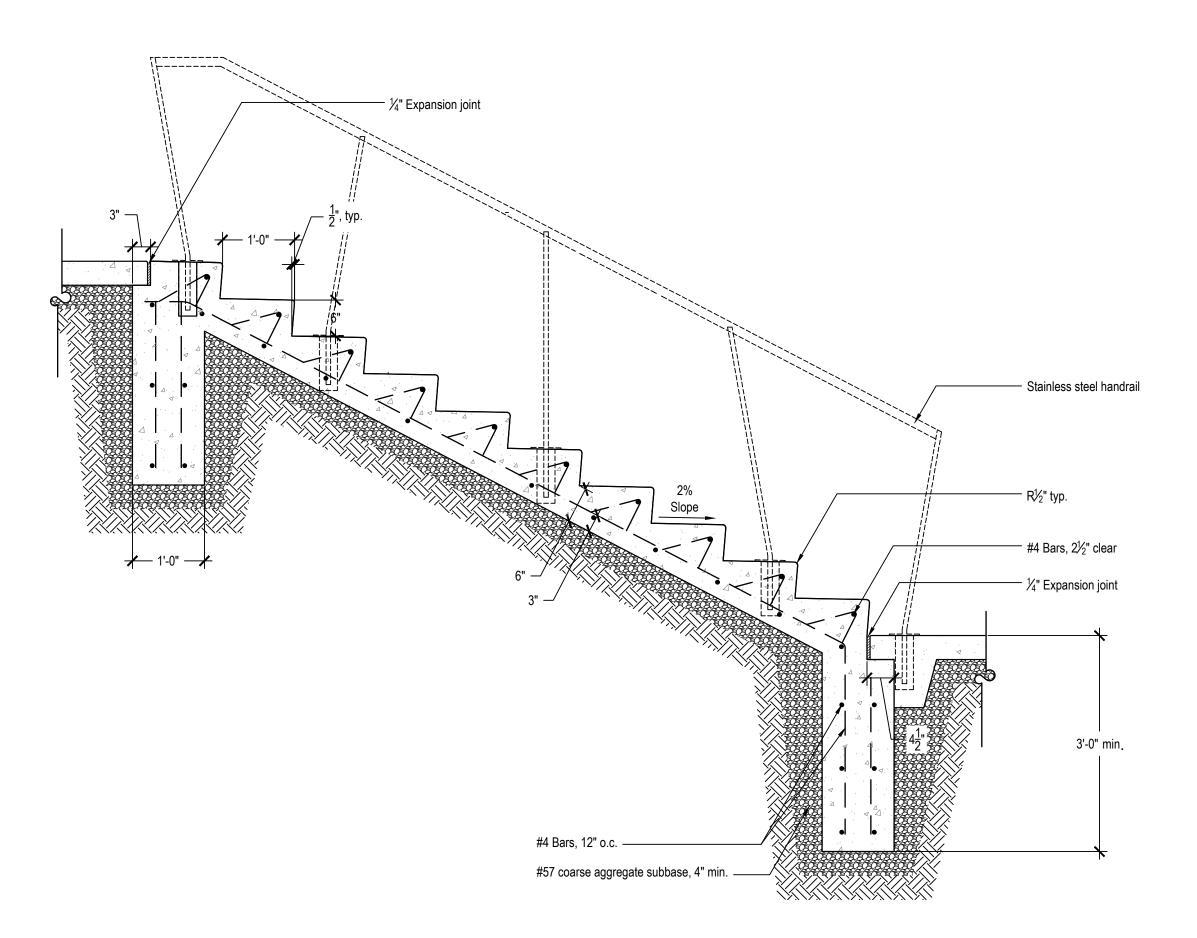Scale: 3/4"=1'-0"



Poured In Place Concrete Stairs - Broom Finish - Ten Steps

Scale: 3/4"=1'-0"



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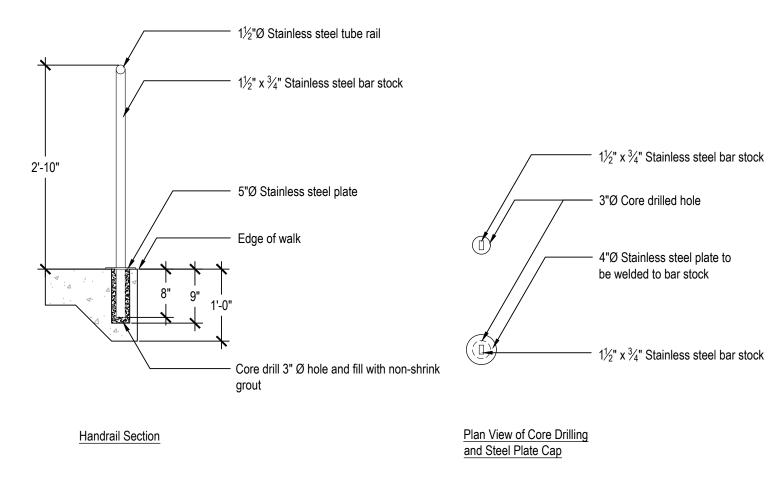
Site Details

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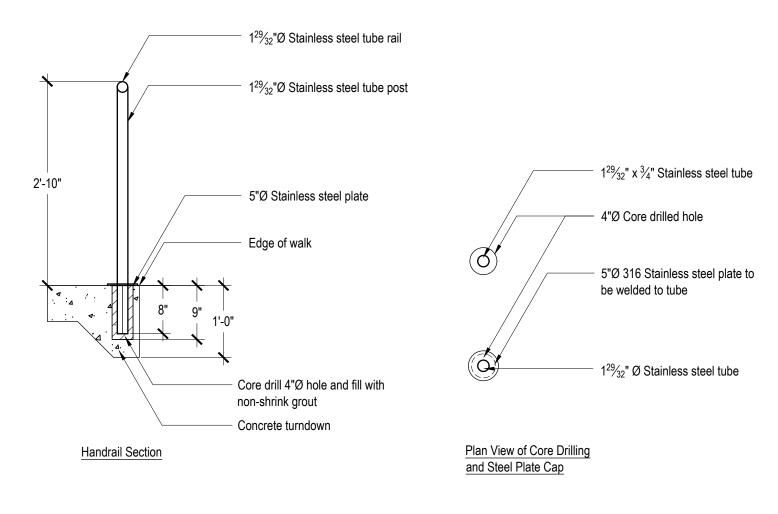
100% Construction Documents

Sheet Number:

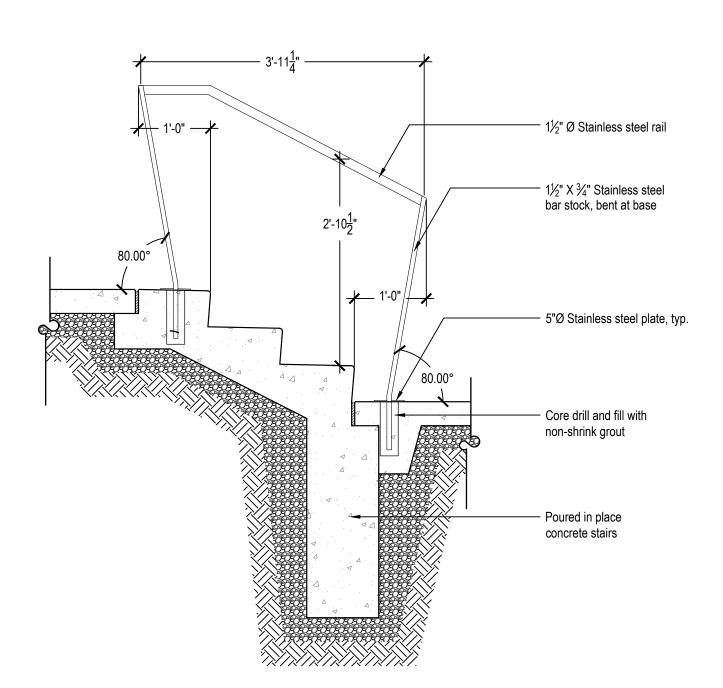
L503




1 Stainless Steel Stair Handrail L504 Scale: 3/4"=1'-0"



2 Illuminated Stair Handrail L504 Scale: 3/4"=1'-0"




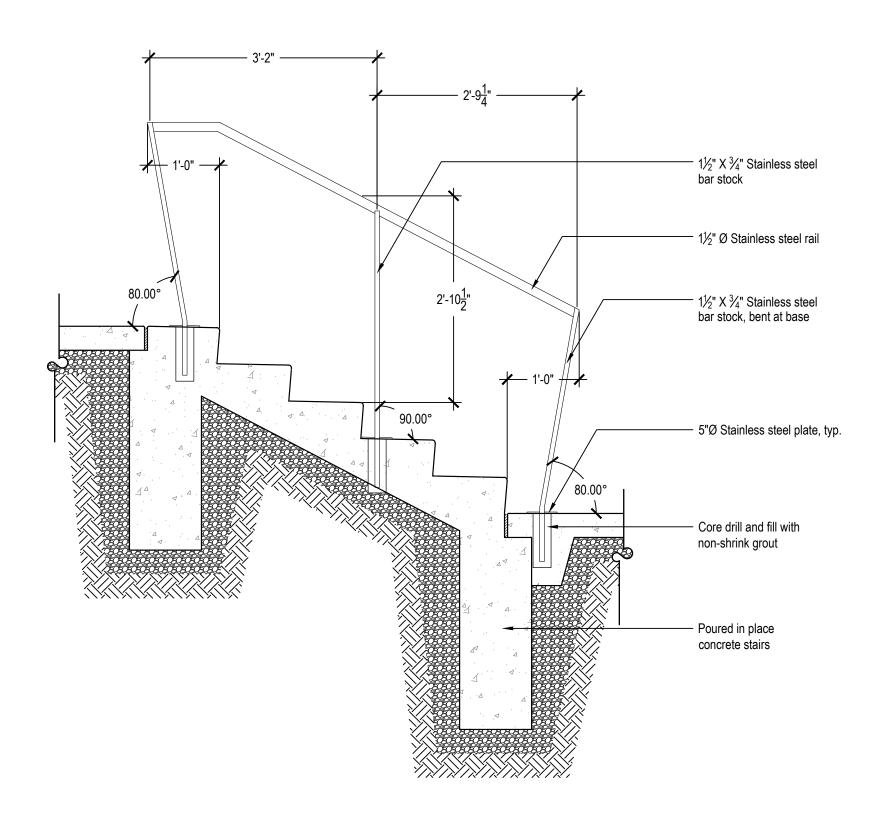3 Stainless Steel Handrail - Three Steps L504 Scale: 3/4"=1'-0"




5 Stainless Steel Handrail - Five Steps

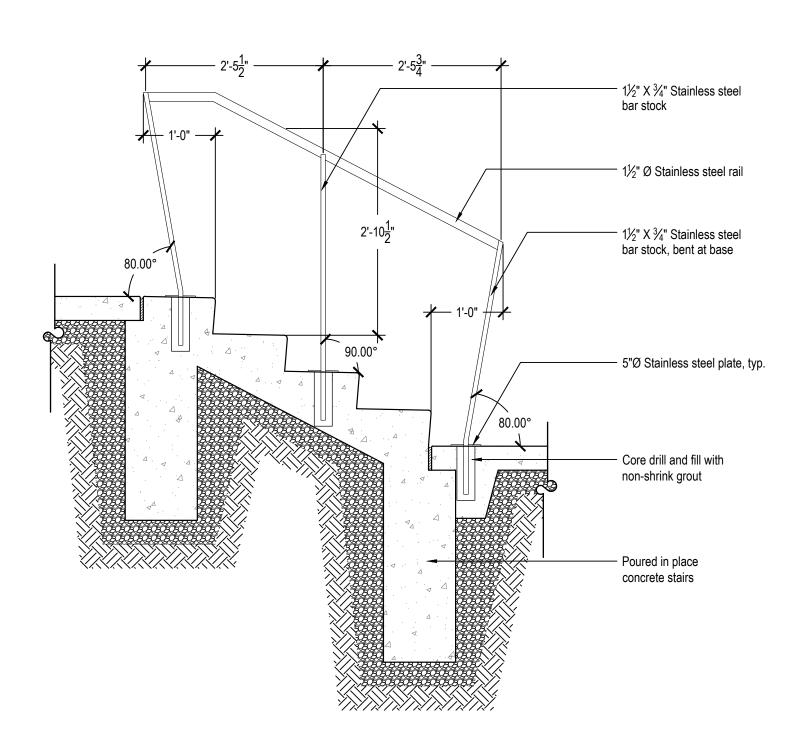Scale: 3/4"=1'-0"



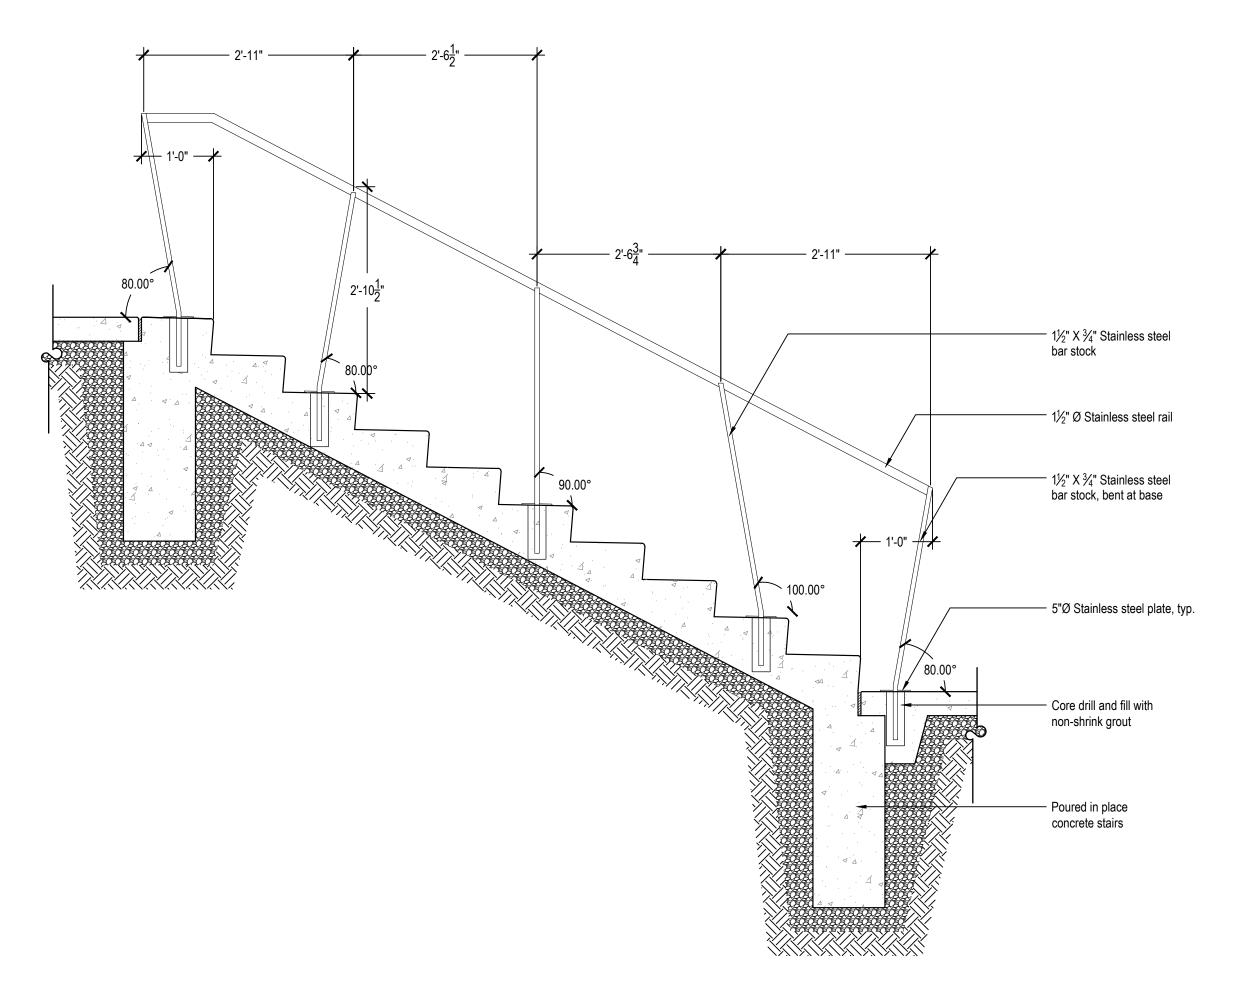4 Stainless Steel Handrail - Four Steps L504 Scale: 3/4"=1'-0"



6 Stainless Steel Handrail - Ten Steps L504 Scale: 3/4"=1'-0"



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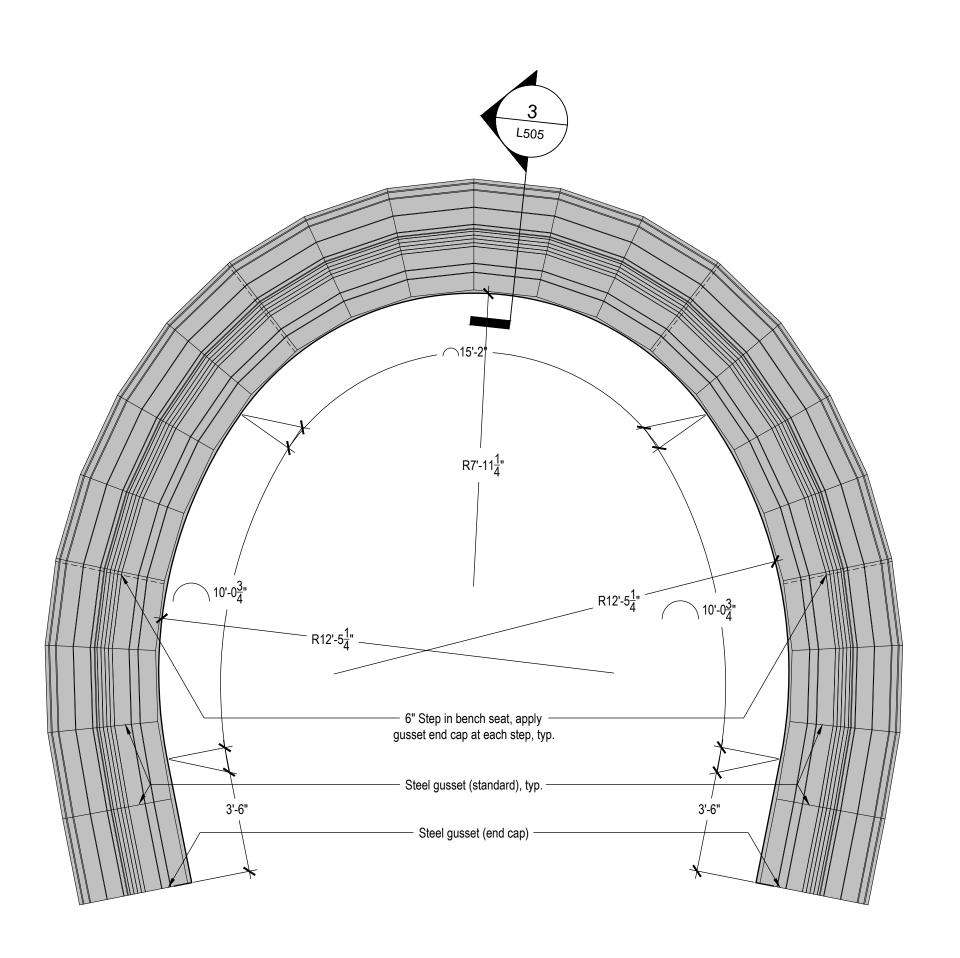
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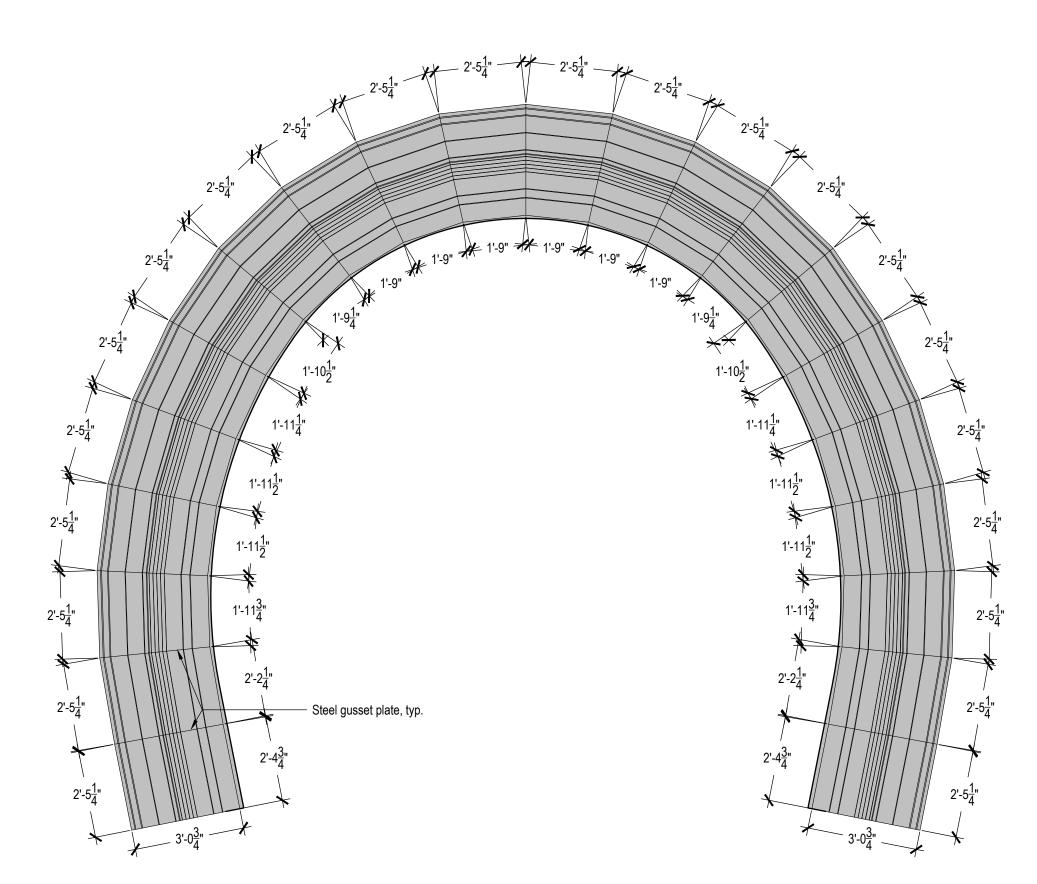
Submission:

100% Construction Documents

Sheet Number:

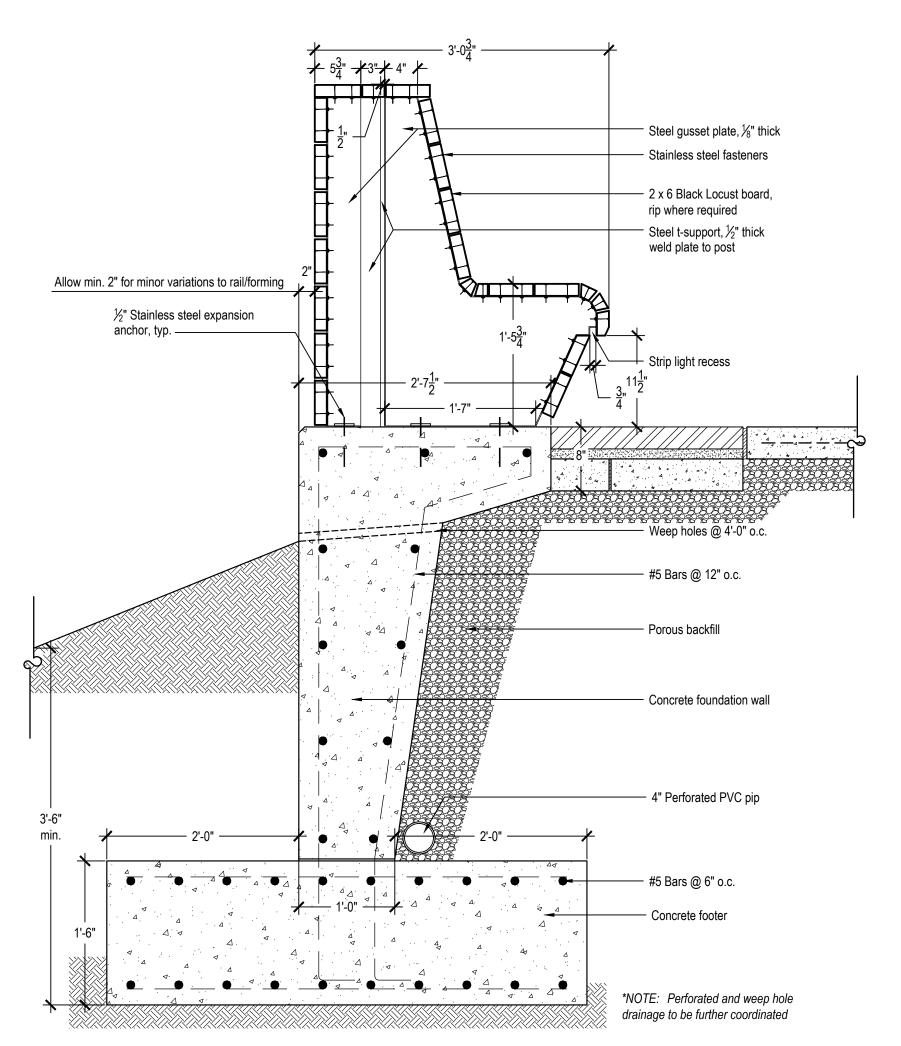


1 Bench - Plan Layout
L505 Scale: 1/2"=1'-0"




Bench - Plan Layout


L505 Scale: 1/32"=1'-0"




3 Bench Detail L505 Scale: 1"=1'-0"

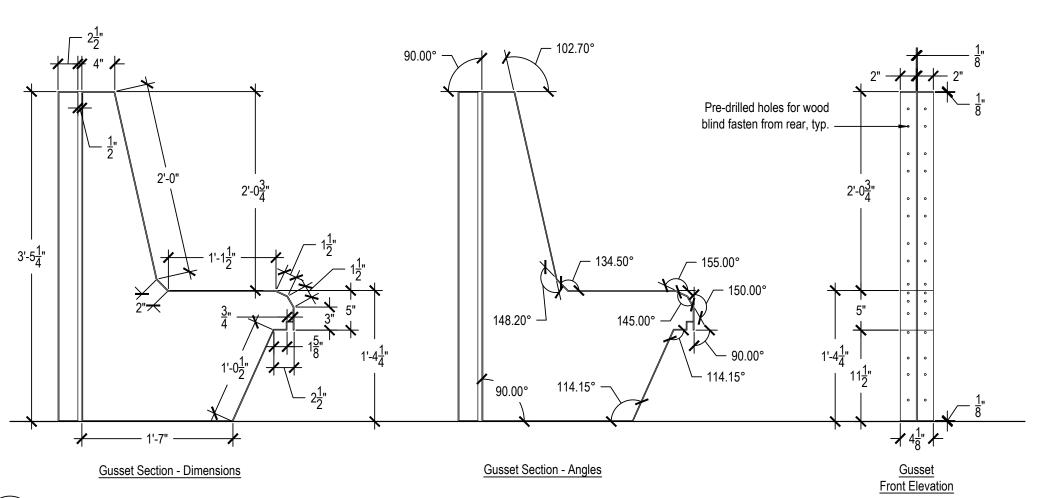


4 Gusset Detail
L505 Scale: 1"=1'-0"

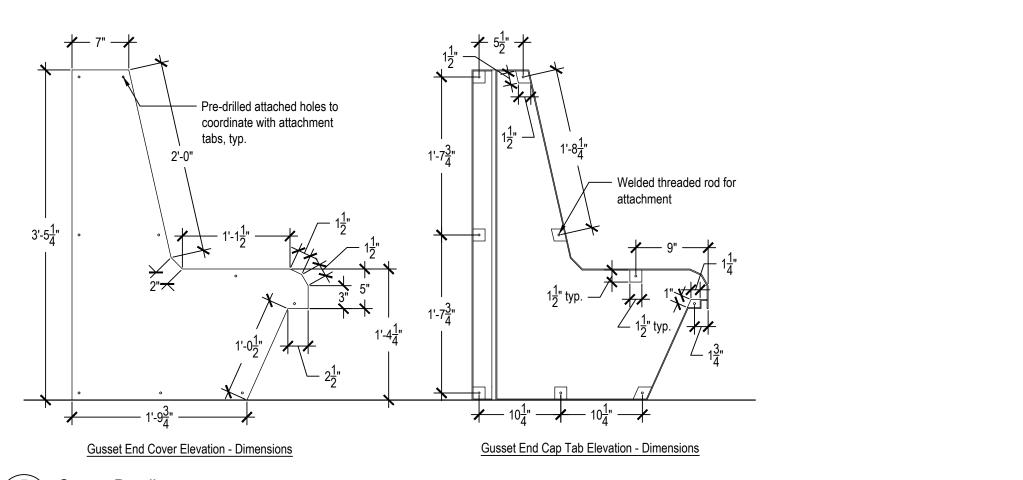

5 Gusset Detail
L505 Scale: 1"=1'-0"

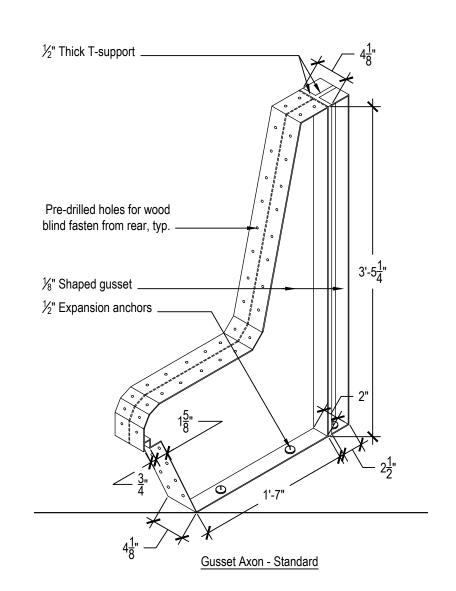

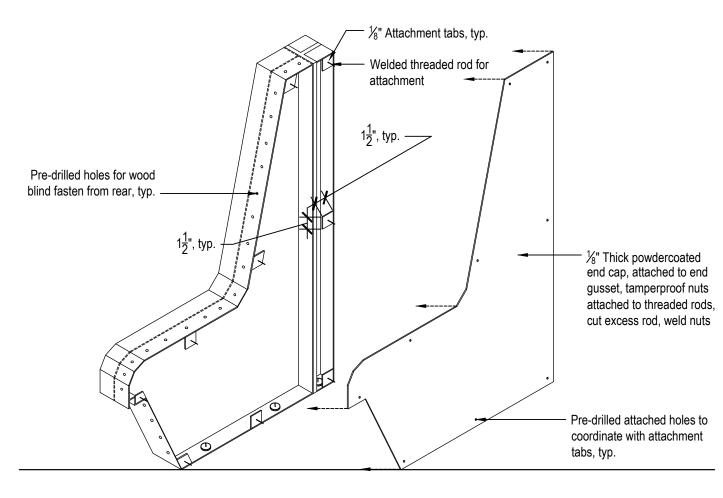

Gusset Axon - End Cap

Gusset Detail
L505 Scale: 1"=1'-0"



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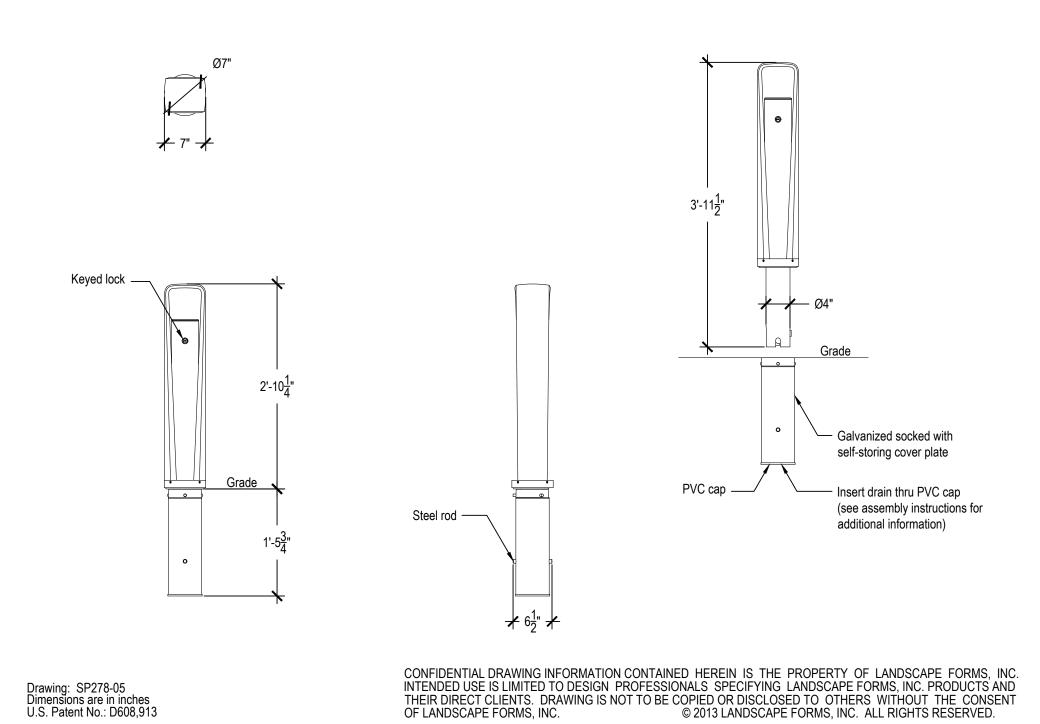
Site Details

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Sheet Number:


Bollard, Removable landscapeforms• www.landscapeforms.com Ph: 800.521.2546 Product Drawing



1 Removable Bollard - Landscape Forms | Stop™

L506 Scale: 3/4"=1'-0"

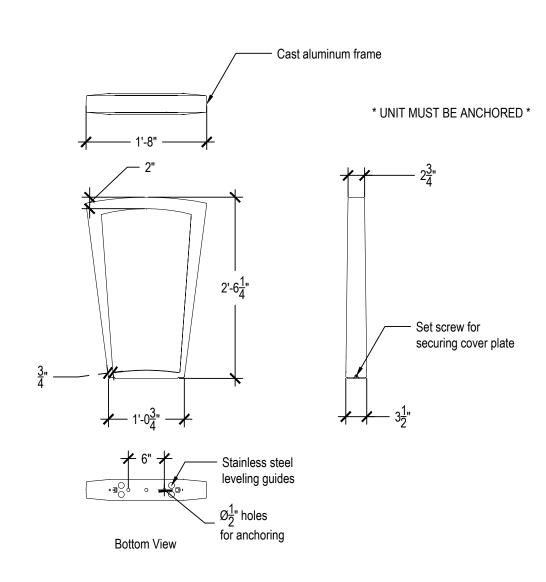Emerson Bike Rack, Surface Mount landscapeforms*
www.landscapeforms.com Ph: 800.521.2546 **Product Drawing**




Drawing: SP278-05 Dimensions are in inches U.S. Patent No.: D608,913

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2 Bike Rack - Landscape Forms | Emerson

L506 Scale: 3/4"=1'-0"





Trash Receptacle - Forms+Surfaces | Universal Scale: 3/4"=1'-0"

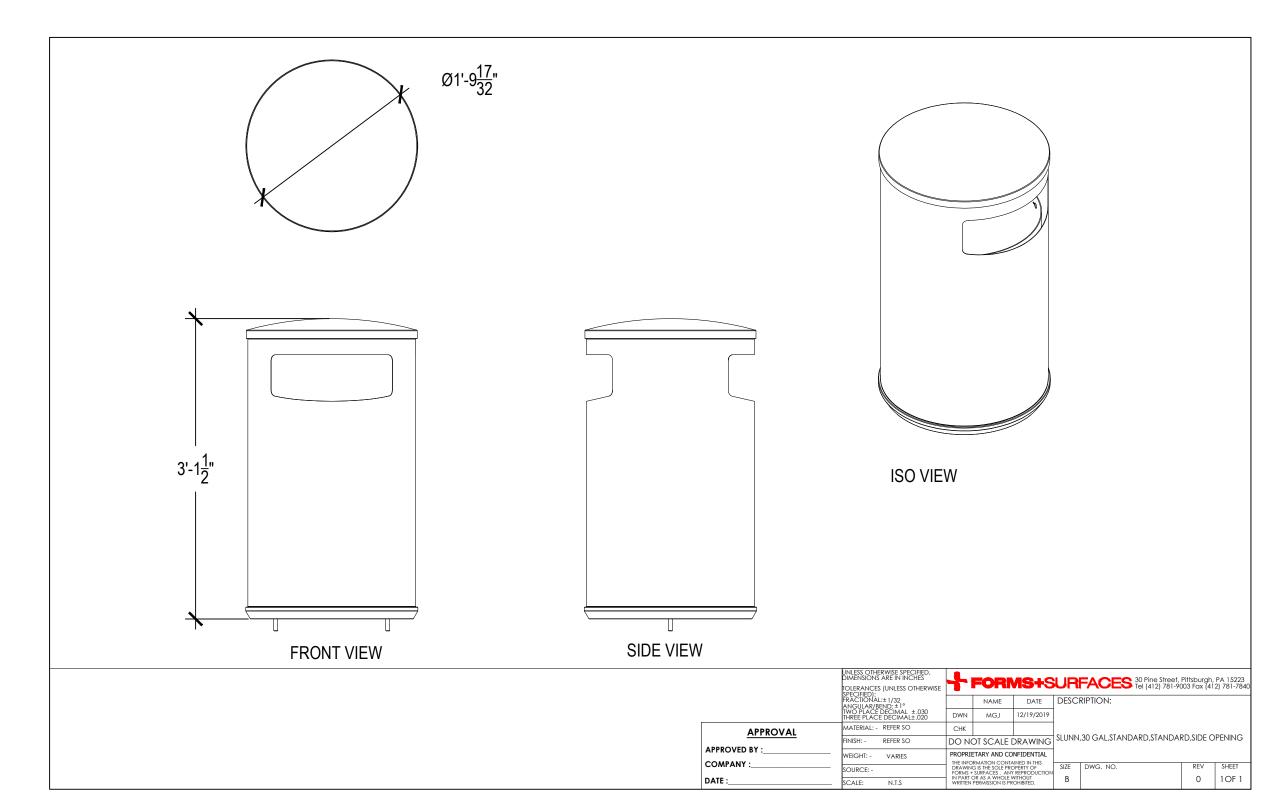Strata Beam bench, backed, 80in length, wood seating, two intermediate arms

landscapeforms• www.landscapeforms.com Ph: 800.521.2546

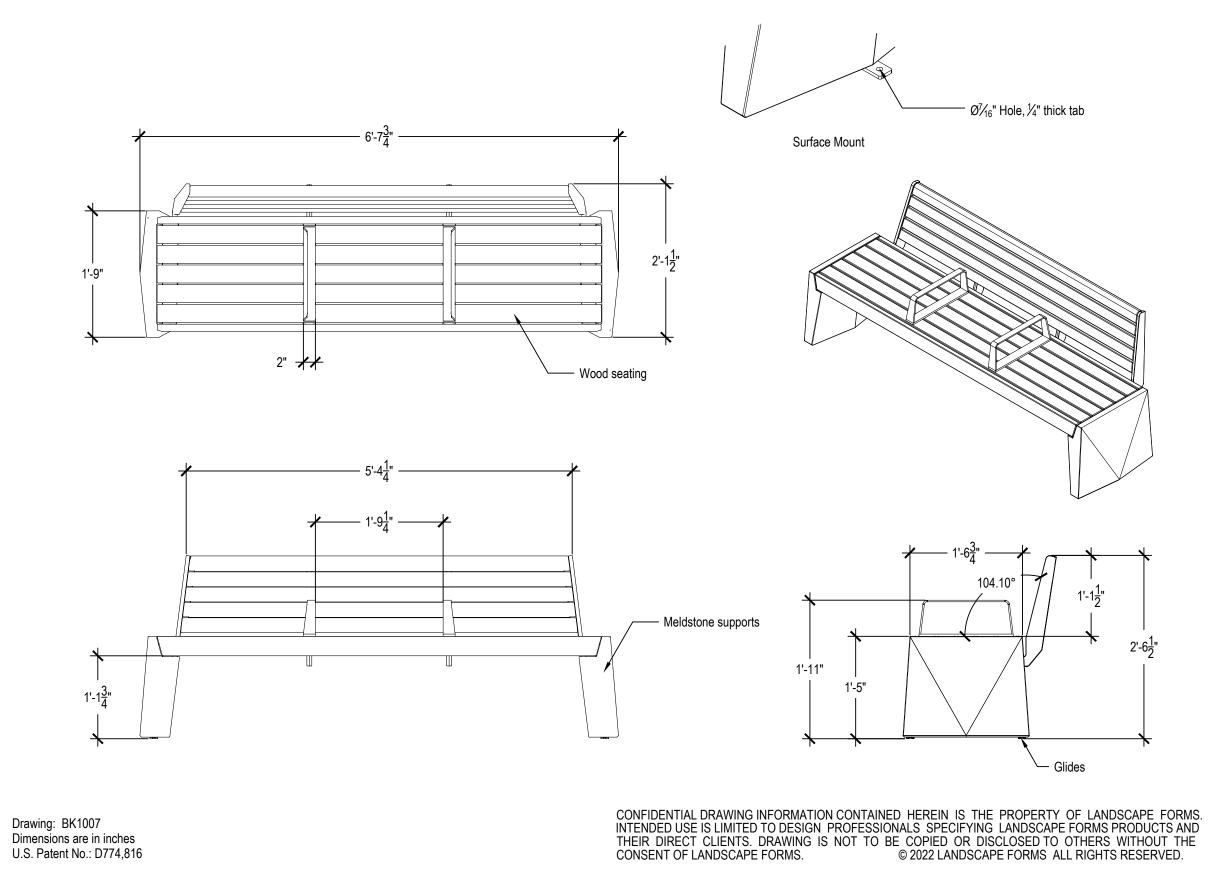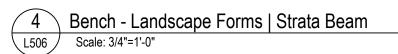Surface mount: with anchor tabs, anchoring hardware not included.







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Project Number:

Scale: as noted

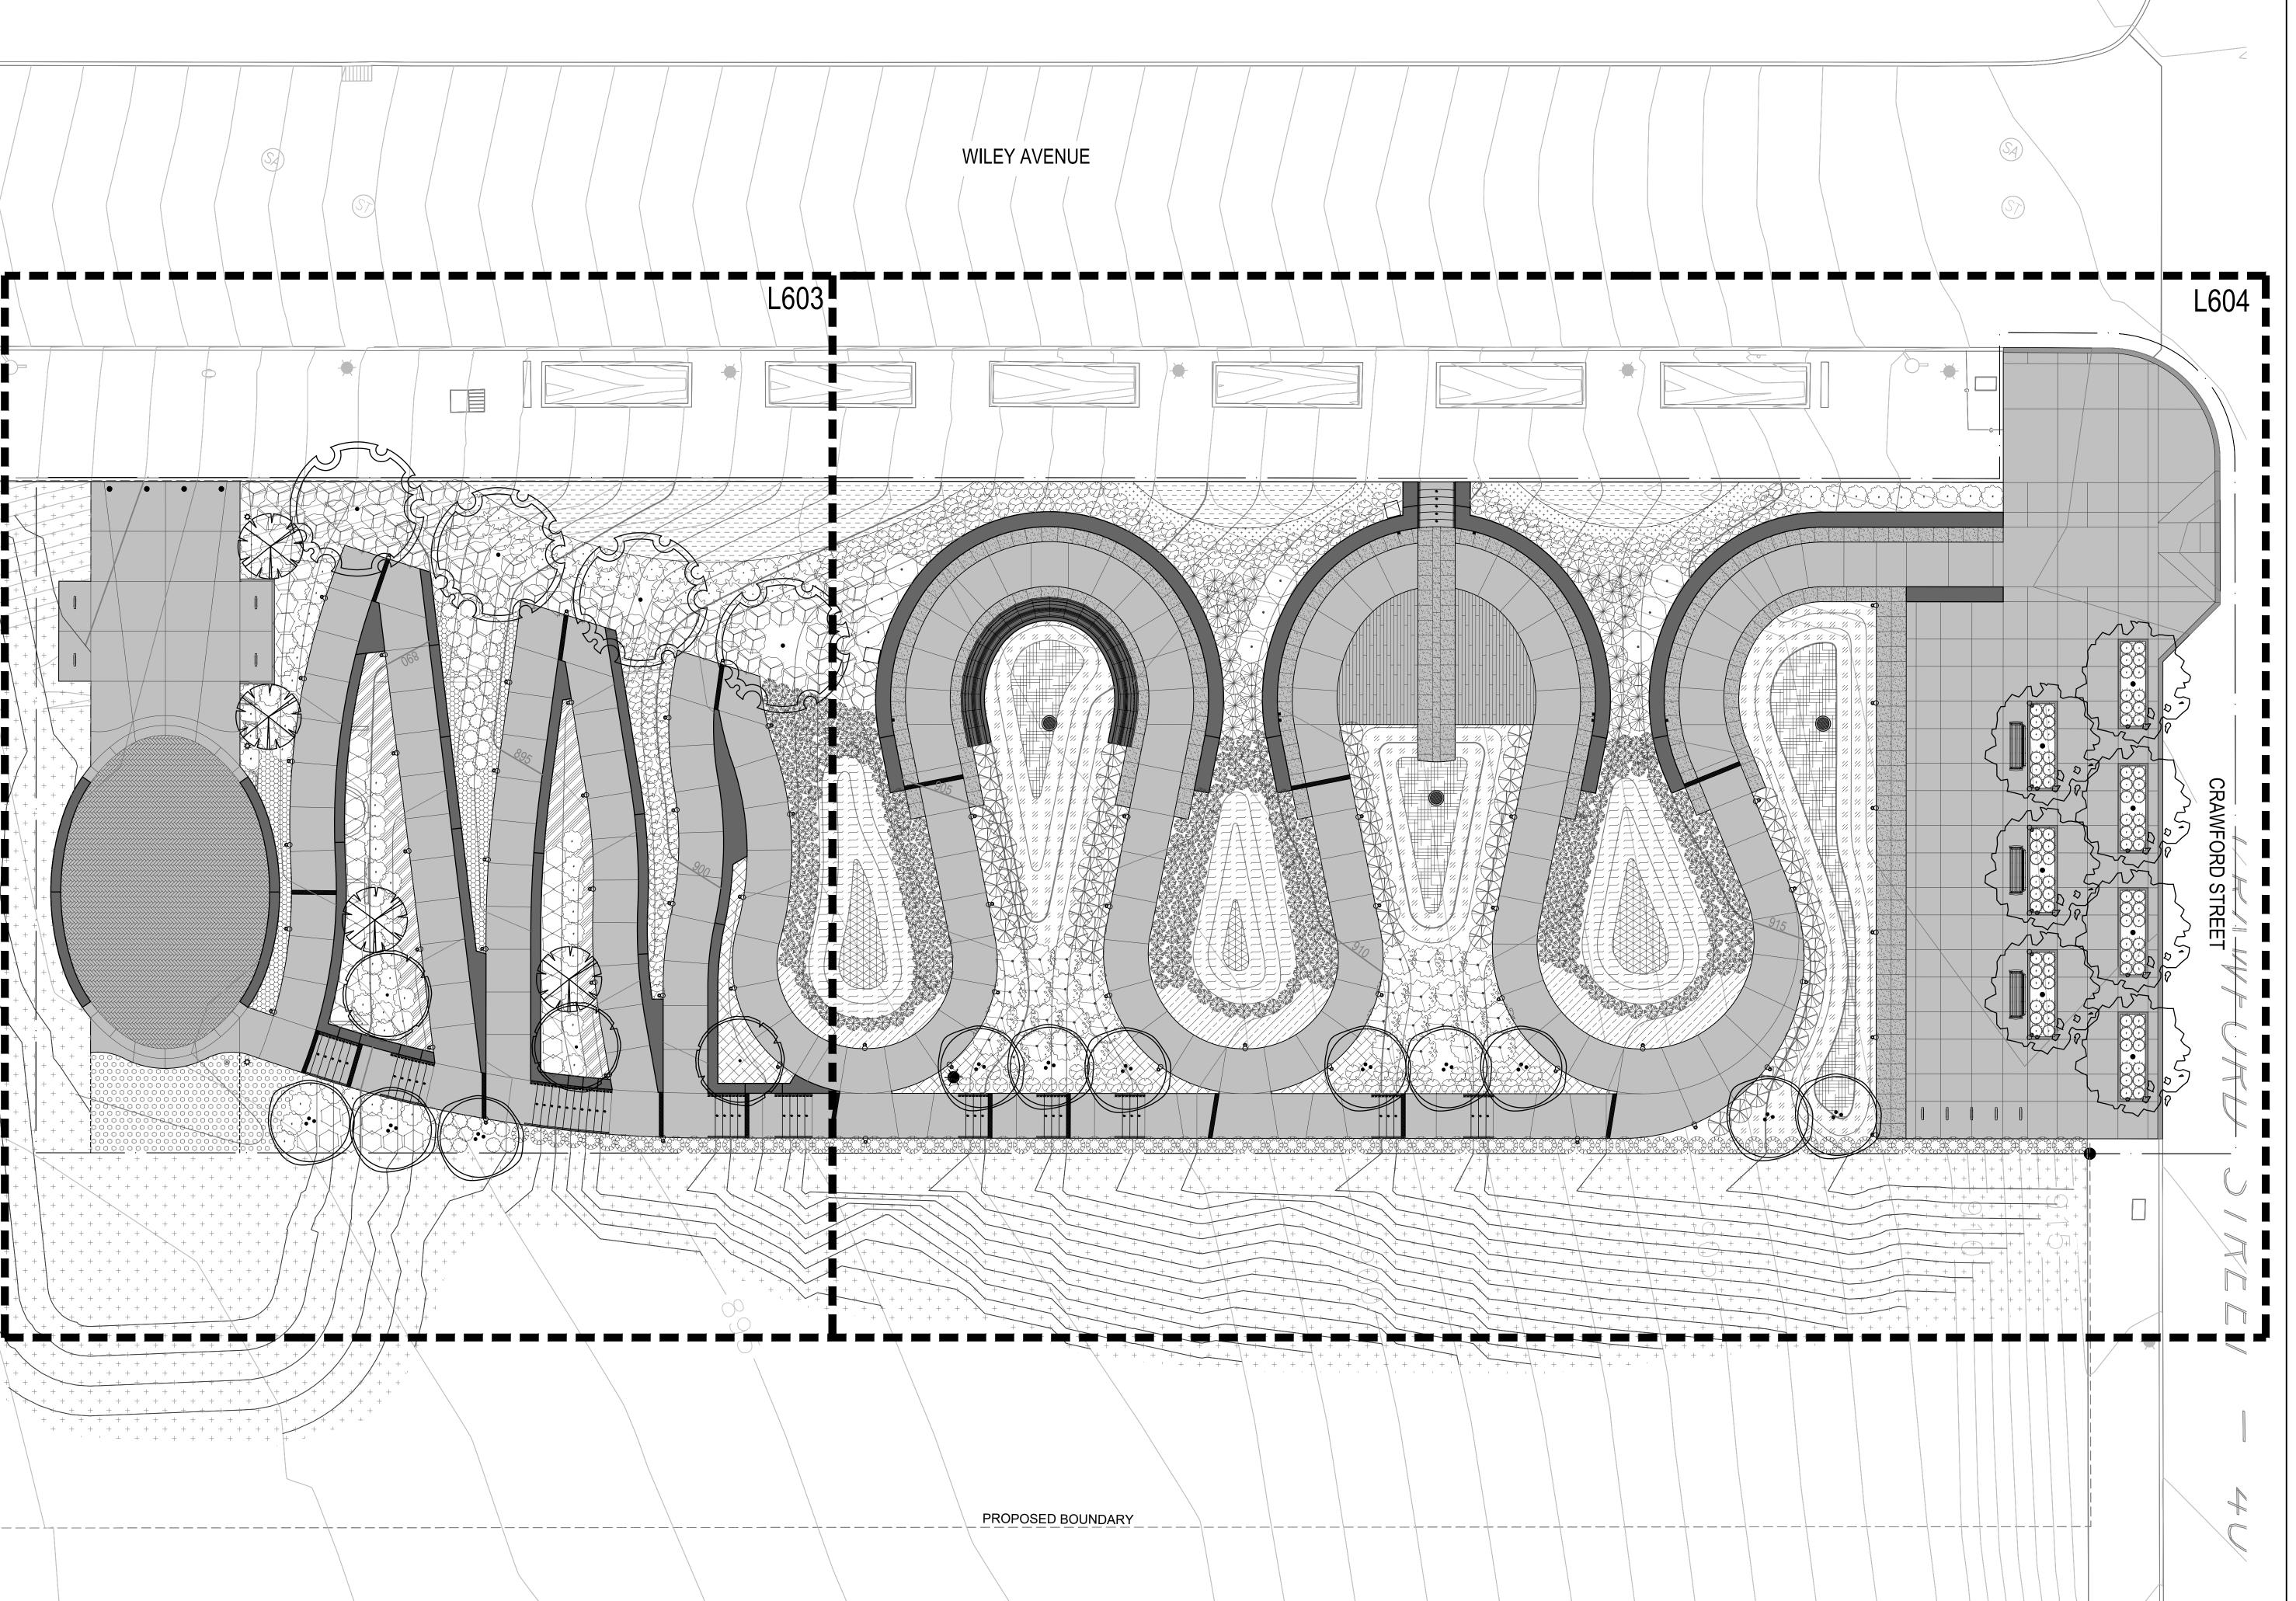
Sheet Name:

Site Details

Submission:

100% Construction Documents

Sheet Number:





Landscape Architectur

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Project Number: 21020:1

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Date: April 28, 2023

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Sheet Name:

Landscape Reference Plan

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Sheet Number:

.600



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Lower Hill-Curtain Call



Project Number: 21020:1

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Checked by: LD | DM

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Sheet Name:

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Lower Hill-Curtain Call



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21020:1 Drawn by:

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Checked by:
LD | DM

Date:

April 28, 2023
Revisions:

S c a l e :
0' 10'

Sheet Name:

Slope Seeding Plan

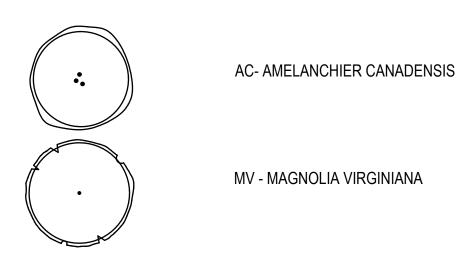
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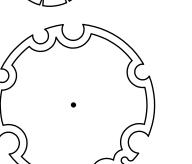
100% Construction Documents

Sheet Number:

L602

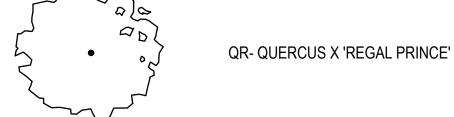
Tree Legend





NS- NYSSA SYLVATICA

MA- MAGNOLIA X ANN



Shrub Legend


\bigcirc	CAH - CLETHRA ALNIFOLIA 'HUMMINGBIRD'
	CSF - CORNUS STOLONIFERA 'FARROW'
	HQS - HYDRANGEA QUERCIFOLIA 'SNOW QUEEN'
	IGC - ILEX GLABRA 'CHAMZIN'

• RCA - RHODODENDRON CATAWBIENSE 'ALBUM'

IGS- ILEX GLABRA 'SHAMROCK'

- RC RHODODENDRON CHIONOIDES
- RP RHODODENDRON X P.J.M.
- VD VIBURNUM DENTATUM

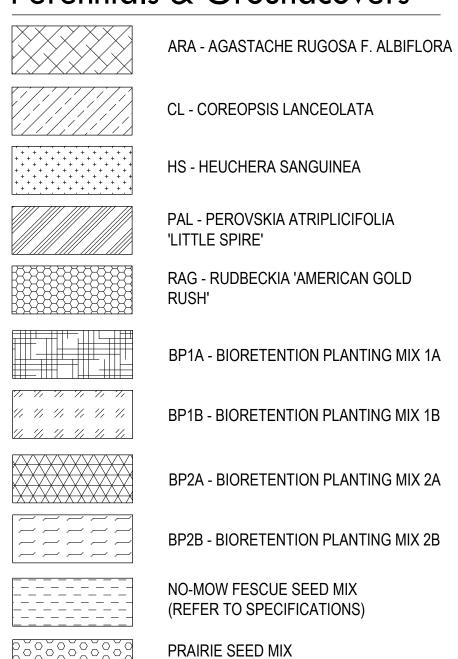Perennials & Groundcovers



(REFER TO SPECIFICATIONS)

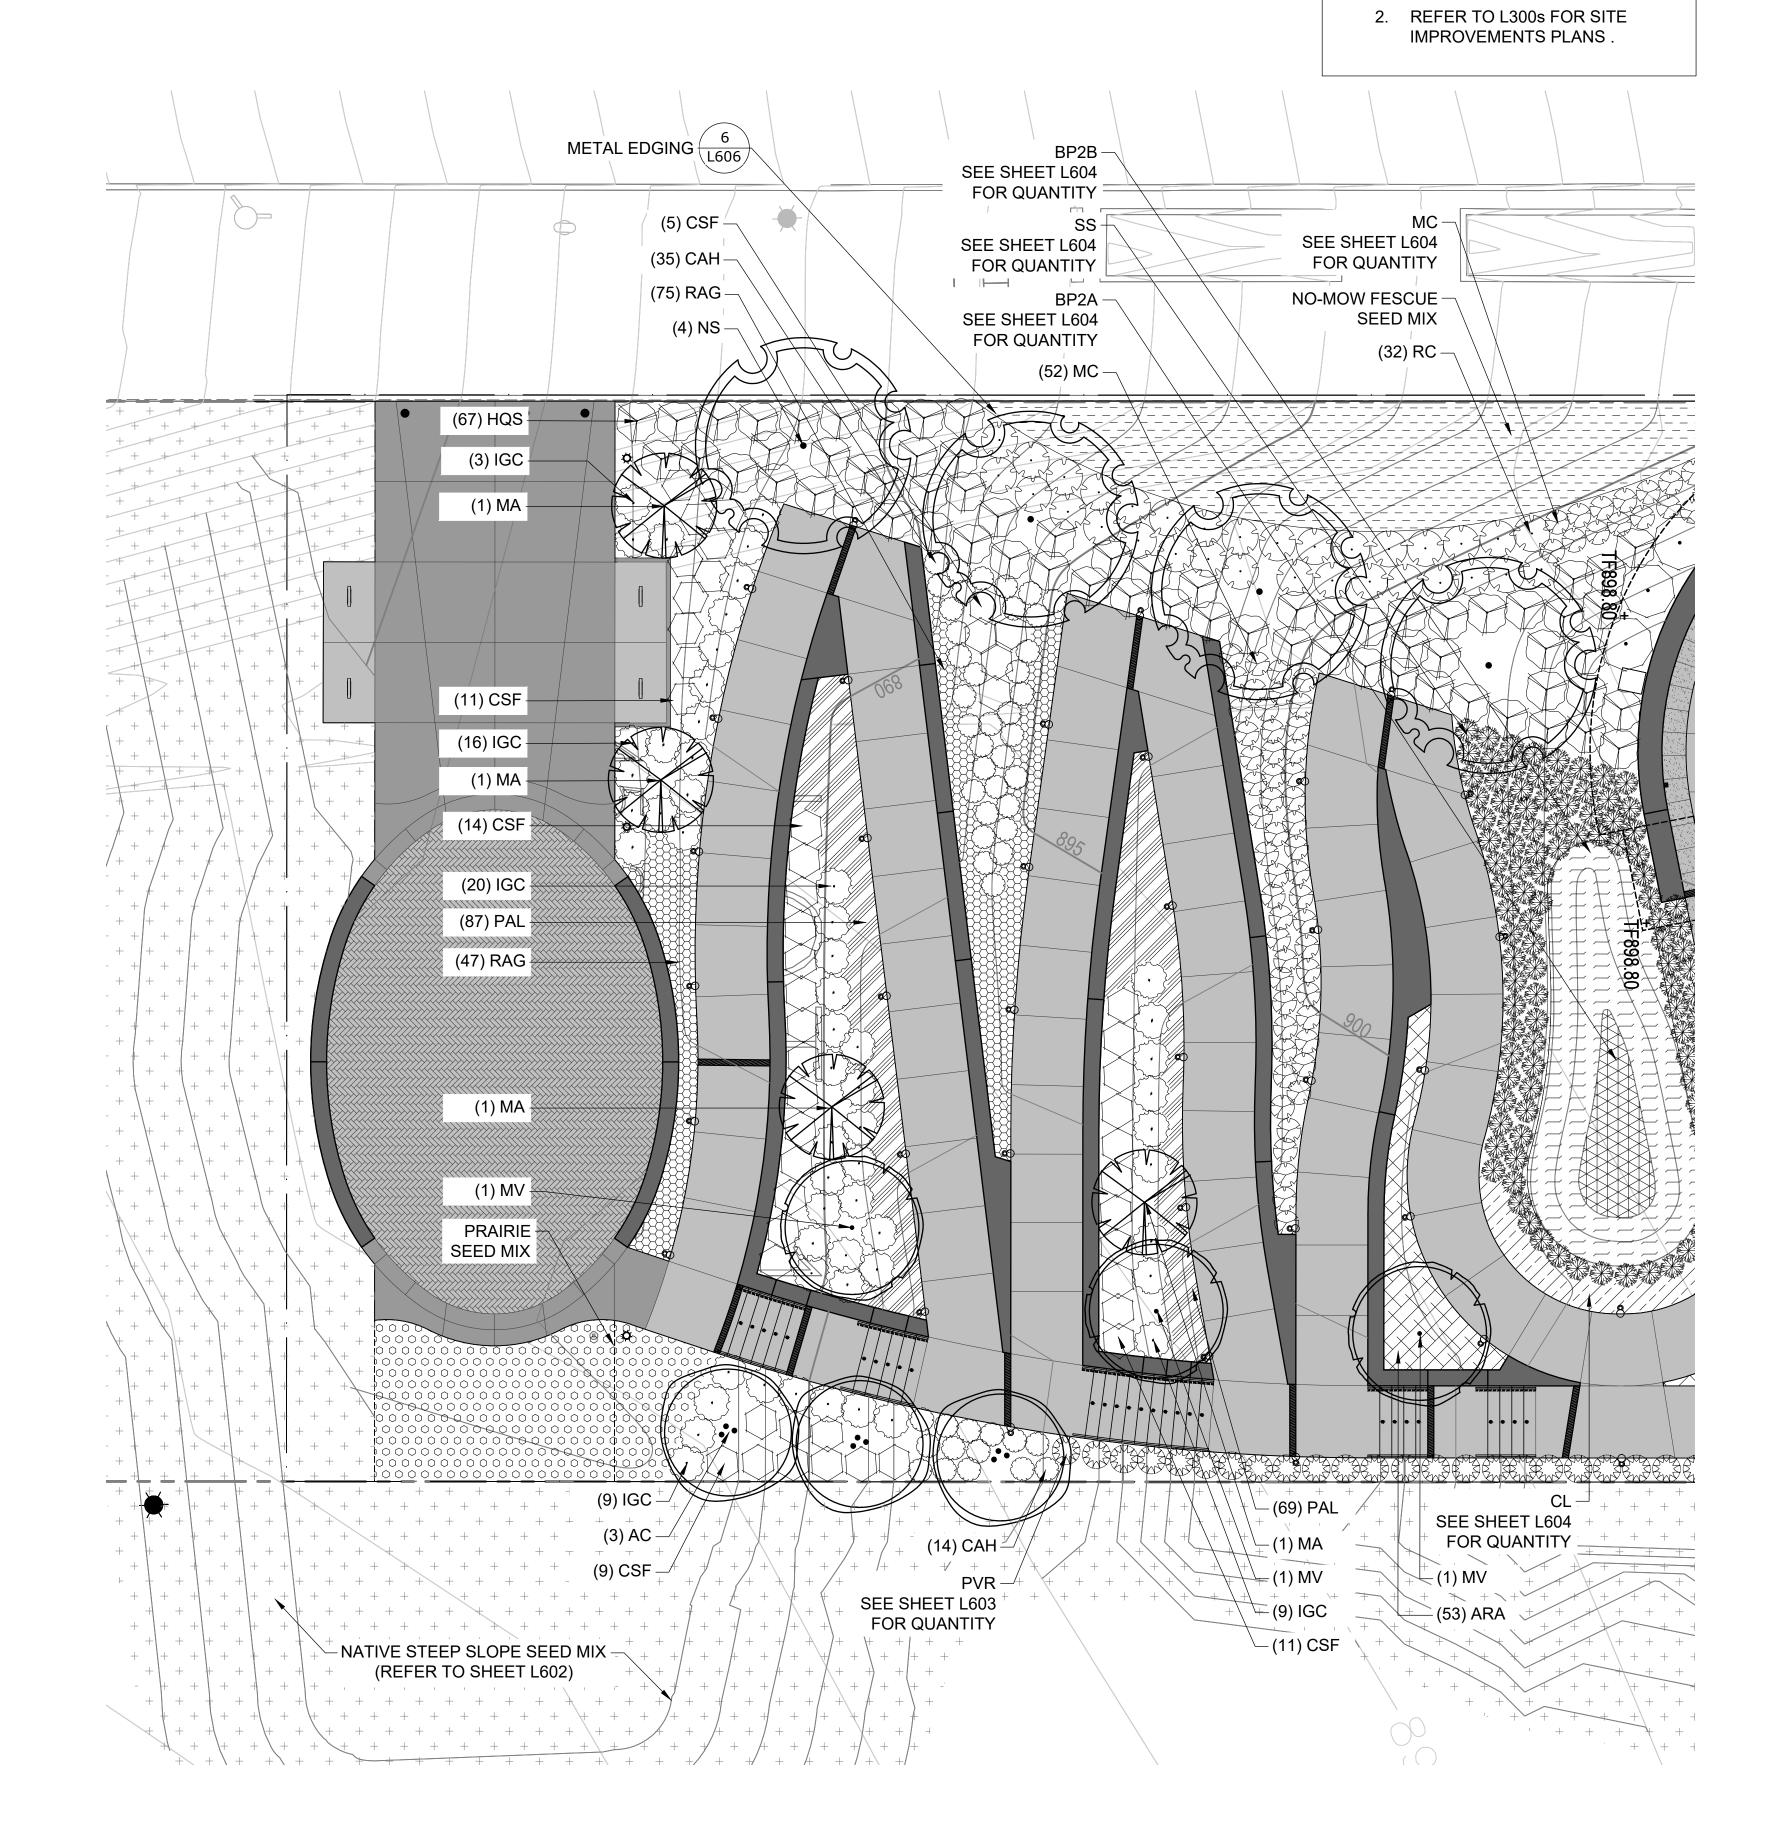
NATIVE STEEP SLOPE SEED MIX

(REFER TO SPECIFICATIONS)

+ + +

Ornamental Grasses

- MC MUHLENBERGIA CAPILLARIS
- PVR- PANICUM VIRGATUM 'ROTSTRAHLBUSCH'
- PA PENNISETUM ALOPECUROIDES 'LITTLE BUNNY'
- SS SCHIZACHYRIUM SCOPARIUM





1. REFER TO L605/L606 FOR

DETAILS.

PLANTING SCHEDULES AND

Landscap Architectu

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Lower Hill-Curtain Call



Project Number: 21020:1

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Checked by: LD | DM

April 28, 2023

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S c a l e : 0' 2' 4' 8' SCALE: 1/8" = 1'-0"

Sheet Name:

Landscape Plan Enlargement

Submission:

100% Construction Documents

Sheet Number:

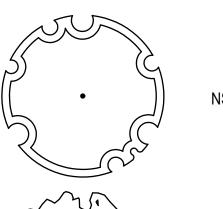
603

Tree Legend


AC- AMELANCHIER CANADENSIS

MV - MAGNOLIA VIRGINIANA

MA- MAGNOLIA X ANN



NS- NYSSA SYLVATICA

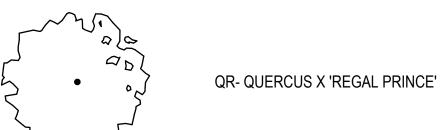

Shrub Legend

CAH - CLETHRA ALNIFOLIA 'HUMMINGBIRD'

CSF - CORNUS STOLONIFERA 'FARROW'

HQS - HYDRANGEA QUERCIFOLIA 'SNOW QUEEN'

IGC - ILEX GLABRA 'CHAMZIN'

IGS- ILEX GLABRA 'SHAMROCK'

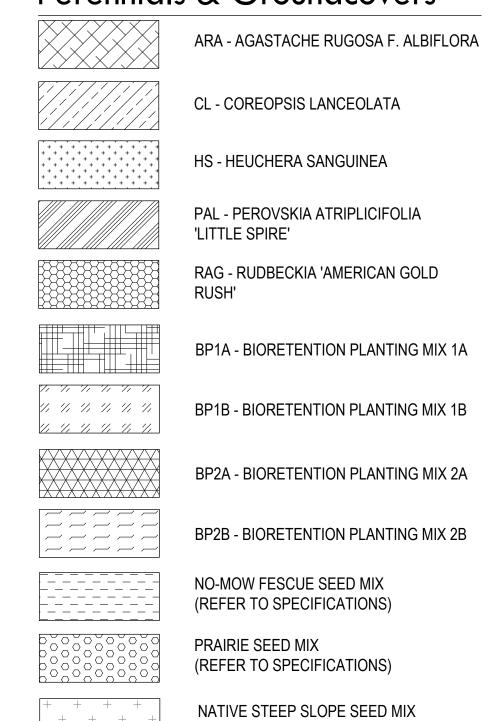
RCA - RHODODENDRON CATAWBIENSE 'ALBUM'

RC - RHODODENDRON CHIONOIDES

RP - RHODODENDRON X P.J.M.

VD - VIBURNUM DENTATUM

Perennials & Groundcovers



(REFER TO SPECIFICATIONS)

Ornamental Grasses

MC - MUHLENBERGIA CAPILLARIS

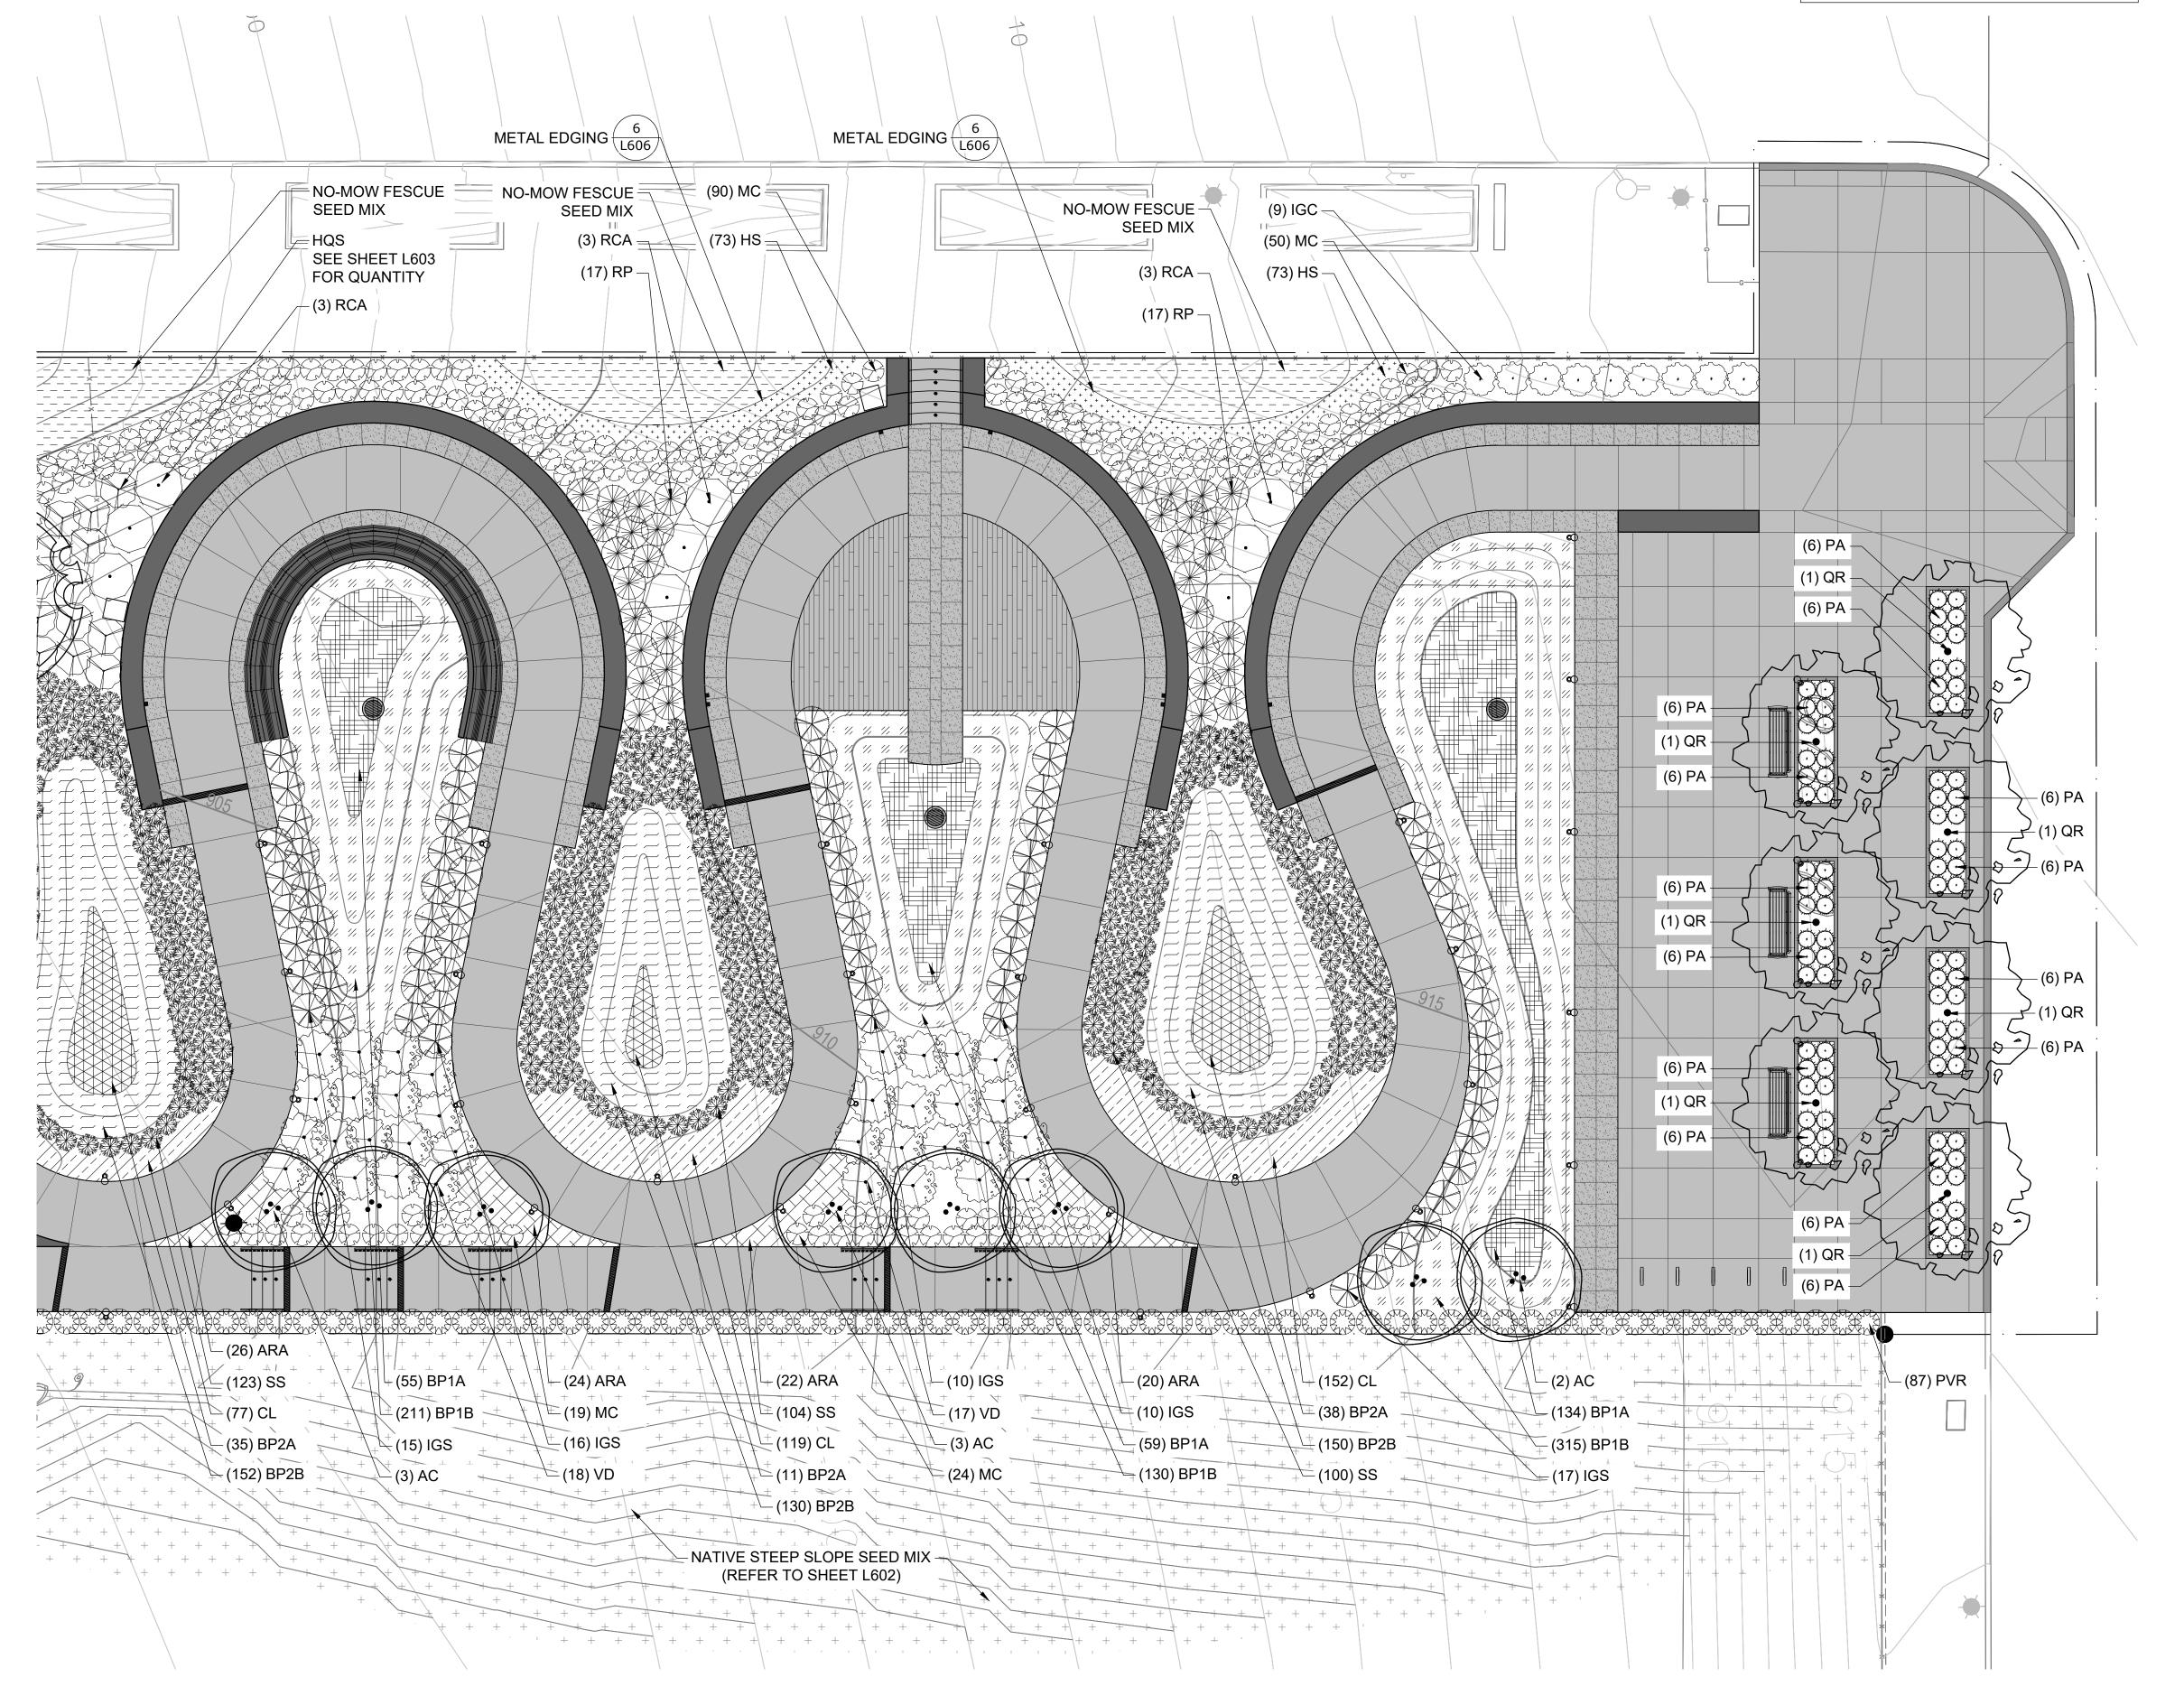
PVR- PANICUM VIRGATUM 'ROTSTRAHLBUSCH'

PA - PENNISETUM ALOPECUROIDES 'LITTLE BUNNY'

SS - SCHIZACHYRIUM SCOPARIUM

1. REFER TO L605/L606 FOR PLANTING SCHEDULES AND DETAILS.

2. REFER TO L300s FOR SITE IMPROVEMENTS PLANS .





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Lower Hill-Curtain Call Pittsburgh, PA



Project Number: 21020:1

Drawn by: **AT** Checked by:

LD | DM

April 28, 2023

Sheet Name:

Landscape Plan Enlargement

Submission:

100% Construction Documents

Sheet Number:

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			TREE SCHEI	DULE	
QUANTITY	BOTANICAL NAME	COMMON NAME	SIZE (MIN.)	CONDITION	NOTES
11	AMELANCHIER CANADENSIS	AUTUMN BRILLIANCE SERVICEBERRY	5'-6' HT.	B&B	SINGLE TRUNK, INSTALL TREEGATOR ORIGINIAL WATERING BAG- REFER TO SPECIFICATIONS
3	MAGNOLIA VIRGINIANA	SWEETBAY MAGNOLIA	2- 21/2" CAL	B&B	SINGLE TRUNK, INSTALL TREEGATOR ORIGINIAL WATERING BAG- REFER TO SPECIFICATIONS
4	MAGNOLIA X 'ANN'	ANN MAGNOLIA	5'-6' HT.	B&B	SINGLE TRUNK, MATCHING SPECIMENS, INSTALL TREEGATOR ORIGINIAL WATERING BAG- REFER TO SPECIFICATIONS
4	NYSSA SYLVATICA	BLACK TUPELO	3" CAL.	B&B	INSTALL TREEGATOR ORIGINIAL WATERING BAG- REFER TO SPECIFICATIONS
7	QUERCUS X 'REGAL PRINCE'	REGAL PRINCE OAK	3" CAL.	B&B	STREET TREES, MATCHING SPECIMENS, INSTALL TREEGATOR ORIGINIAL WATERING BAG- REFER TO SPECIFICATIONS

NOTE:

1) QUANTITIES SHOWN FOR CONTRACTOR CONVENIENCE ONLY. CONTRACTOR TO VERIFY ALL QUANTITIES FOR PLANTING AREAS.

2) B&B = BALLED & BURLAPPED, CONT= CONTAINER, O.C.= ON CENTER SPACING, GAL=GALLON

			SHRUB	SCHEDULE		
QUANTITY	CODE	BOTANICAL NAME	COMMON NAME	SIZE (MIN.)	CONDITION	NOTES
49	САН	CLETHRA ALNIFOLIA 'HUMMINGBIRD'	HUMMINGBIRD SUMMERSWEET	18"-24" HT.	#3 CONT	FULL AND BUSHY TO GROUND
50	CSF	CORNUS STOLONIFERA 'FARROW'	ARCTIC FIRE RED TWIG DOGWOOD	2-3' HT.	#5 CONT	FULL AND BUSHY TO GROUND
67	HQS	HYDRANGEA QUERCIFOLIA 'SNOW QUEEN'	SNOW QUEEN OAKLEAF HYDRANGEA	3'-4' HT.	B&B	FULL AND BUSHY TO GROUND
66	IGC	ILEX GLABRA 'CHAMZIN'	NORDIC INKBERRY HOLLY	18"-24" HT.	#5 CONT	FULL AND BUSHY TO GROUND
68	IGS	ILEX GLABRA 'SHAMROCK'	SHAMROCK HOLLY	18"-24" HT.	#5 CONT	FULL AND BUSHY TO GROUND
9	RCA	RHODODENDRON CATAWBIENSE 'ALBUM'	WHITE CATAWBA RHODODENDRON	3-4' HT.	B&B	FULL AND BUSHY TO GROUND
32	RC	RHODODENDRON 'CHIONOIDES'	CHIONOIDES RHODODENDRON	18"-24" HT.	#5 CONT	FULL AND BUSHY TO GROUND
34	RP	RHODODENDRON X PJM	PJM RHODODENDRON	18"-24" HT.	#5 CONT	FULL AND BUSHY TO GROUND
35	VD	VIBURNUM DENTATUM	ARROWOOD VIBURNUM	3-4' HT.	B&B	FULL AND BUSHY TO GROUND

NOTE:

1) QUANTITIES SHOWN FOR CONTRACTOR CONVENIENCE ONLY. CONTRACTOR TO VERIFY ALL QUANTITIES FOR PLANTING AREAS.

2) B&B = BALLED & BURLAPPED, CONT= CONTAINER, O.C.= ON CENTER SPACING, GAL=GALLON

OHANITITY .	2255		ENNIALS, ORNAMENTAL GRASSES & GROUN		l ochipirion	NOTES
QUANTITY	CODE	BOTANICAL NAME	COMMON NAME	SIZE (MIN.)	CONDITION	NOTES
145	ARA	AGASTACHE RUGOSA F. ALBIFLORA	KOREAN MINT	#1 CONT.	CLUMP	SPACING 18" O.C.
348	CL	COREOPSIS LANCEOLATA			CLUMP	SPACING 12" O.C.
146	нѕ	HEUCHERA SANGUINEA	CORAL BELLS	#1 CONT.	CLUMP	SPACING 12" O.C.
235	МС	MUHLENBERGIA CAPILLARIS	PINK MUHLY GRASS	#2 CONT	CONT;	SPACING AS SHOWN ON PLAN
87	PVR	PANICUM VIRGATUM 'ROTSTRAHLBUSCH'	RED SWITCHGRASS	2-3' HT.	CONT.	SPACING AS SHOWN ON PLAN
84	PA	PENNISETUM ALOPECUROIDES 'LITTLE BUNNY'	LITTLE BUNNY FOUNTAIN GRASS	#2 CONT.	CONT.	SPACING AS SHOWN ON PLAN
156	PAL	PEROVSKIA ATRIPLICIFOLIA 'LITTLE SPIRE'	LITTLE SPIRE RUSSIAN SAGE	#2 CONT	CLUMP	SPACING 18" O.C.
122	RAG	RUDBECKIA 'AMERICAN GOLD RUSH'	AMERICAN GOLD RUSH BLACK-EYED SUSAN	#1 CONT.	CLUMP	SPACING 18" O.C.
327	SS	SCHIZACHYRIUM SCOPARIUM	LITTLE BLUESTEM	#2 CONT	CONT.	SPACING AS SHOWN ON PLAN
248	BP1A	BIO RETENTION MIX 1A	25% CAREX VULPINOIDEA 25% ASCLEPIAS INCARNATA 25% LIATRIS SPICATA 25% HELENIUM AUTUMNALE	#2 CONT.	CONT.	SPACING 18" O.C.
656	BP1B	BP1B BIO RETENTION MIX 1B 25% ANDROPOGON VIRGINICUS 25% HELIOPSIS HELIANTHOIDES 25% AQUILEGIA CANADENSIS 'CORBET 25% ECHINACEA PURPUREA		#2 CONT.	CONT.	SPACING 18" O.C.
84	BP2A BIO RETENTION MIX 2A 25% EUTROCHIUM PU 25% ASCLEPIAS INCARNA		25% JUNCUS EFFUSUS 25% EUTROCHIUM PURPUREUM 25% ASCLEPIAS INCARNATA 'ICE BALLET' 25% HELENIUM 'MARDI GRAS'	#2 CONT.	CONT.	SPACING 18" O.C.
432	BP2B	BIO RETENTION MIX 2B	25% ANDROPOGON VIRGINICUS 25% AQUILEGIA CANADENSIS 25% RATIBIDA PINNATA 25% ASTER NOVAE-ANGLIAE	#2 CONT.	CONT.	SPACING 18" O.C.
NA	NA	NATIVE STEEP SLOPE SEED MIX	REFER TO SPECIFICATIONS	NA	NA	NA
NA	NA	NO-MOW FESCUE SEED MIX	REFER TO SPECIFICATIONS	NA	NA	NA
NA	NA	PRAIRIE SEED MIX	SCHIZACHYRIUM SCOPARIUM SEED MIX, REFER TO SPECIFICATIONS	NA	NA	NA

NOTE:

1.) QUANTITIES SHOWN FOR CONTRACTOR CONVENIENCE ONLY. CONTRACTOR TO VERIFY ALL QUANTITIES FOR PLANTING AREAS.

2.) B&B = BALLED & BURLAPPED, CONT= CONTAINER, O.C.= ON CENTER SPACING

3.) GRASSES, GROUNDCOVERS AND PERENNIALS UTILIZE TRIANGULAR SPACING. REFER TO PLANS FOR HATCHED AREAS.

GENERAL NOTES

PRIOR TO CONSTRUCTION:

- CONTRACTOR SHALL OBTAIN ALL RELEVANT DRAWINGS, DETAILS AND SPECIFICATIONS PRIOR TO BEGINNING CONSTRUCTION.
- 2. CONTRACTOR SHALL VERIFY EXISTING FIELD CONDITIONS, REVIEW DRAWINGS AND PROPOSED WORK PRIOR TO CONSTRUCTION. ANY DISCREPANCIES SHALL BE BROUGHT TO THE ATTENTION OF THE LANDSCAPE ARCHITECT IMMEDIATELY.
- 3. CONTRACTOR SHALL PROTECT ALL EXISTING
 UTILITIES AND SITE IMPROVEMENTS THAT ARE
 NOTED TO REMAIN AND SHALL COORDINATE WITH
 PENNSYLVANIA ONE CALL SYSTEM, INC. TO VERIFY
 LOCATION OF ALL UTILITIES. CALL 1-800-242-1776.

GENERAL PLANTING:

- 4. COORDINATE PLANTINGS WITH EXISTING AND PROPOSED UTILITY LOCATIONS AND NOTIFY OWNER'S REPRESENTATIVE OF ANY UTILITIES OR FEATURES THAT INTERFERE WITH PROPOSED IMPROVEMENTS.
- 5. UTILIZE ONLY PLANTS GROWN IN THE SAME USDA PLANTING ZONES (PER THE USDA PLANT HARDINESS MAP) AS THOSE OF THE PROJECT SITE.
- 6. ALL PLANTS SHALL BE FURNISHED AND INSTALLED IN STRICT ACCORDANCE WITH THE "AMERICAN STANDARD FOR NURSERY STOCK". ANSI 260.1, AS PUBLISHED AND APPROVED BY THE AMERICAN ASSOCIATION OF NURSERYMEN.
- 7. ALL PLANTS TO BE STAKED IN THE FIELD BY CONTRACTOR FOR APPROVAL OF OWNER'S REPRESENTATIVE PRIOR TO PLANTING INSTALLATION.
- 8. CONTRACTOR SHALL INSTALL ALL PLANT MATERIALS IN LOCATIONS AND TO DEPTHS AS SHOWN ON PLAN OR ON DETAILS.
- 9. PROVIDE MULCH RING AROUND INDIVIDUAL TREES (BOTH EXISTING AND PROPOSED). 4' MINIMUM MULCH RING AT SHADE/CANOPY TREES. 3' MUCH RING AT ORNAMENTAL/FLOWERING TREES.
- 10. REFER TO SPECIFICATIONS FOR MULCH.
- 13. NOTIFY OWNER'S REPRESENTATIVE OF ANY DISCREPANCY BETWEEN THE PLANT SCHEDULE AND PLAN PRIOR TO ORDERING PLANT MATERIALS.
- 14. ALL PLANT MATERIAL SHALL BE GUARANTEED FOR A PERIOD OF ONE CALENDAR YEAR AFTER WRITTEN NOTICE OF ACCEPTANCE OF ALL PLANTING WORK.
- 15. NO SUBSTITUTIONS FOR PLANT SPECIES AND VARIETIES WILL PERMITTED WITH OUT APPROVAL BY OWNER'S REPRESENTATIVE.
- 16. SHOULD THERE BE A DISCREPANCY BETWEEN THE PLANT SCHEDULES AND THE PLANTING PLAN, THE FOLLOWING GOVERNS:
 - A. NUMBER OF PLANT MATERIAL- PLANTING PLAN
 GOVERNS
 - B. SIZE OF PLANTS LARGEST SIZE GOVERNS
 C. TYPE OF PLANT MATERIAL AS DIRECTED BY THE
 OWNER'S REPRESENTATIVE.

TOPSOIL:

- 17. TOPSOIL SHALL BE SUPPLIED BY THE CONTRACTOR.
 TOPSOIL MUST BE TESTED ACCORDING TO
 SPECIFICATIONS PRIOR TO ITS USE. TOPSOIL TEST
 RESULTS AND AMENDMENT RECOMMENDATIONS
 SHALL BE PROVIDED BY THE CONTRACTOR TO THE
- LANDSCAPE ARCHITECT PRIOR TO INSTALLATION.

 18. TOPSOIL SHALL BE 6 INCHES IN LAWN AREAS AND 12 INCHES IN PLANTING BEDS.



Landscape Architecture

Pittsburgh, Pennsylvania 15203 www.laquatrabonci.com



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Lower Hill-Curtain Call Pittsburgh, PA



Project Number: 21020:1

Drawn by: AT Checked by:

D a t e : **April 28, 2023**

Revisions:

LD | DM

Scale: as noted

Sheet Name:

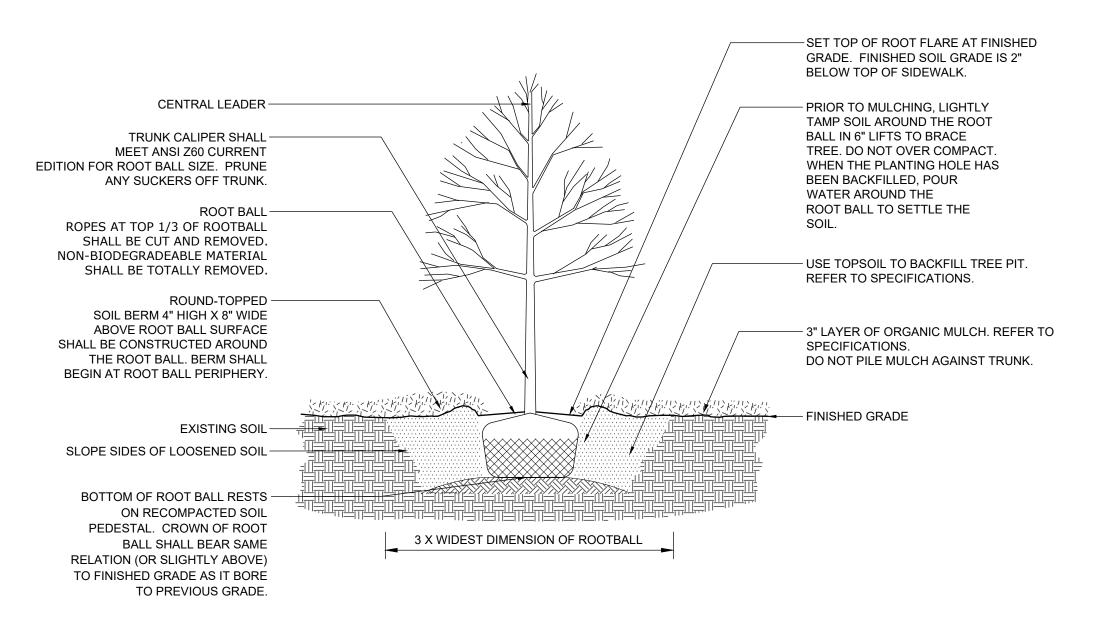
Plant Schedules

Submission:

100% Construction Documents

Sheet Number:

605




PLANTS DUG WITH FIRM, NATURAL BALLS OF EARTH IN WHICH THEY ARE GROWN, WITH BALL SIZE NOT LESS THAN DIAMETER AND DEPTH RECOMMENDED BY ANSI Z60.1 FOR TYPE AND SIZE OF TREE OR SHRUB REQUIRED; WRAPPED, TIED, RIGIDLY SUPPORTED, AND DRUM-LACED AS RECOMMENDED BY ANSI Z60.1 CURRENT EDITION.

Scale: 1/2" = 1' SHRUB -- ROOTBALL - 4" HIGH X 8" WIDE ROUND - TOPPED SOIL 3" LAYER OF ORGANIC MULCH. -REFER TO SPECIFICATIONS. NO BERM ABOVE ROOT BALL SURFACE SHALL BE CONSTRUCTED AROUND THE ROOT BALL. MORE THAN 1" OF MULCH ON TOP OF BERM SHALL BEGIN AT ROOT BALL PERIPHERY. **ROOT BALL** ROPES AT TOP 1/3 OF ROOTBALL SHALL BE CUT AND REMOVED. NON-BIODEGRADEABLE MATERIAL SHALL BE TOTALLY REMOVED. FINISHED GRADE -PRIOR TO MULCHING, LIGHTLY TAMP SOIL SLOPE SIDES OF LOOSENED SOIL AROUND THE ROOT BALL IN 6" LIFTS TO BRACE. DO NOT OVER COMPACT. WHEN THE BACKFILL SHRUB PIT WITH TOPSOIL. PLANTING HOLE HAS BEEN BACKFILLED, POUR REFER TO SPECIFICATIONS. WATER AROUND THE ROOT BALL TO SETTLE THE LOOSE SOIL EXISTING SOIL ROOT BALL RESTS ON RECOMPACTED SOIL MIN. 3X WIDEST DIMENSION


> NOTE: BALLED AND BURLAPPED PLANTS DUG WITH FIRM, NATURAL BALLS OF EARTH IN WHICH THEY ARE GROWN, WITH BALL SIZE NOT LESS THAN DIAMETER AND DEPTH RECOMMENDED BY ANSI Z60.1-1996 FOR TYPE AND SIZE OF TREE OR SHRUB REQUIRED; WRAPPED, TIED, RIGIDLY SUPPORTED, AND DRUM-LACED AS RECOMMENDED BY ANSI Z60.1-1996.

OF ROOT BALL

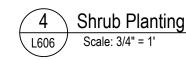
ALL CONTAINER GROWN PLANTS SHALL BE HEALTHY, VIGOROUS, WELL ROOTED, AND ESTABLISHED IN THE CONTAINER IN WHICH THEY ARE GROWING. A CONTAINER GROWN PLANT SHALL HAVE A WELL-ESTABLISHED ROOT SYSTEM REACHING THE SIDES OF THE CONTAINER TO MAINTAIN A FIRM ROOT BALL. CONTAINER SHALL BE RIGID ENOUGH TO HOLD BALL SHAPE AND PROTECT ROOT MASS DURING SHIPPING AND BE SIZED ACCORDING TO ANSI Z60.1-CURRENT EDITION FOR KIND, TYPE, AND SIZE OF PLANT REQUIRED.



1 \ Deciduous Tree Planting

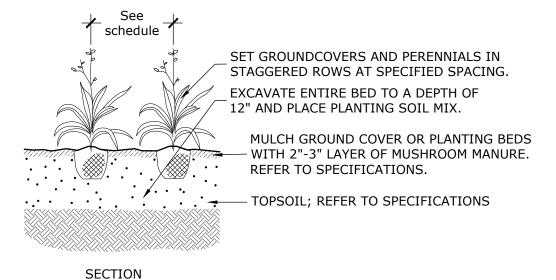


ALL CONTAINER GROWN PERENNIAL PLANTS AND GROUNDCOVERS SHALL BE HEALTHY, VIGOROUS, WELL ROOTED, AND ESTABLISHED IN THE CONTAINER IN WHICH THEY ARE GROWING. A CONTAINER GROWN PERENNIAL PLANT SHALL HAVE A WELL-ESTABLISHED ROOT SYSTEM REACHING THE SIDES OF THE CONTAINER TO MAINTAIN A FIRM ROOT BALL. CONTAINER SHALL BE RIGID ENOUGH TO HOLD BALL SHAPE AND PROTECT ROOT MASS DURING SHIPPING AND BE SIZED ACCORDING TO ANSI Z60.1-CURRENT EDITION FOR KIND, TYPE, AND SIZE OF PLANT REQUIRED.

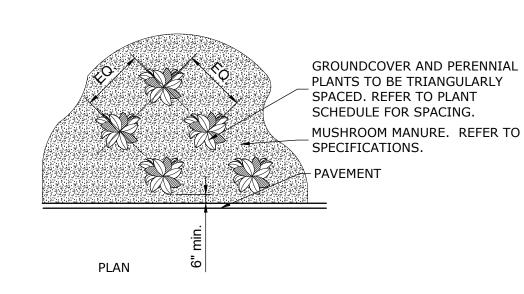


1- SEE PLANTING LEGEND FOR PERENNIAL OR GROUNDCOVER SPECIES, SIZE, AND SPACING DIMENSION.


2- SMALL ROOTS (1/4" OR LESS) THAT GROW AROUND, UP, OR DOWN THE ROOT BALL PERIPHERY ARE CONSIDERED A NORMAL CONDITION IN CONTAINER PRODUCTION AND ARE ACCEPTABLE HOWEVER THEY SHOULD BE ELIMINATED AT THE TIME OF PLANTING. ROOTS ON THE PERIPHERY CAN BE REMOVED AT THE TIME OF PLANTING. (SEE ROOT BALL SHAVING CONTAINER DETAIL).

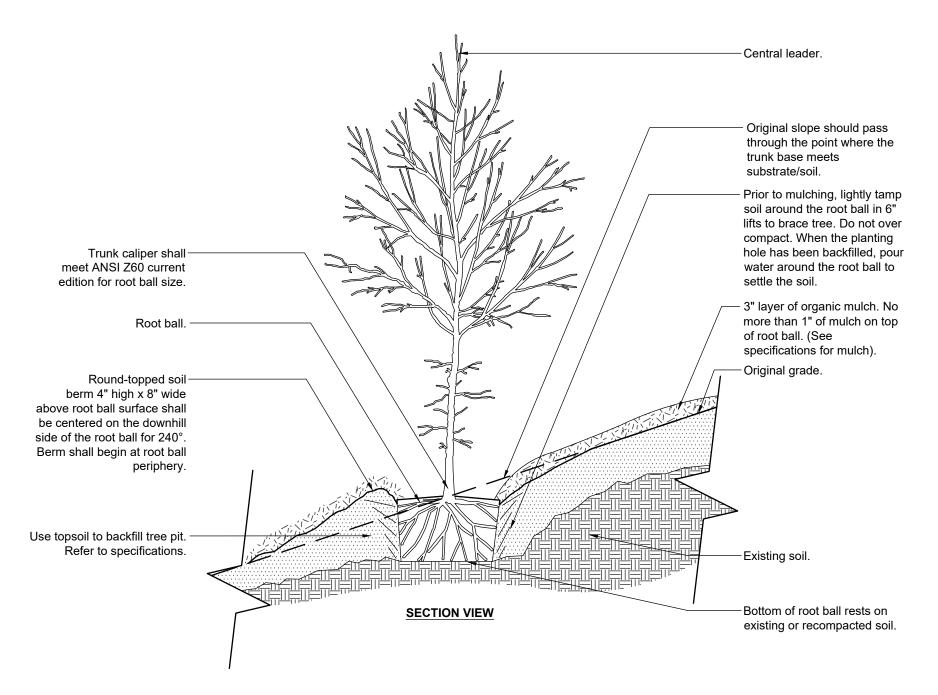3- SETTLE SOIL AROUND ROOT BALL OF EACH PERENNIAL OR GROUNDCOVER PRIOR TO MULCHING.



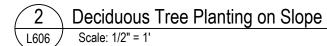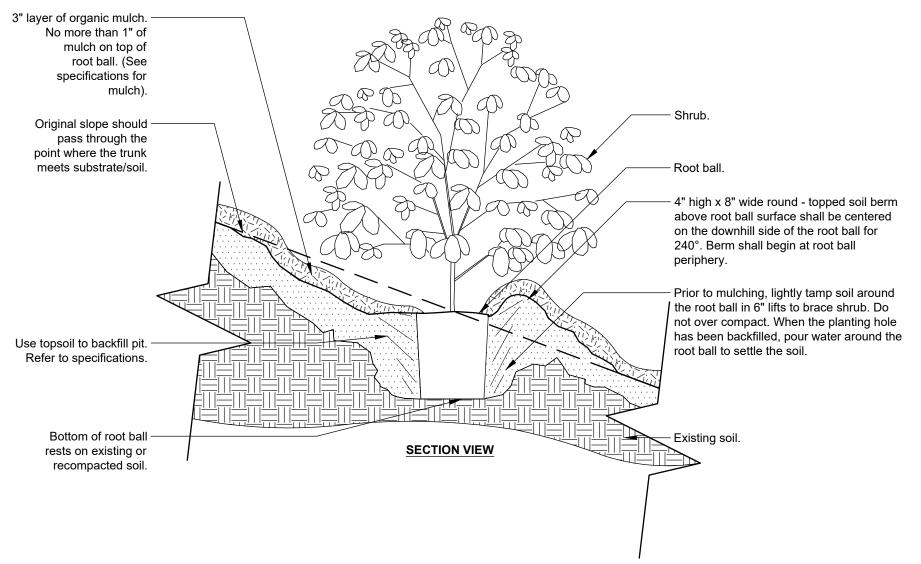PLANTS DUG WITH FIRM, NATURAL BALLS OF EARTH IN WHICH THEY ARE GROWN, WITH BALL SIZE NOT LESS THAN DIAMETER AND DEPTH RECOMMENDED BY ANSI Z60.1 FOR TYPE AND SIZE OF TREE OR SHRUB REQUIRED; WRAPPED, TIED, RIGIDLY SUPPORTED, AND DRUM-LACED AS RECOMMENDED BY ANSI Z60.1 CURRENT EDITION.



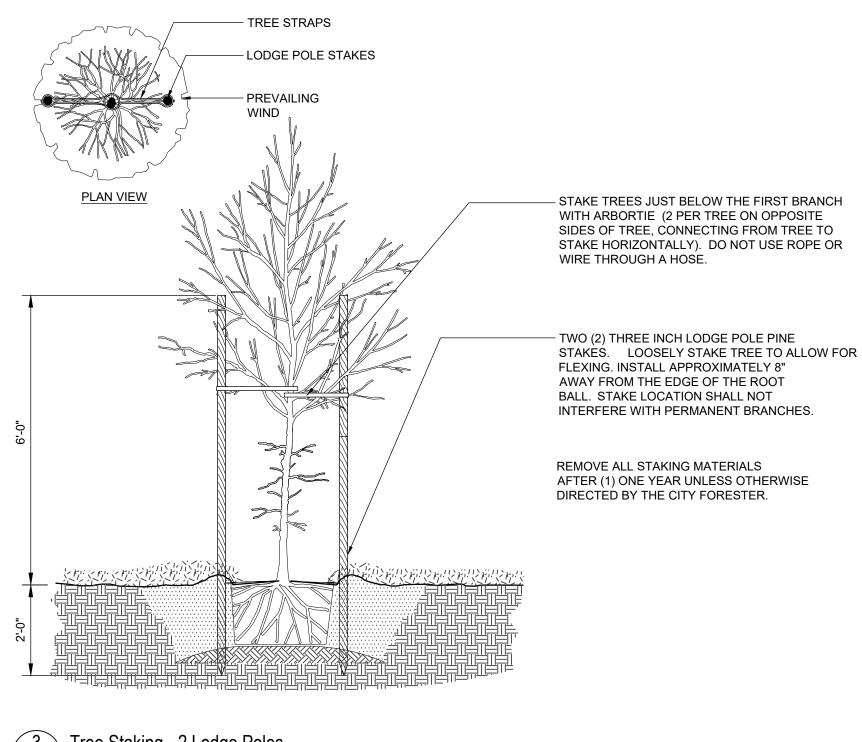


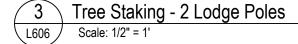
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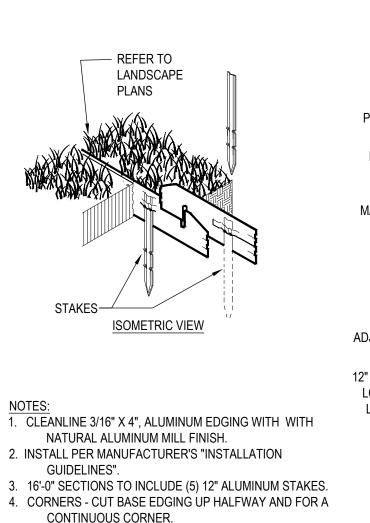
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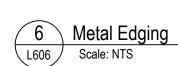
Shrub Planting on Slope

Scale: 3/4" = 1'

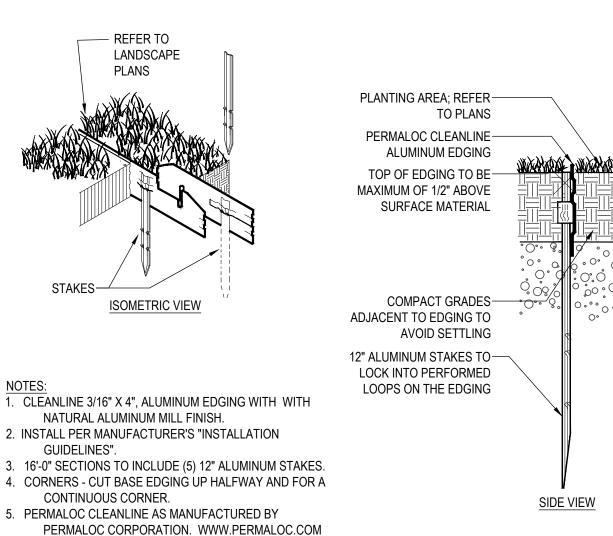








OR APPROVED EQUIVALENT





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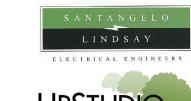
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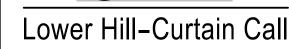
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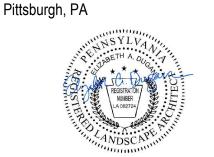
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Project Number: 21020:1

Drawn by Checked by: LD | DM

April 28, 2023 Revisions:

Scale: as noted

Sheet Name:

Planting Details


Submission:

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Perennial and Groundcover Planting





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Lower Hill-Curtain Carrittsburgh, PA

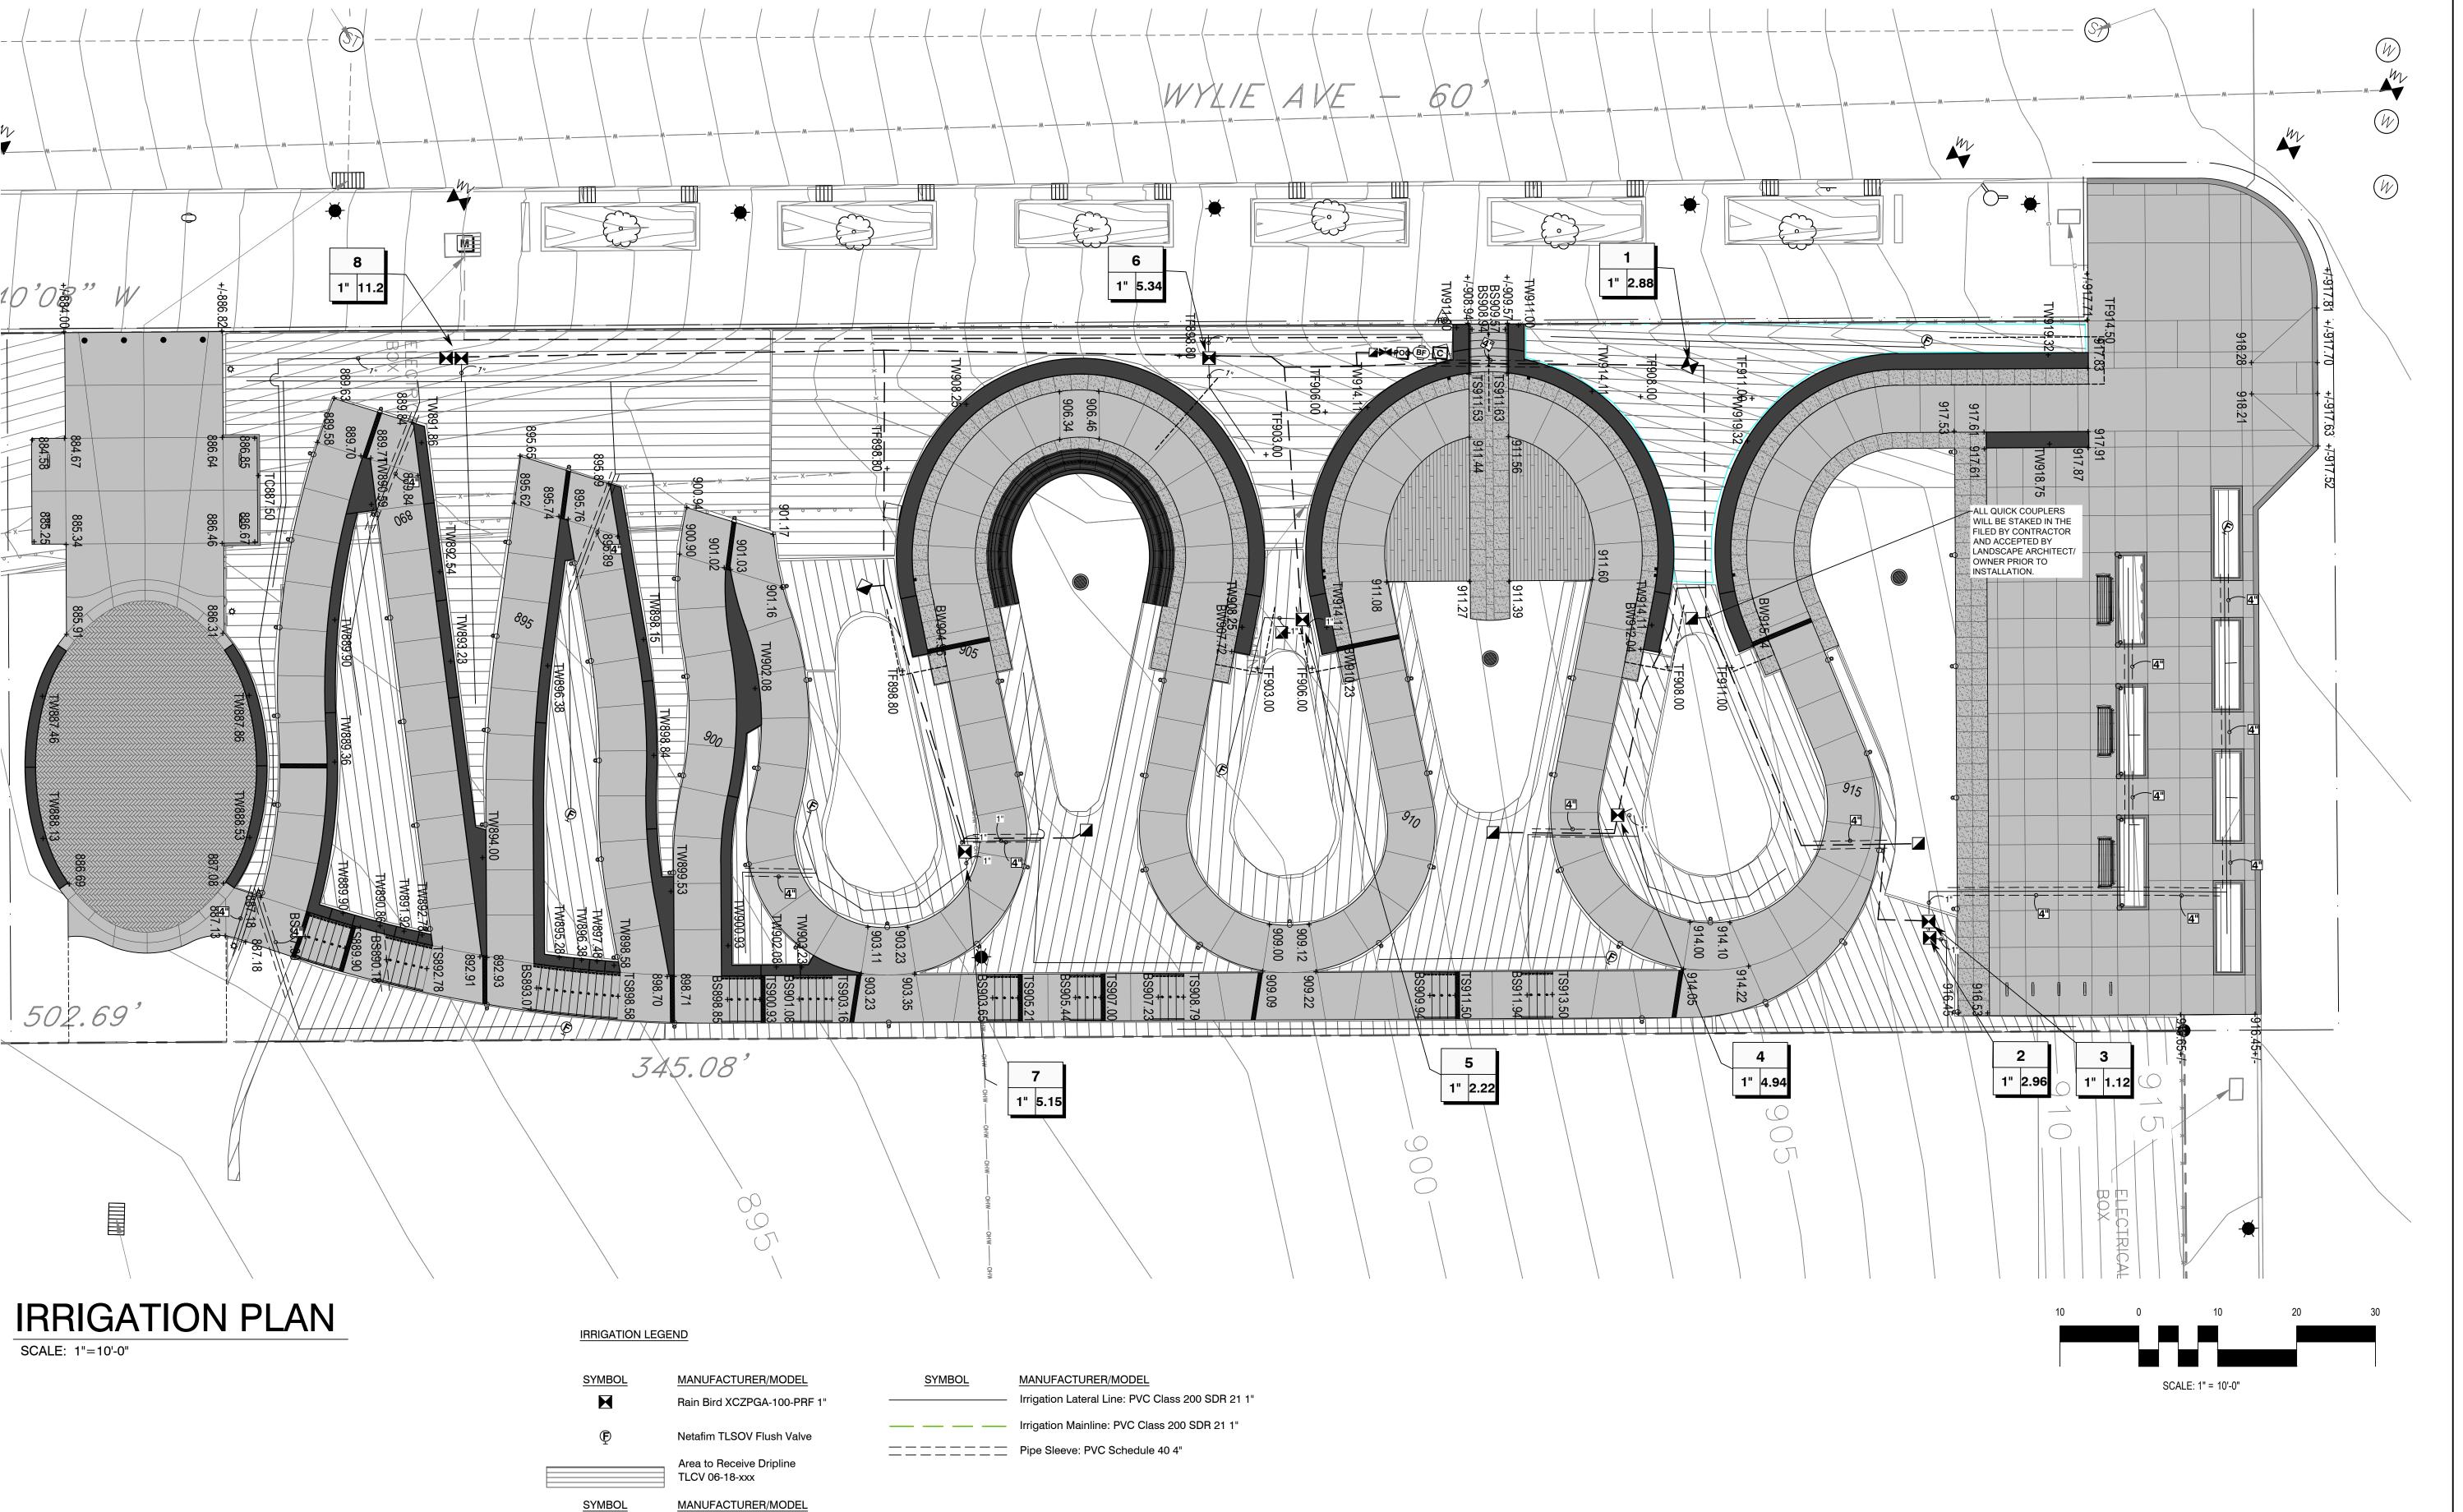Project Number: 21020:1

Drawn by: DLB

Checked by: Date:

April 28, 2023

Revisions:

Sheet Name: Irrigation Plan

Submission:

100% Construction Documents

Sheet Number:


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1 - 800 - 242 - 1776

Rain Bird 5-RC 1" Quick Coupler

1" RPZ Backflow in Enclosure

Rain Bird ESPLXME2 Controller

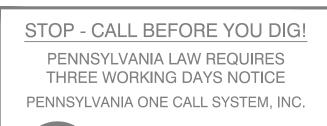Rain Bird RSD-BEx Rain Sensor


Existing Meter and Meter Vault

Point of Connection 1"

Shut Off Valve

C RS M

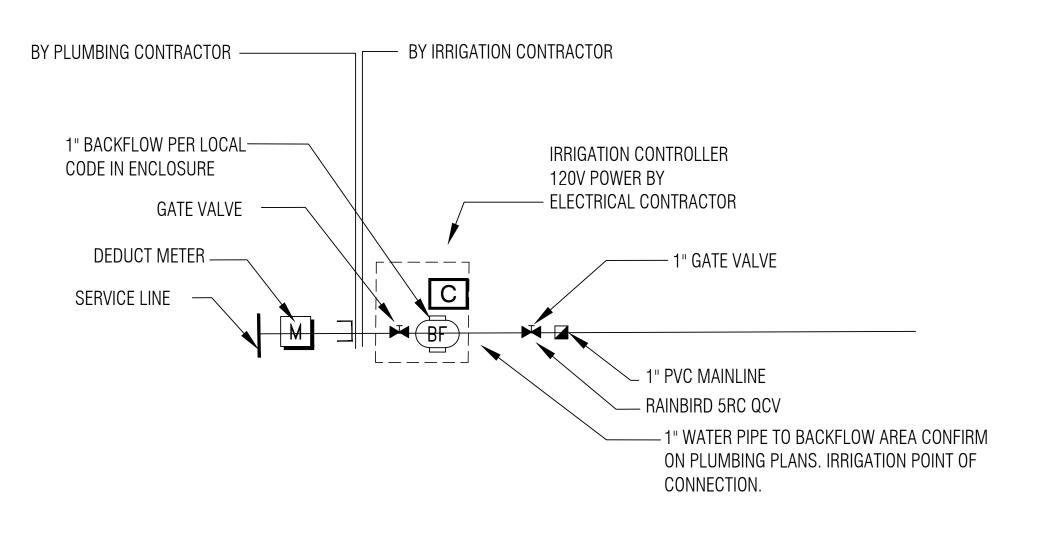Valve Callout



POINT OF CONNECTION

1) FINISH GRADE

② PLANT MATERIAL OR TURF

4 CLEAN SOIL, AMENDED/NATIVE

FREE OF ROCK AND DEBRIS

5) QUICK COUPLER KEY, #55-K. 6) Q.C. HOSE SWIVEL, # SH-2.

① QUICK COUPLER VALVE 5-RC.

PRESSURE PIPE, SIZE PER

① SWING JOINT 1", SIZE PER QUICK COUPLER VALVE INLET.

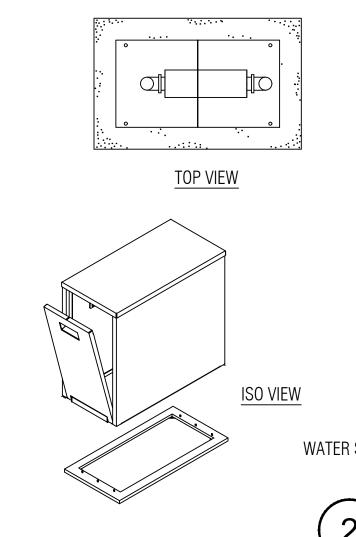
3/4" CRUSHED ROCK

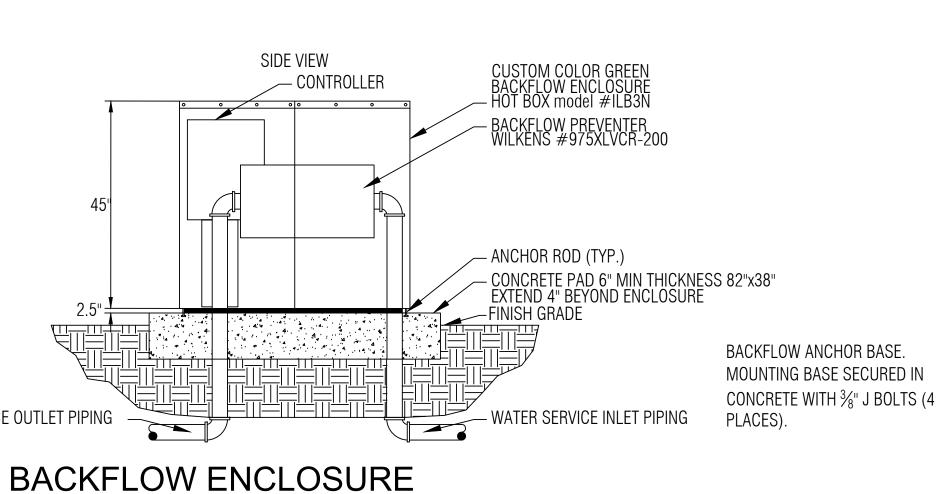
MAINLINE, CL200 PVC

(3) REBAR, 1/2"x30".

BRICK SUPPORTS 1 OF 4

(3) VALVE BOX, 10" RND





DETERMINED ON SITE. FIELD CHANGES SHALL BE MADE AT NO ADDITIONAL COST TO THE OWNER. IRRIGATION CONTRACTOR MUST BE FULLY AWARE OF THE EXISTING CONDITIONS PRIOR TO BIDDING. SITE WILL BE MADE AVAILABLE FOR INSPECTION, COORDINATE WITH LA. IT IS THE RESPONSIBILITY OF THE IRRIGATION CONTRACTOR TO BE FAMILIAR WITH ALL GRADE DIFFERENCES, LOCATIONS OF WALLS, STRUCTURES AND UTILITIES AND MAKE THE NECESSARY ADJUSTMENTS TO ACCOMMODATE THE IRRIGATION SYSTEM AS SHOWN ON THE DRAWINGS. THERE MAY BE TIMES WHEN IT IS OBVIOUS IN THE FIELD THAT UNKNOWN OBSTRUCTIONS, GRADES OR DIMENSIONS THAT EXIST MIGHT NOT HAVE BEEN CONSIDERED IN THE ENGINEERING, SUCH OBSTRUCTIONS SHOULD BE BROUGHT TO THE ATTENTIONS OF THE OWNER'S AUTHORIZED REPRESENTATIVE. IN THE EVENT THAT THIS NOTIFICATION IS NOT PERFORMED. THE IRRIGATION CONTRACTOR SHALL ASSUME FULL RESPONSIBILITY FOR ANY

REVISIONS AND COSTS THAT OCCUR.

IRRIGATION GENERAL NOTES

1. THE IRRIGATION SYSTEM IS DIAGRAMMATIC BASED UPON THE

ON THE DESIGN. ACTUAL LAYOUT OF PIPING. SPRINKLER HEADS.

REPRESENTATIVE. THE SUCCESSFUL CONTRACTOR IS RESPONSIBLE TO

INSTALL A SYSTEM THAT WILL PROPERLY COVER ALL AREAS INDICATED

VALVES, CONTROLLERS AND OTHER RELATED EQUIPMENT SHALL BE

INFORMATION PROVIDED BY THE OWNER OR THE OWNER'S

2. THIS SYSTEM SHALL BE INSTALLED USING ACCEPTED AND QUALITY INSTALLATION STANDARDS AS USED IN THE INDUSTRY. ALL MANUFACTURERS SPECIFICATIONS WILL BE FOLLOWED

3. LATERAL LINE PIPING A MIN. OF 12" OF COVER AND MAINLINE SHALL BE A MIN. OF 16"-18" OF COVER. ALL BACKFILL SURROUNDING THE PIPE SHALL BE CLEANED OF MATERIALS LARGER THAN 1" IN SIZE.

4. THERE WILL BE NO SUBSTITUTIONS OR CHANGES TO THE IRRIGATION DESIGN ALLOWED WITHOUT DIRECT, WRITTEN APPROVAL FROM THE IRRIGATION CONSULTANT OR LANDSCAPE ARCHITECT.

5. SYSTEM DESIGN IS BASED ON PRESSURE AND FLOW INFORMATION PROVIDED BY OTHERS, STATIC PRESSURE WAS GIVEN AS 65-70 PSI AND THE SIZE OF THE P.O.C. IS AS INDICATED ON THE DRAWING. THE IRRIGATION CONTRACTOR SHALL VERIFY WATER PRESSURES PRIOR TO CONSTRUCTION. REPORT DIFFERENCES BETWEEN REQUIREMENTS AND THE ACTUAL READINGS TO THE OWNER'S REPRESENTATIVE.

6. PIPING SHOWN IN PAVED AREA WITHOUT SLEEVE IS DIAGRAMMATIC AND SHALL BE LOCATED INSIDE OF THE PLANTED AREA OR TURF AREA APPROXIMATELY 1' FROM ANY HARDSCAPE.

7. ALL VALVES SHALL BE PLACED IN THE APPROXIMATE AREA AS SHOWN ON THE PLANS.

8. IRRIGATION CONTRACTOR IS TO LOCATE ALL WATERLINES AND UTILITIES AS NEEDED FOR THE IRRIGATION, ALL INFORMATION IS TO BE VERIFIED PRIOR TO ANY INSTALLATION OF THE PROJECT.

9. THE IRRIGATION CONTRACTOR IS RESPONSIBLE FOR ALL CLEAN UP ASSOCIATED WITH HIS WORK.

10. IRRIGATION CONTRACTOR SHALL ALL PROVIDE THE FIRST WINTERIZATION, SPRING TURN ON, HEAD ADJUSTMENTS AND CONTROLLER MAINTENANCE IN BID.

11. ALL UNSIZED PIPE TO BE 1" PVC.

		DRIPL	INE MAX D	ISTANCES			
	12" Spaci	ng	18" Spacii	ng	24"	Spacing	
Inlet Pressure	Nominal F	Tlow (GPH)	Nominal F	Tow (GPH)	Nominal F	Tow (GPH)	
psi	0.6	0.9	0.6	0.9	0.6	0.9	
15	255	194	357	273	448	343	
20	291	220	408	313	514	394	
30	350	266	494	378	622	478	
40	396	302	560	428	705	541	
50	434	333	614	470	775	594	

NOTES:

1. DISTANCE BETWEEN LATERAL ROWS AND EMITTER SPACING TO BE BASED ON SOIL TYPE, PLANT MATERIALS AND CHANGES IN ELEVATION. SEE INSTALLATION SPECIFICATIONS ON NETAFIM WEB SITE (WWW.NETAFIM.COM) FOR SUGGESTED SPACING.

2. LENGTH OF LONGEST DRIPLINE LATERAL SHOULD NOT EXCEED THE MAXIMUM SPACING SHOWN IN THE ACCOMPANYING TABLE.

28014



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3016 FILBERT street OAKLAND, CA 94608 510 . 595 0688 www.hooddesignstudio.com











Project Number:

21020:1 Drawn by: DLB

Checked by:

Date:

April 28, 2023 Revisions:

Scale: as noted

Sheet Name:

Irrigation Notes & Details

Submission:


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Sheet Number:

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LINE FLUSHING VALVE PLUMBED TO PVC OR POLY START CONNECTION MALE ADAPTER - LINE FLUSHING VALVE PLUMBED TO PVC AREA PERIMETER LINE FLUSHING VALVE
PLUMBED TO PVC OR POLY - START CONNECTION -PVC OR POLY EXHAUST HEADER - AREA PERIMETER - EXHAUST HEADER -PVC OR POLY SUPPLY HEADER - DRIPLINE TEE **TUBING LATERAL TUBING** START CÖNNECTION SEE DETAIL 4 OF 4 - AIR/VACUUM RELIEF VALVE (PLUMBED TO DRIPLINE **ONE AT EACH HIGH POINT)** VALVE WITH DISC FILTER AND PRV EXHAUST HEADER **BLANK TUBING CENTERED** ON MOUND OR BERM BLANK TUBING CENTERED - AREA PERIMETER ON MOUND OR BERM AIR/VACUUM RELIEF
VALVE (PLUMBED TO
DRIPLINE AT EACH BLANK TUBING (CENTERED ON MOUND OR BERM) HIGH POINT) -TUBING LATERAL - SUPPLY HEADER SUPPLY HEADER
REMOTE CONTROL VALVE WITH - AIR/VACUUM RELIEF REMOTE CONTROL VALVE DISC FILTER AND PRV VALVE WITH DISC FILTER AND PRV - PERIMETER LATERALS 2" TO 4" FROM EDGE DRIPLINE INSTALLATION



QUICK COUPLER VALVE

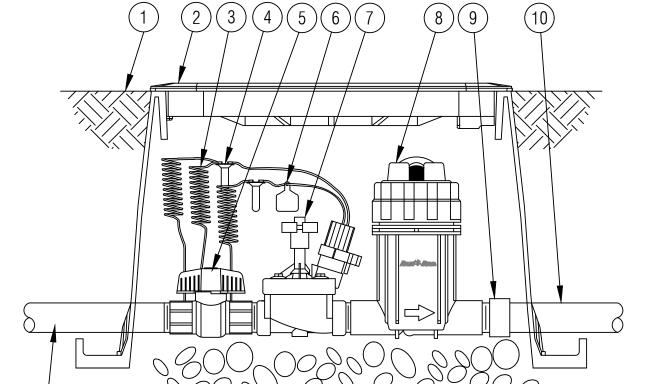QCV RAINBIRD MODEL # 5-RC,


KEY# 55-K, HOSE SWIVEL # SH-2

Irrigation Design & Consulting

www.wc3design.com Tel: (844) 231-7042 Columbus, OH Louisville, KY

Pittsburgh, PA

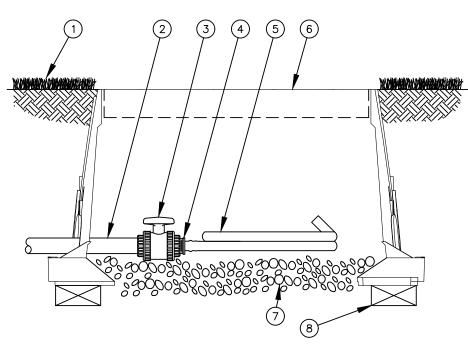- (1) FINISH GRADE/TOP OF MULCH
- 2 VALVE BOX WITH COVER: RAIN BIRD VB-STD
- (3) 30-INCH LINEAR LENGTH OF WIRE, COILED
- (4) WATERPROOF CONNECTION:
- (5) 1-INCH BALL VALVE
- (6) ID TAG
- 7 REMOTE CONTROL VALVE: RAIN BIRD PESB (INCLUCED IN XCZPGA-100-PRF KIT)
- (8) PRESSURE REGULATING QUICK CHECK BASKET FILTER: RAIN BIRD PRB-QKCHK-100 (INCLUDED IN XCZPGA-100-PRF KIT)
- (9) PVC SCH 40 FEMALE ADAPTOR
- (10) LATERAL PIPE
- (11) MAINLINE PIPE
- (12) 3-INCH MINIMUM DEPTH OF 3/4-INCH WASHED GRAVEL





(2) PVC DRIP MANIFOLD PIPE

③ PVC 1" X ¾ TRUE UNION BALL VALVE (4) EASY FIT MIPT X BARB ADAPTER:

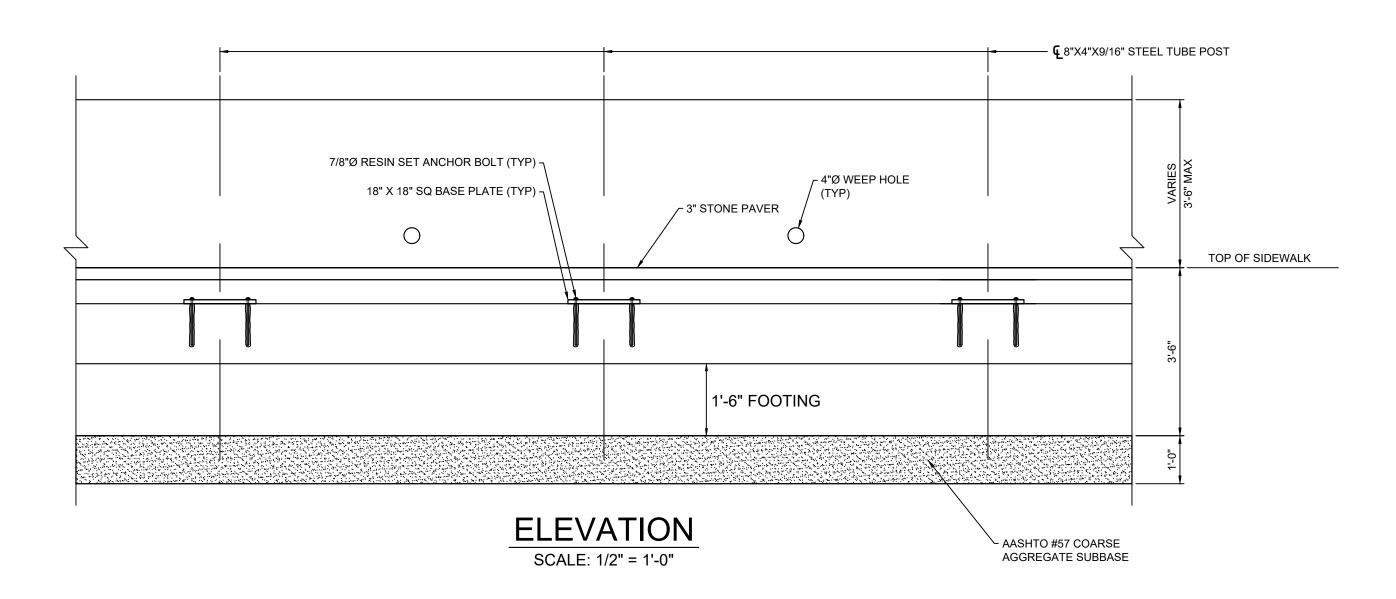
RAIN BIRD XFD-MA-075 (5) LANDSCAPE DRIPLINE TUBING:

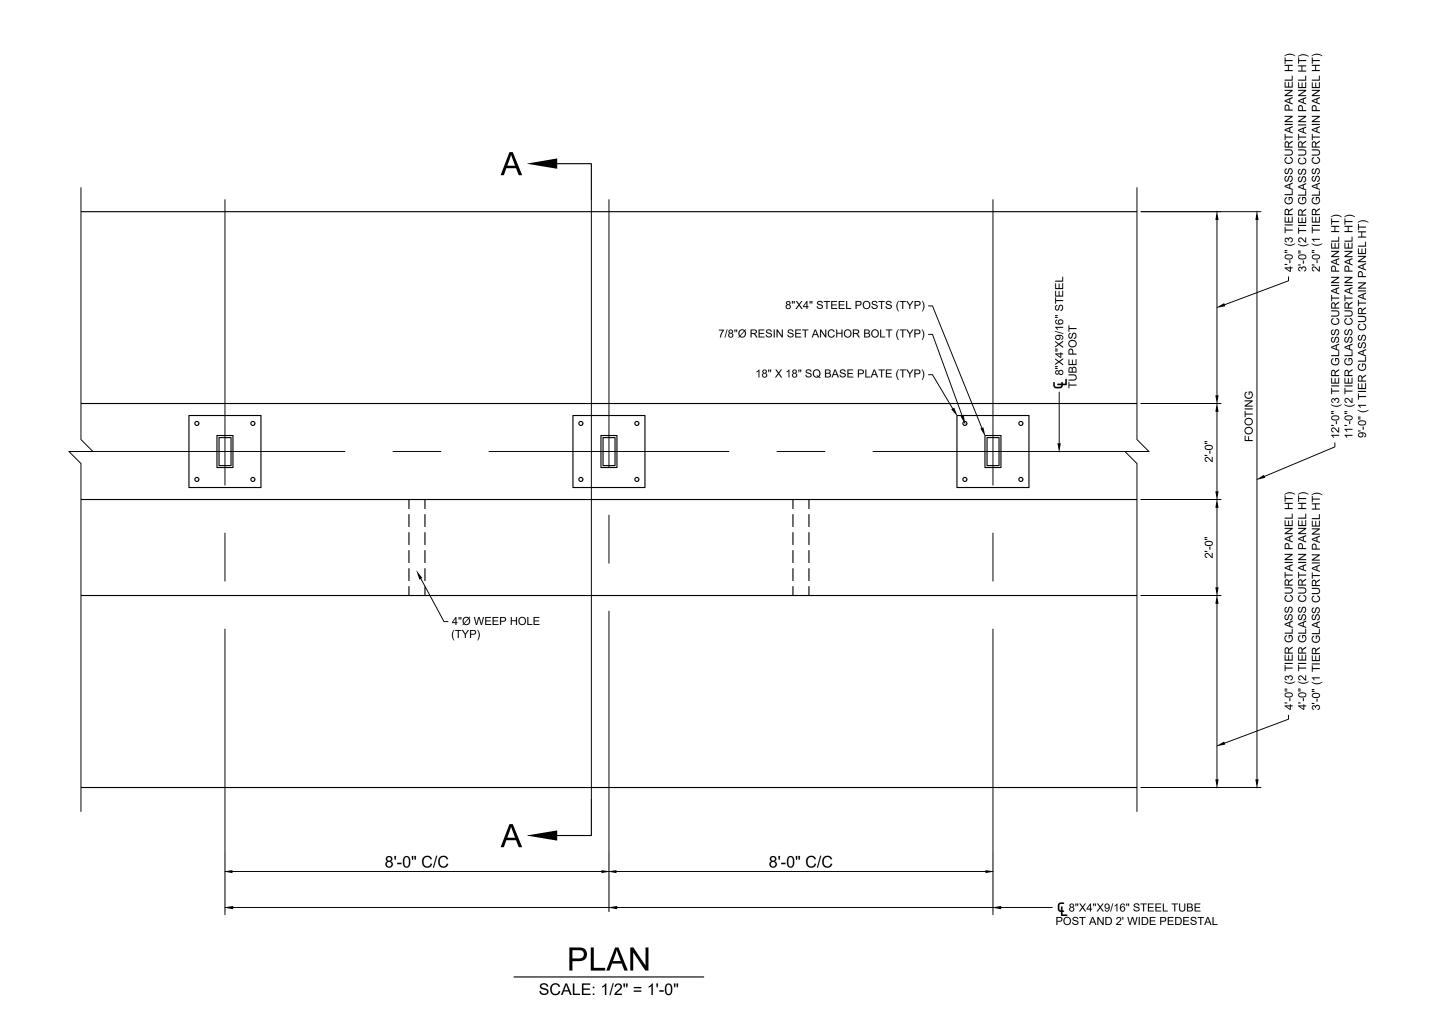
RAIN BIRD XF SERIES BLANK TUBING (6) 12-INCH VALVE BOX WITH COVER: RAIN BIRD VB-STD

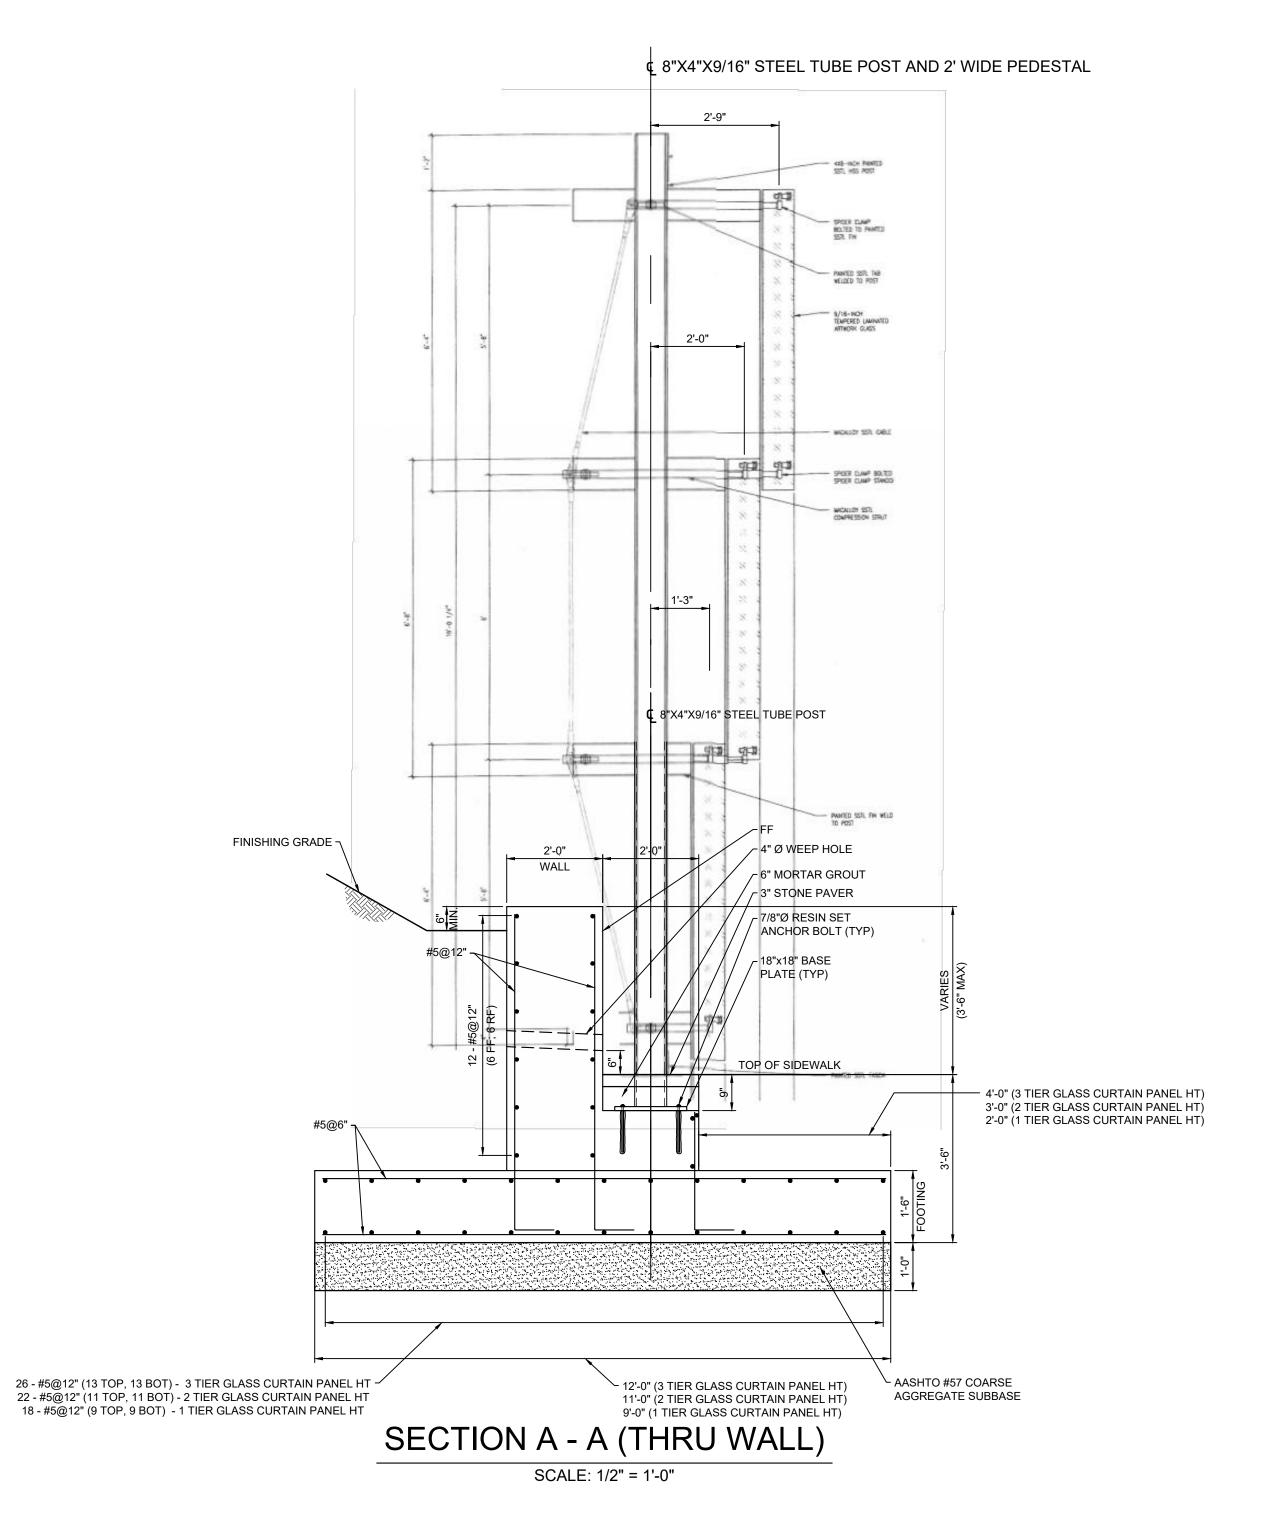
(7) 3-INCH MINIMUM DEPTH OF 3/4-INCH WASHED GRAVEL (8) BRICK (1 OF 2)

DRIP ZONE VALVE KIT

FLUSH VALVE







Landscape Architecture

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Lower Hill-Curtain Call Pittsburgh, PA

Project Number: 21020:1

21020:1 Drawn by: MEL

Checked by:

JRV

Date: **April 28, 2023**

Revisions:

Scale:

Sheet Name:


STRUCTURE FOUNDATION
PLAN, ELEVATION, AND
SECTION


Submission:


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SECTION A - A (THRU WALL)

BEYOND CURTAIN ENDS

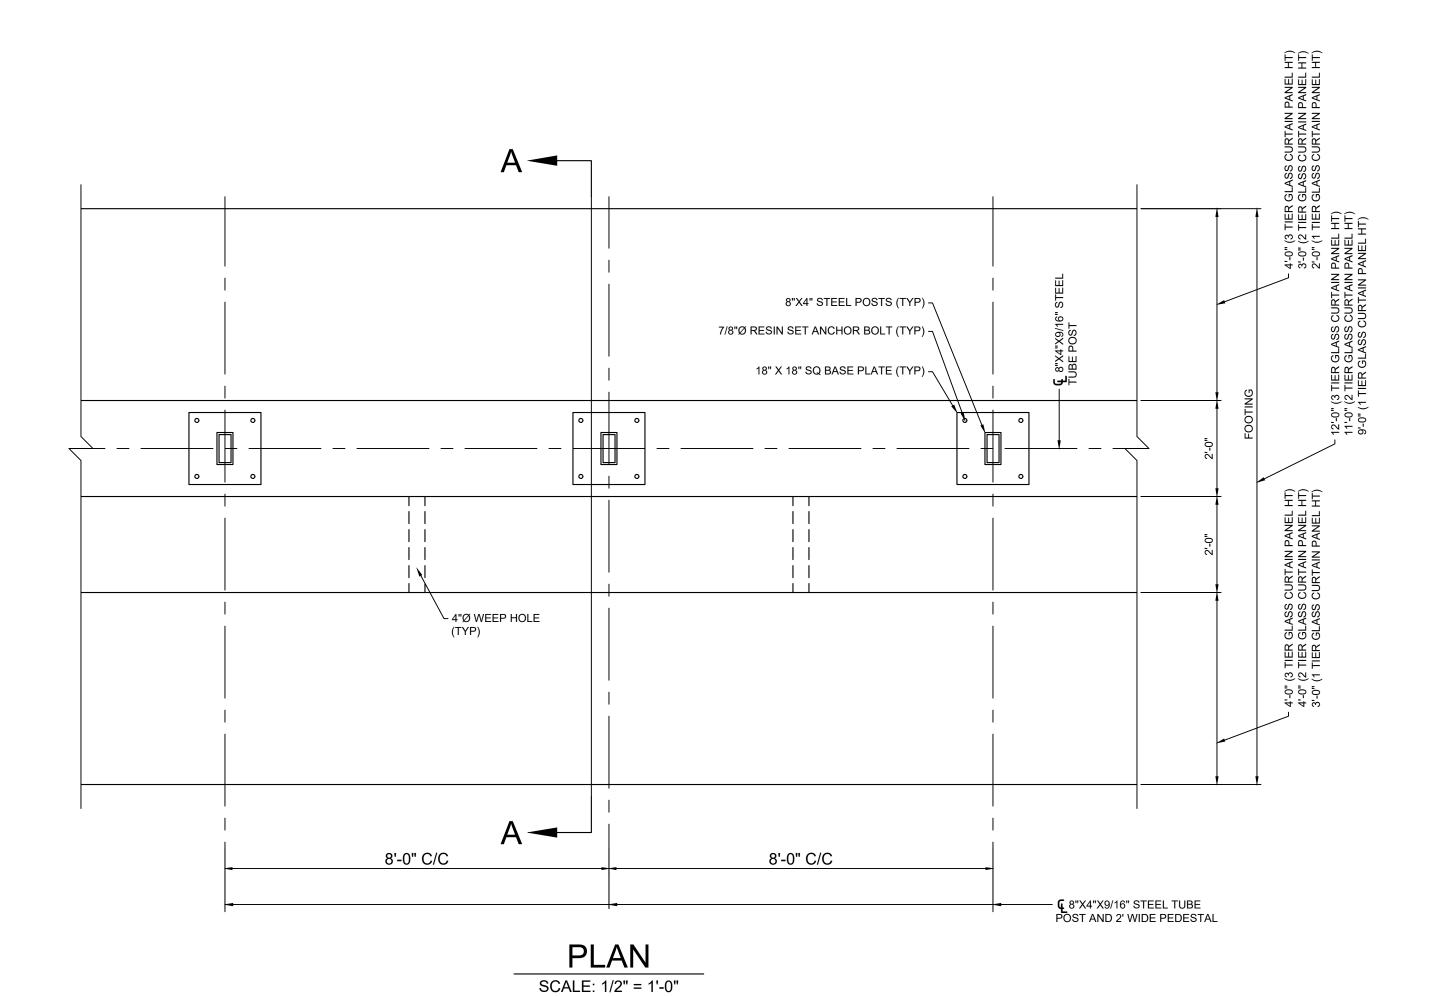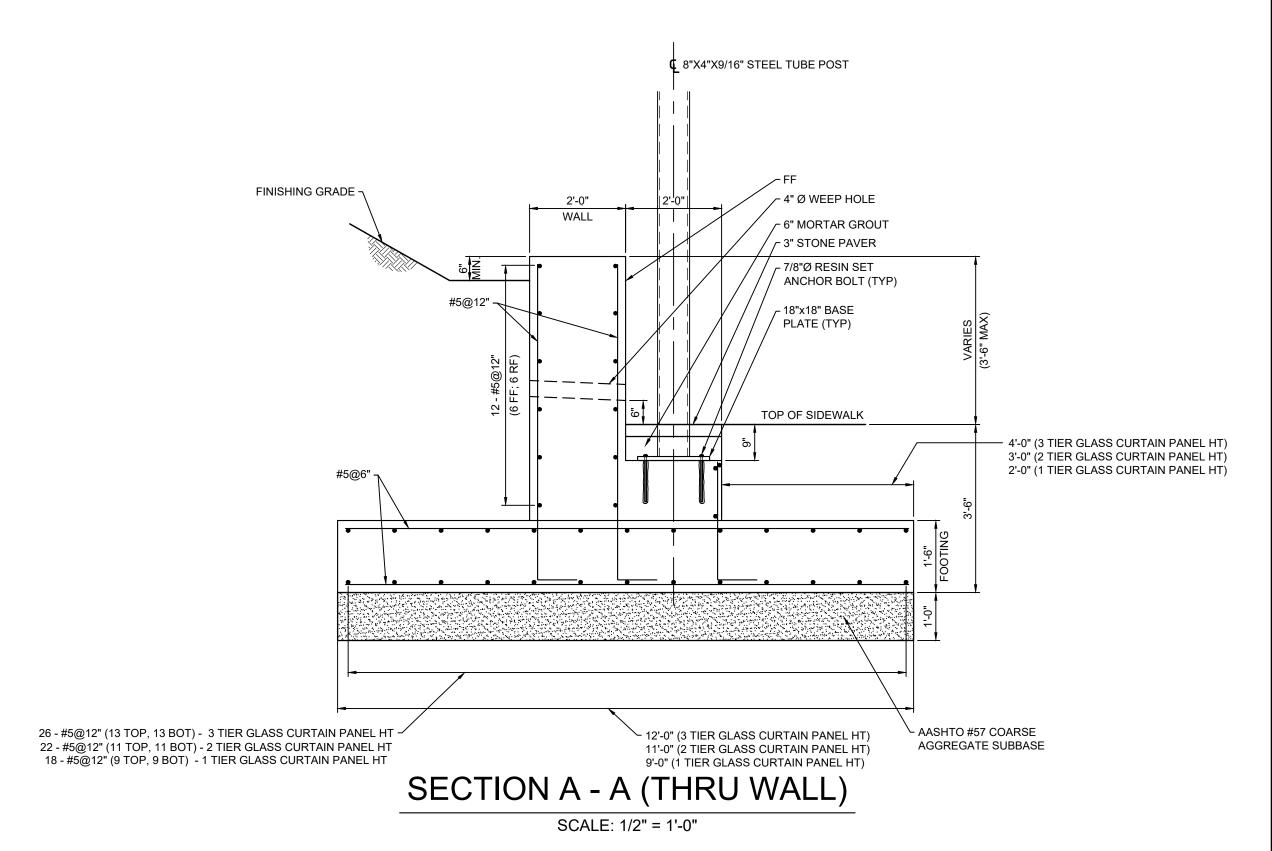SCALE: 1/2" = 1'-0"



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Lower Hill-Curtain Call
Pittsburgh, PA

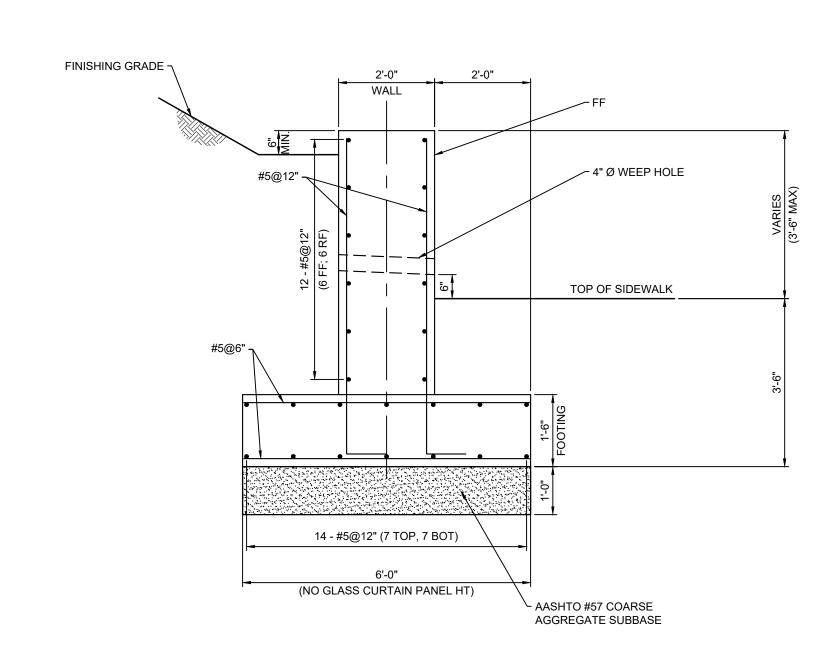Project Number: 21020:1

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Scale

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STRUCTURE FOUNDATION DETAILS


Submission:

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S-101

LIGHT POLE FOUNDATION PLAN SCALE: 1/2" = 1'-0"



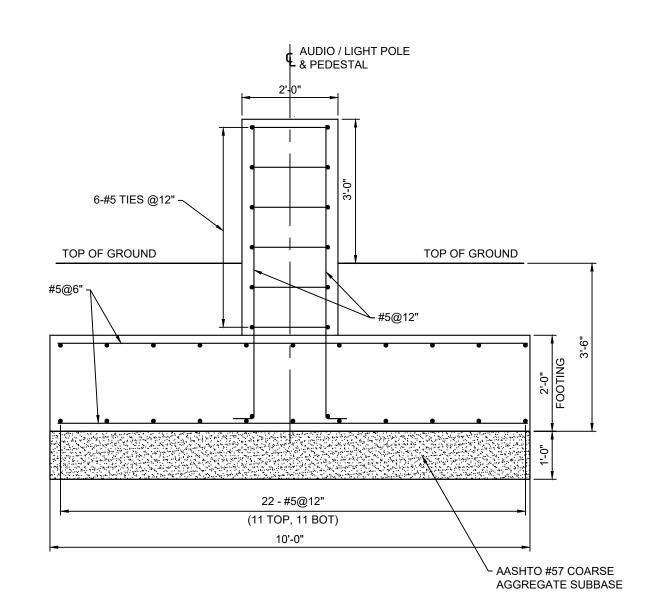SECTION A-A
(THRU FOUNDATION)

SCALE: 1/2" = 1'-0"



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AUDIO AND LIGHTING FOUNDATION DETAILS

Submission:

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Sheet Number:

S-102

STRUCTURAL NOTES:

GENERAL

- 1. AT NO ADDITIONAL COST TO THE OWNER, CONTRACTOR SHALL VISIT AND EXAMINE THE SITE TO FULLY UNDERSTAND ALL THE CONDITIONS PERTAINING TO THE SCOPE OF WORK, UNDERSTAND DIFFICULTIES TO BE ENCOUNTERED AND MATERIALS REQUIRED FOR THE COMPLETE INSTALLATION OF THE WORK SHOWN IN THE BIDDING/ CONTRACT DOCUMENTS. CONTRACTOR SHALL MODIFY LAYOUT WITH THE APPROVAL OF THE ENGINEER WHERE REQUIRED TO CLEAR UNFORESEEN OBSTRUCTIONS AT NO ADDITIONAL COST TO THE OWNER.
- 2. ALL CONSTRUCTION OPERATIONS SHALL BE ACCOMPLISHED IN ACCORDANCE WITH APPLICABLE STATE STATUTES AND U.S. OCCUPATIONAL SAFETY AND HEALTH ADMINISTRATION REGULATIONS (OSHA). COPIES OF OSHA STANDARDS MAY BE PURCHASED FROM THE U.S. GOVERNMENT PRINTING OFFICE. THE CONTRACTOR ALONE WILL BE RESPONSIBLE FOR THE EXECUTION OF THE WORK IN ACCORDANCE WITH ALL APPLICABLE HEALTH AND SAFETY REQUIREMENTS. THE ENGINEER SHALL NOT INSPECT THE WORK OR THE METHODS OF CONSTRUCTION FOR COMPLIANCE WITH THESE REQUIREMENTS.
- 3. COORDINATE WITH OWNER FOR APPROVAL OF ANY CONSTRUCTION RELATED UTILITY SYSTEMS INTERRUPTIONS OR OUTAGES. SHUTDOWN OF OPERATING EQUIPMENT REQUIRED TO FACILITATE CONTRACTORS WORK WILL BE DONE BY OWNER ONLY.
- 4. ALL DIMENSIONS ARE TO BE VERIFIED EITHER BY FIELD MEASUREMENTS FOR EXISTING STRUCTURES OR BY SHOP DRAWINGS FOR EQUIPMENT FURNISHED. STRUCTURAL DIMENSIONS NOT SHOWN BUT CONTROLLED BY OR RELATED TO EQUIPMENT SHALL BE VERIFIED BY THE CONTRACTOR WITH THE MANUFACTURER PRIOR TO CONSTRUCTION.
- 5. IF A CONFLICT IS FOUND BETWEEN DIFFERENT PORTIONS OF THE CONTRACT DOCUMENTS, THE CONTRACTOR SHALL NOTIFY THE ENGINEER IMMEDIATELY. CONTINUED CONSTRUCTION OF THE AREA IN CONFLICT SHALL BE AT THE CONTRACTOR'S OWN RISK UNTIL THE CONFLICT IS RESOLVED BY THE ENGINEER.
- 6. THE CONTRACTOR IS SOLELY RESPONSIBLE FOR THE SAFE ERECTION OF ALL STRUCTURES AND IS TO PROVIDE ALL NECESSARY BRACING AND SUPPORTS.
- 7. ALL NEW CONSTRUCTION MATERIALS SHALL HAVE A MINIMUM TWO-HOUR FIRE RATING.
- 8. STRUCTURAL DESIGN SPECIFICATIONS
 - INTERNATIONAL BUILDING CODE (IBC)
 - CITY OF PITTSBURGH BUILDING STANDARDS AND ORDINANCES
 - AISC MANUAL OF STEEL CONSTRUCTION ALLOWABLE STRESS DESIGN
 - ACI318 BUILDING CODE REQUIREMENTS FOR STRUCTURAL CONCRETE
 - AWS D1.1 M/D1.1 STRUCTURAL WELDING CODE STEEL
- 9. DESIGN WIND LOAD OF 12.8 PSF (WIND VELOCITY OF 90 MPH WITH 3-SECOND GUSTS)
- 10. PROVIDE MATERIALS AND PERFORM WORK IN ACCORDANCE WITH THE PENNSYLVANIA DEPARTMENT OF TRANSPORTATION SPECIFICATIONS PUBLICATION 408/2011 AND CONTRACT SPECIFICATIONS.

CONCRETE

- 1. PROVIDE 2 INCHES CONCRETE COVER ON REINFORCEMENT BARS, EXCEPT AS NOTED.
- 2. USE PENNDOT CLASS AA CEMENT CONCRETE (f'c = 4,000 PSI) IN ACCORDANCE WITH THE REQUIREMENTS OF ACI 301, PRODUCED AND TRANSPORTED IN ACCORDANCE WITH THE REQUIREMENTS OF ASTM C94.
- 3. A HIGHER-CLASS CONCRETE MAY BE SUBSTITUTED FOR A LOWER-CLASS CONCRETE AT NO ADDITIONAL COST TO THE OWNER.
- PROVIDE GRADE 60 REINFORCING STEEL BARS THAT MEET THE REQUIREMENTS OF ASTM A 615, A996 OR A706. DO NOT WELD GRADE 60 REINFORCING STEEL BARS UNLESS SPECIFIED. GRADE 40 REINFORCING STEEL BARS MAY BE SUBSTITUTED WITH A PROPORTIONAL INCREASE IN CROSS-SECTIONAL AREA. DO NOT USE RAIL STEEL ASTM A996 REINFORCING BARS WHERE BENDING OR WELDING OF THE REINFORCEMENT BARS IS INDICATED.
- 5. USE EPOXY-COATED REINFORCING BARS UNLESS INDICATED OTHERWISE.
- RAKE-FINISH ALL HORIZONTAL CONSTRUCTION JOINTS, EXCEPT AS INDICATED.
- 7. CHAMFER EXPOSED CONCRETE EDGES 1 INCH BY 1 INCH, EXCEPT AS NOTED.
- 8. ALL DIMENSIONS SHOWN ARE HORIZONTAL EXCEPT AS NOTED.
- 9. DIMENSIONS SHOWN ARE FOR A NORMAL TEMPERATURE OF 68 DEGREES FAHRENHEIT.

STRUCTURAL STEEL

- 1. STEEL ERECTOR SHALL REVIEW AND UTILIZE SHOP AND ERECTION DRAWINGS PREPARED BY THE FABRICATOR, AND FURNISH ANY ANCHOR BOLTS AND/OR EMBEDMENTS NOT FURNISHED WITH THE FABRICATED STEEL PRE-PURCHASED BY THE OWNER.
- 2. STRUCTURAL STEEL SHALL BE IN CONFORMANCE WITH ASTM A709 GRADE 50 (Fy = 50 KSI), UNLESS OTHERWISE DESIGNATED ON THE DRAWINGS.
- 3. STRUCTURAL STEEL TUBING SHALL BE IN CONFORMANCE WITH ASTM A500, GRADE B, UNLESS OTHERWISE DESIGNATED ON THE DRAWINGS.
- 4. BOLTS IN STRUCTURAL STEEL CONNECTIONS SHALL BE ASTM A325 UNLESS OTHERWISE DESIGNATED ON THE DRAWINGS.
- 5. ANCHOR BOLTS SHALL BE IN CONFORMANCE WITH ASTM F1554, 55 KSI YIELD STRENGTH, UNLESS OTHERWISE DESIGNATED ON THE DRAWINGS.
- 6. THREADED RODS SHALL BE STAINLESS STEEL IN CONFORMANCE WITH ASTM F593, GRADE 304, UNLESS OTHERWISE DESIGNATED ON THE DRAWINGS.
- 7. USE E-70XX ELECTRODES FOR WELDING WHICH SHALL BE PERFORMED IN CONFORMANCE WITH AWS D 1.1 M/D 1.1.
- 8. PRIOR TO PLACING WELD, THOROUGHLY CLEAN ALL PORTIONS OF ALL SURFACES TO RECEIVE WELDS OF ALL FOREIGN MATTER, INCLUDING PAINT FILM, FOR A DISTANCE OF 2 INCHES FROM EACH SIDE OF THE OUTSIDE LINES OF THE WELD.
- 9. TACK WELDS SHALL BE MADE WITH THE SAME TYPE OF ELECTRODE AND INCORPORATE IN THE FINAL WELD. NO OTHER TACK WELDING WILL BE PERMITTED.
- 10. STRUCTURAL STEEL SHALL BE GALVANIZED IN CONFORMANCE WITH ASTM A153.



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Lower Hill-Curtain Call Pittsburgh, PA

Project Number: 21020:1

Drawn by: **MEL**

Checked by:

JRV

April 28, 2023

Revisions:

Sca

Sheet Name:
STRUCTURAL NOTES

Submission:

100% Construction Documents

Sheet Number:

5-103

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GENERAL NOTES:

- CONSTRUCTION DETAILS NOT SHOWN ON THE DRAWINGS ARE TO CONFORM TO PA DEPARTMENT OF TRANSPORTATION STANDARD DRAWINGS: RC-80M DATED JUNE 1, 2010 RC-84M DATED JUNE 1, 2010
- 2. THE STANDARD SPECIFICATIONS FOR THIS PROJECT ARE PA DEPARTMENT OF TRANSPORTATION SPECIFICATIONS PUBLICATION 408/2020, AND ALL OF ITS SUPPLEMENTS AND SPECIAL PROVISIONS.
- 3. COORDINATE METERED ELECTRIC SERVICE WITH DUQUESNE LIGHT COMIANY. CONTACT JIM SLOSS, 469 HERSHEY ROAD, PITTSBURGH, PA 15234 412-393-7814
- 4. PROVIDE A SEPARATE EQUIPMENT GROUNDING CONDUCTOR WITH ALL CIRCUITS. DO NOT CONNECT THE NEUTRAL TO GROUND. CONNECT THE EQUIPMENT GROUNDING CONDUCTOR TO EACH POLE. PROVIDE WITH THE SAME INSULATION AND SIZE AS THE CIRCUIT CONDUCTORS. THE EQUIPMENT GROUNDING CONDUCTOR IS INCLUDED WITH THE CIRCUIT ITEM QUANTITIES;
- PROVIDE HEAT SHRINK SPLICES IN JUNCTION BOXES THAT CANNOT BE PROVIDED WITH POSITIVE DRAINAGE.
- 6. ALL WORK TO BE PERFORMED AS REQUIRED BY APPLICABLE SECTION OF THE NATIONAL ELECTRIC CODE, LATEST EDITION, AND ALL GOVERNING LOCAL CODES, LAWS, AND/OR REGULATIONS.
- 7. SYSTEM AND EQUIPMENT GROUNDING CONTINUITY TO BE IN ACCORDANCE WITH THE NATIONAL ELECTRIC CODE AND AS SHOWN ON PLANS.
- 8. DRAWINGS ARE DIAGRAMMATIC AND ARE NOT INTENDED TO SHOW ALL DETAILS OF EXISTING CONSTRUCTION, MOUNTING, WIRING AND RACEWAYS. CONTRACTOR TO VERIFY DIMENSIONS PRIOR TO INSTALLATION. CONTRACTOR WILL COORDINATE ALL WORK WITH OTHER DIVISION TRADES TO PROVIDE A COMPLETE AND OPERABLE SYSTEM. LOCATE ALL FIXTURES, DEVICES, ETC. IN ORDER TO AVOID INTERFERENCES.
- 9. DO NOT SCALE DRAWINGS. UTILITY LOCATIONS ARE BASED ON EXISTING MAPPING. VERIFY UTILITY LOCATIONS AND ELEVATIONS PRIOR TO CONSTRUCTION OF TRENCHING AND POLE FOUNDATIONS.
- 10. THE CONTRACTOR SHALL WORK IN STRICT COORDINATION WITH LOCAL UTILITY COMPANIES TO DETERMINE THE EXACT LOCATION OF ALL EXISTING UNDERGROUND AND OVERHEAD UTILITY LINES PRIOR TO COMMENCEMENT OF THIS WORK. ALL DAMAGES INCURRED TO EXISTING UTILITIES WILL BE REPAIRED OR REPLACED BY THE CONTRACTOR AT NO ADDITIONAL PAYMENT. PER ACT 187, MAINTAIN A MINIMUM 18" CLEARANCE FROM ALL UNDERGROUND UTILITIES.
- 11. PROVIDE PULL BOX WHERE REQUIRED FOR EACH CONDUIT RUN TO LIMIT THE NUMBER OF BENDS TO 270° INCLUDING CONDUIT OFFSETS. INSTALL EXPANSION/DEFLECTION OF FITTINGS EVERY 150-FEET OF THE CONDUIT RUN.
- 12. WHERE DISSIMILAR METALS COME INTO CONTACT, PAINT THE JOINT INSIDE AND OUT WITH APPROVED COATING TO EXCLUDE MOISTURE FROM THE JOINT OR PROVIDE SUITABLE INSULATING BARRIERS SEPARATING THE METALS.
- 13. THREE WORKING DAYS PRIOR TO EXCAVATION, THE CONTRACTOR MUST CONTACT THE PA ONE CALL SYSTEM, INC. PHONE NUMBER IS 1-800-242-1776. SERIAL NUMBERS _ _, CITY OF PITTSBURGH.

	CABLE SCHEDULE	
(A)	3#10AWG, #10G	1" DBC
(A1)	2#10AWG, #10G	1" DBC
B	3#8AWG, #8G	1 1/2" DBC
⟨B1⟩	2#8AWG, #8G	1 1/2" DBC
	3#10AWG, #10G	1" DBC
(c)	2#12AWG (0-10V DIMMING ZONE 1) 2#12AWG (0-10V DIMMING ZONE 2) 2#12AWG (0-10V DIMMING ZONE 3) 2#12AWG (0-10V DIMMING ZONE 4) 2#12AWG (0-10V DIMMING ZONE 5) 2#12AWG (0-10V DIMMING ZONE 6)	1 1/2" DBC
	3#10AWG, #10G	1" DBC
D	2#12AWG (0-10V DIMMING ZONE 7) 2#12AWG (0-10V DIMMING ZONE 8) 2#12AWG (0-10V DIMMING ZONE 9) 2#12AWG (0-10V DIMMING ZONE 10)	1 1/2" DBC
(E)	2#10AWG #10G 2#12AWG (0-10V DIMMING ZONE 11	1 1/2" DBC
F	2#10AWG, #10G (ELV DIMMING ZONE 12) 2#10AWG (ELV DIMMING ZONE 13) 2#10AWG (ELV DIMMING ZONE 14) 2#10AWG (ELV DIMMING ZONE 15)	1 1/2" DBC
(F1)	2#10AWG, #10G	1" DBC
G	2#8AWG #12G (RECEPTACLE) 2#8AWG (RECEPTACLE)	1 1/2" DBC
$\langle H \rangle$	PULL CORD	1" DBC

ABBREVIATIONS:

С	CONDUIT
DBC	DIRECT BURIAL CONDUIT

DIA DIAMETER FT FOOT/FEET

GROUND

JUNCTION BOX

LT

LEFT **MANUFACTURER**

MAX MAXIMUM

MINIMUM

NTS **NOT TO SCALE** OCTAGONAL OCT

OH OVERHEAD

PROJ **PROJECTION**

WITH OUT

STA STATION

TYP

LEGEND:

LED POST TOP LUMINAIRE WITH MATCHING POST. 14' MOUNTING HEIGHT

LED UNDER BENCH STRIP LIGHTING

— LED LIGHTED HANDRAIL LUMINAIRE

□ REMOTE DRIVER JUNCTION BOX

LANDSCAPE JUNCTION BOX

— — DIRECT BURIAL CONDUIT (SIZED AS MARKED)

LIGHTING POWER SUPPLY ENCLOSURE (PAD MOUNTED)

A/V ENCLOSURE (POLE MOUNTED)

SURFACE MOUNT JUNCTION BOX 6"x6"x4" (STAINLESS STEEL WITH NEOPRENE COVER)

CURTAIN CALL ART LIGHTING ASSEMBLY SCHEDULE

PER

ASSEMBLY

HEIGHT

13

24

(FT)

WATTAGE

26W

26W

26W

26W

6W/LF

FIXTURE | FIXTURE | VOLTAGE

TYPE

LED

LED

LED

LED

LED

LED

(V)

120

120

120

120

120

ASSEMBLY

WATTAGE

DIMMING

0-10V

0-10V

0-10V

0-10V

0-10V

0-10V

MULTIHEAD LIGHT POLE (REFERENCE ART LIGHTING ASSEMBLY SCHEDULE)

Γ AT CURTAIN CALL

LIGHTING FIXTURE COMPONENT(S)

MANUFACTURER AND MODEL #

 LINEAR DOWNLIGHT
FASCIA (L2)

	PAR	K SITE LIGHT	ING FIX	TURE SCH	HEDULE *	•	
TYPE	CATALOG NUMBER	SOURCE	LUMENS	MOUNTING	MOUNTING HEIGHT	QUANTITY	DESCRIPTION
•	LANDSCAPE FORMS -ALCOTT #AC-048L3-035F-27K-UV1-14	60W LED 2700K	2870	ANCHOR BASE	14'	Х	
©	BEGA-US #77221-K3-BLK-79817	10W LED 2700K	643	ANCHOR BASE	39"	Х	
_	COLE LIGHTING #LR5P-LED-SS/1.9-REM	LED 2700K	205 PER FOOT		-	X	LIGHTED HANDRAIL, 1.9" DIA. REMOTE DRIVER WITH WATERPROOF JUNCTION BOXES
	GLLS VIVID S-160 STATIC #NF-11B-1-02-2W-E-WW-120J	LED 2700K	155 PER FOOT	UNDER BENCH	-	X	LED STRIP TO MOUNT UNDER BENCH. PROVIDE CHANNEL AND REMOTE DRIVER AND WATERPROOF JUNCTION BOXES.

LUMINAIRE: LUMENPULSE

LUMINAIRE: LUMENPULSE

LUMINAIRE: LUMENPULSE

LUMINAIRE: LUMENPULSE

#PL-T 6 R 18 BK SB AB

#PL-T 6 R 24 BK SB AB

ECOSENSE TROV

LUMINAIRE: LUMENPULSE

POLE: LUMENPULSE - LUMENTECH

POLE: LUMENPULSE - LUMENTECH

#L50-E48-06-27-90-MULTI-ASYM

#PL-T 6 R 13 BK SB AB

#LBM 27K WFL BK DIM SY UL 20FT BK UY SN

#LBM 27K NF LSLV BK DIM SY UL 20FT BK UY SN

#LBM 27K M LSLV BK DIM SY UL 20FT BK UY SN

#LBM 27K FL LSLV BK DIM SY UL 20FT BK UY SN

#LBM 27K WFL BK DIM SY UL 30FT BK UY SN

N/A

POLE: LUMENPULSE - LUMENTECH

* MA	UFACTURER'S AND CATALOG NUMBERS SHOWN ARE THE BASIS OF DESIGN.
EG	IVALENT PRODUCTS, APPROVED BY THE ENGINEER, ARE ALSO PERMITTED.

ASSEMBLY DESCRIPTION

MULTI-HEAD LIGHT POLE

MULTI-HEAD LIGHT POLE

MULTI-HEAD LIGHT POLE

LINEAR DOWNLIGHT AT CURTAIN WALL

FACSIA

ASSEMBLY

L1A

L1B

L1C

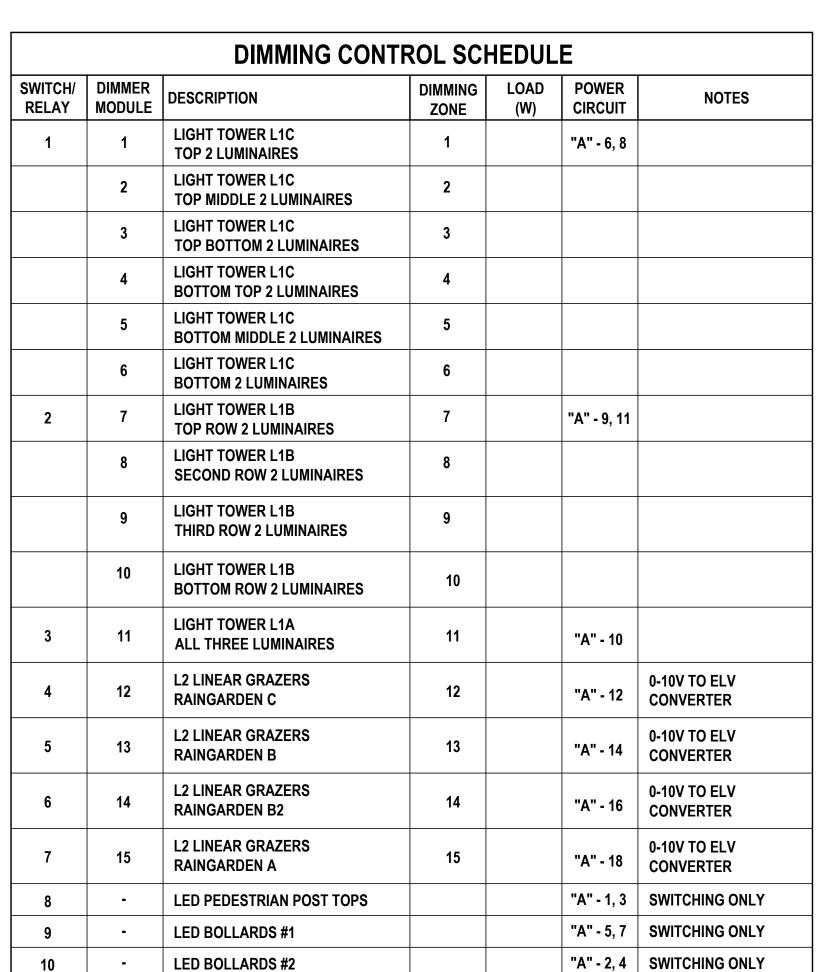
SYMBOL

 (\circ)

 \odot

 \odot

RELAY	MODULE	DESCRIPTION	DIMMING ZONE	LOAD (W)	CIRCUIT	NOTES
1	1	LIGHT TOWER L1C TOP 2 LUMINAIRES	1		"A" - 6, 8	
	2	LIGHT TOWER L1C TOP MIDDLE 2 LUMINAIRES	2			
	3	LIGHT TOWER L1C TOP BOTTOM 2 LUMINAIRES	3			
	4	LIGHT TOWER L1C BOTTOM TOP 2 LUMINAIRES	4			
	5	LIGHT TOWER L1C BOTTOM MIDDLE 2 LUMINAIRES	5			
	6	LIGHT TOWER L1C BOTTOM 2 LUMINAIRES	6			
2	7	LIGHT TOWER L1B TOP ROW 2 LUMINAIRES	7		"A" - 9, 11	
	8	LIGHT TOWER L1B SECOND ROW 2 LUMINAIRES	8			
	9	LIGHT TOWER L1B THIRD ROW 2 LUMINAIRES	9			
	10	LIGHT TOWER L1B BOTTOM ROW 2 LUMINAIRES	10			
3	11	LIGHT TOWER L1A ALL THREE LUMINAIRES	11		"A" - 10	
4	12	L2 LINEAR GRAZERS RAINGARDEN C	12		"A" - 12	0-10V TO ELV CONVERTER
5	13	L2 LINEAR GRAZERS RAINGARDEN B	13		"A" - 14	0-10V TO ELV CONVERTER
6	14	L2 LINEAR GRAZERS RAINGARDEN B2	14		"A" - 16	0-10V TO ELV CONVERTER
7	15	L2 LINEAR GRAZERS RAINGARDEN A	15		"A" - 18	0-10V TO ELV CONVERTER
8	-	LED PEDESTRIAN POST TOPS			"A" - 1, 3	SWITCHING ONLY
9	-	LED BOLLARDS #1			"A" - 5, 7	SWITCHING ONLY
10	-	LED BOLLARDS #2			"A" - 2, 4	SWITCHING ONLY
11	-	LED HANDRAIL			"A" - 17	SWITCHING ONLY
12	-	LED STRIP UNDER BENCH			"A" - 19	SWITCHING ONLY



COMMENTS

REFERENCE DRAWING E2.01 AND CURTAIN CALL ART

REFERENCE DRAWING E2.01 AND CURTAIN CALL ART

REFERENCE DRAWING E2.01 AND CURTAIN CALL ART

PROVIDE IP66 RATING. PROVIDE ELV MODULE #LDCM-

PLANS FOR MORE DETAILS. REFERENCE CURTAIN

CALL ART PLANS FOR MOUNTING DETAILS.

PL-120-010V-GR FOR EACH CIRCUIT RUN

PLANS FOR MORE DETAILS. REFERENCE CURTAIN

CALL ART PLANS FOR MOUNTING DETAILS.

PLANS FOR MORE DETAILS. REFERENCE CURTAIN

CALL ART PLANS FOR MOUNTING DETAILS.

Scale: N/A

Sheet Name:

General Notes

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/WK

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www.hooddesignstudio.com

510 . 595 0688

Pittsburgh, PA

Project Number:

Checked by: FB | DM

April 28, 2023

Revisions:

21020:1 Drawn by: DM | CT

studio 2

412.488.8822


Pittsburgh, Pennsylvania 15203

Submission:

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NOTES:

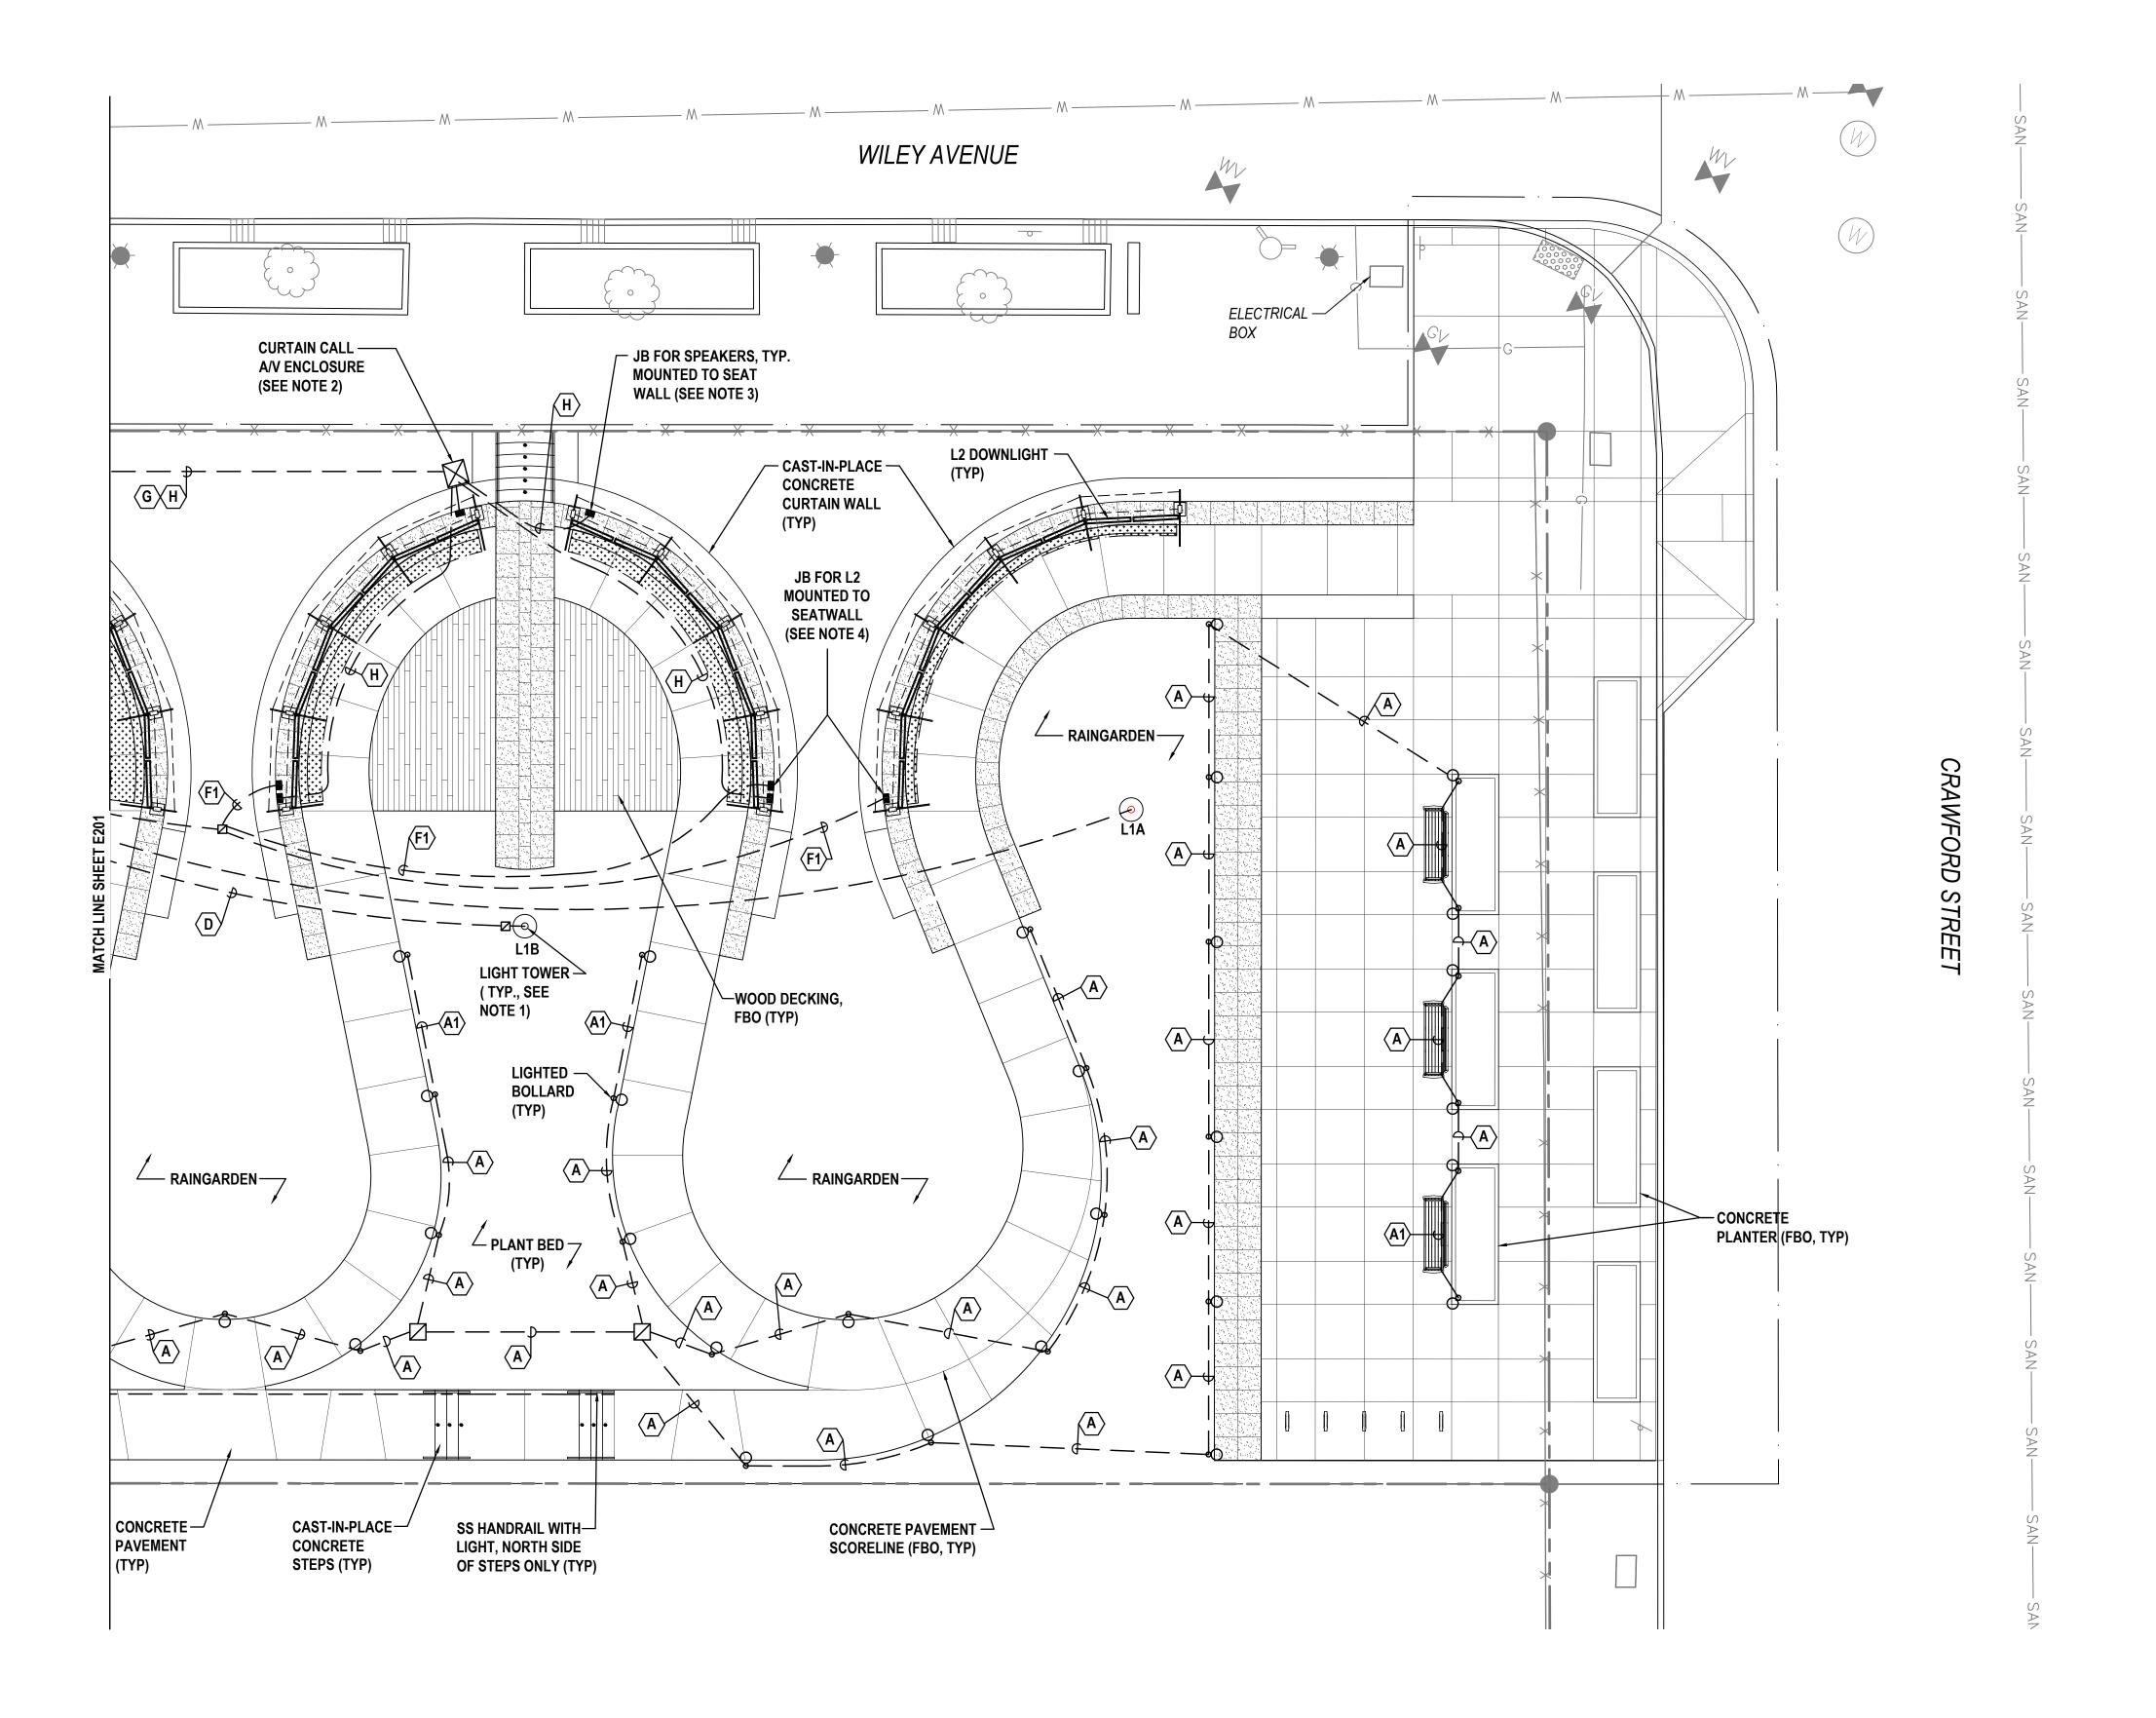- 1. REFERENCE CURTAIN CALL PUBLIC ART INSTALLATION PLANS.
- 2. REFERENCE AV PLANS TA-001 THROUGH TA-601. SEE MOUNTING DETAIL ON E302.
- 3. TRANSITION FROM DIRECT BURIAL TO EXPOSED CONDUIT (GALVANIZED RIGID STEEL) AT SEATWALL AND EXTEND CONDUIT TO THE A/V EQUIPMENT SURFACE MOUNTED JUNCTION BOX. PROVIDE FLEXIBLE 1" CONDUIT TO BOTTOM FITTING IN STEEL POST AND FROM TOP FITTING TO SPEAKER CLUSTER LOCATION. (TYPICAL OF 4 LOCATIONS.) REFERENCE AUDIO/VISUAL PLANS FOR ADDITIONAL DETAILS.
- 4. TRANSITION FROM DIRECT BURIAL TO EXPOSED CONDUIT (GALVANIZED RIGID STEEL) AT SEATWALL AND EXTEND CONDUIT TO THE 'L2' SURFACE MOUNTED JUNCTION BOX. PROVIDE FLEXIBLE 1" CONDUIT TO CONTINUOUS LINEAR DOWNLIGHTING (L2) MOUNTED TO 'L' ANGLE ABOVE CURTAIN WALL FASCIA. REFERENCE CURTAIN CALL ART PLANS.



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Scale: 0' 8'

Sheet Name:

Site Lighting Plan

Submission:

REFERENCES:

1. FOR GENERAL NOTES, SEE SHEET

3. FOR LIGHTING FIXTURE SCHEDULE,

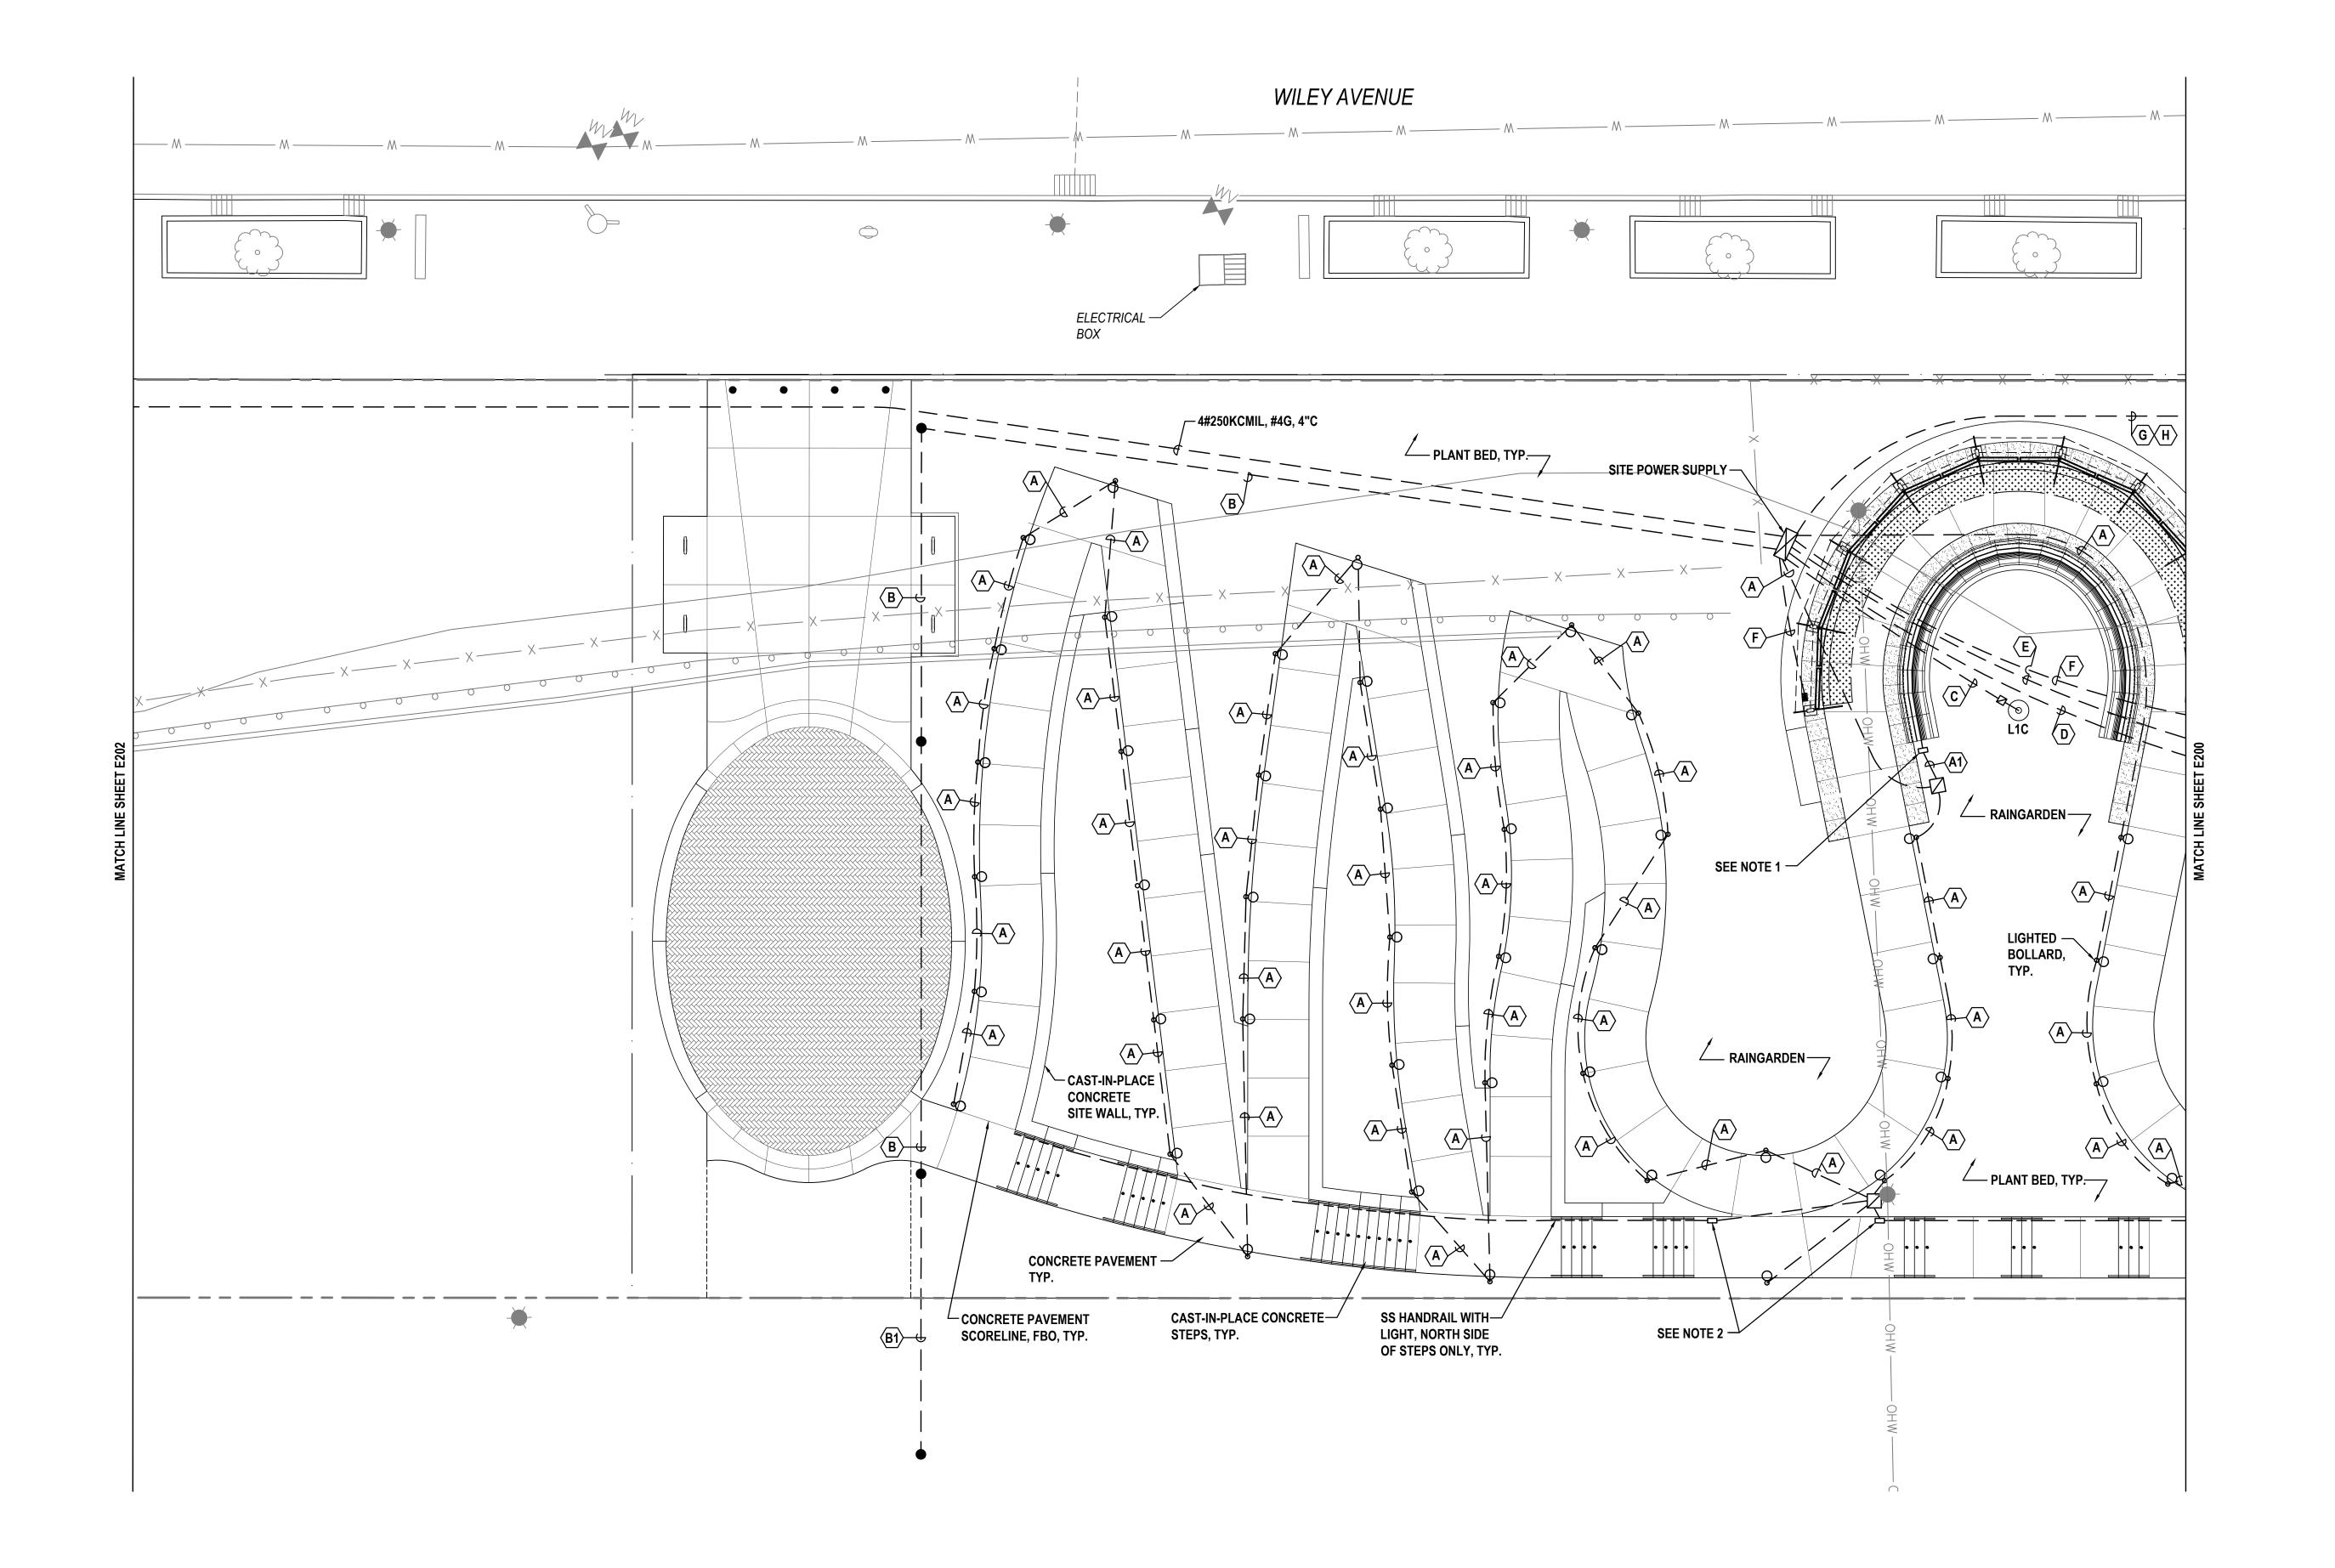
2. FOR LEGEND, SEE SHEET E100.

SEE SHEET E100.

100% Construction Documents

Sheet Number:

E200



NOTES:

- 1. REMOTE DRIVER JB FOR UNDER BENCH STRIP LIGHTING. COORDINATE LOCATION WITH ARCHITECT. REFERENCE LANDSCAPE PLANS FOR MOUNTING LOCATION.
- 2. REMOTE DRIVER JB FOR LIGHTED HANDRAIL. COORDINATE LOCATION WITH ARCHITECT. REFERENCE LANDSCAPE PLANS FOR MORE DETAILS.

REFERENCES:

- 1. FOR GENERAL NOTES, SEE SHEET E100.
- 2. FOR LEGEND, SEE SHEET E100.
- 3. FOR LIGHTING FIXTURE SCHEDULE, SEE SHEET E100.



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Date: **April 28, 2023**

Scale:

Sheet Name:

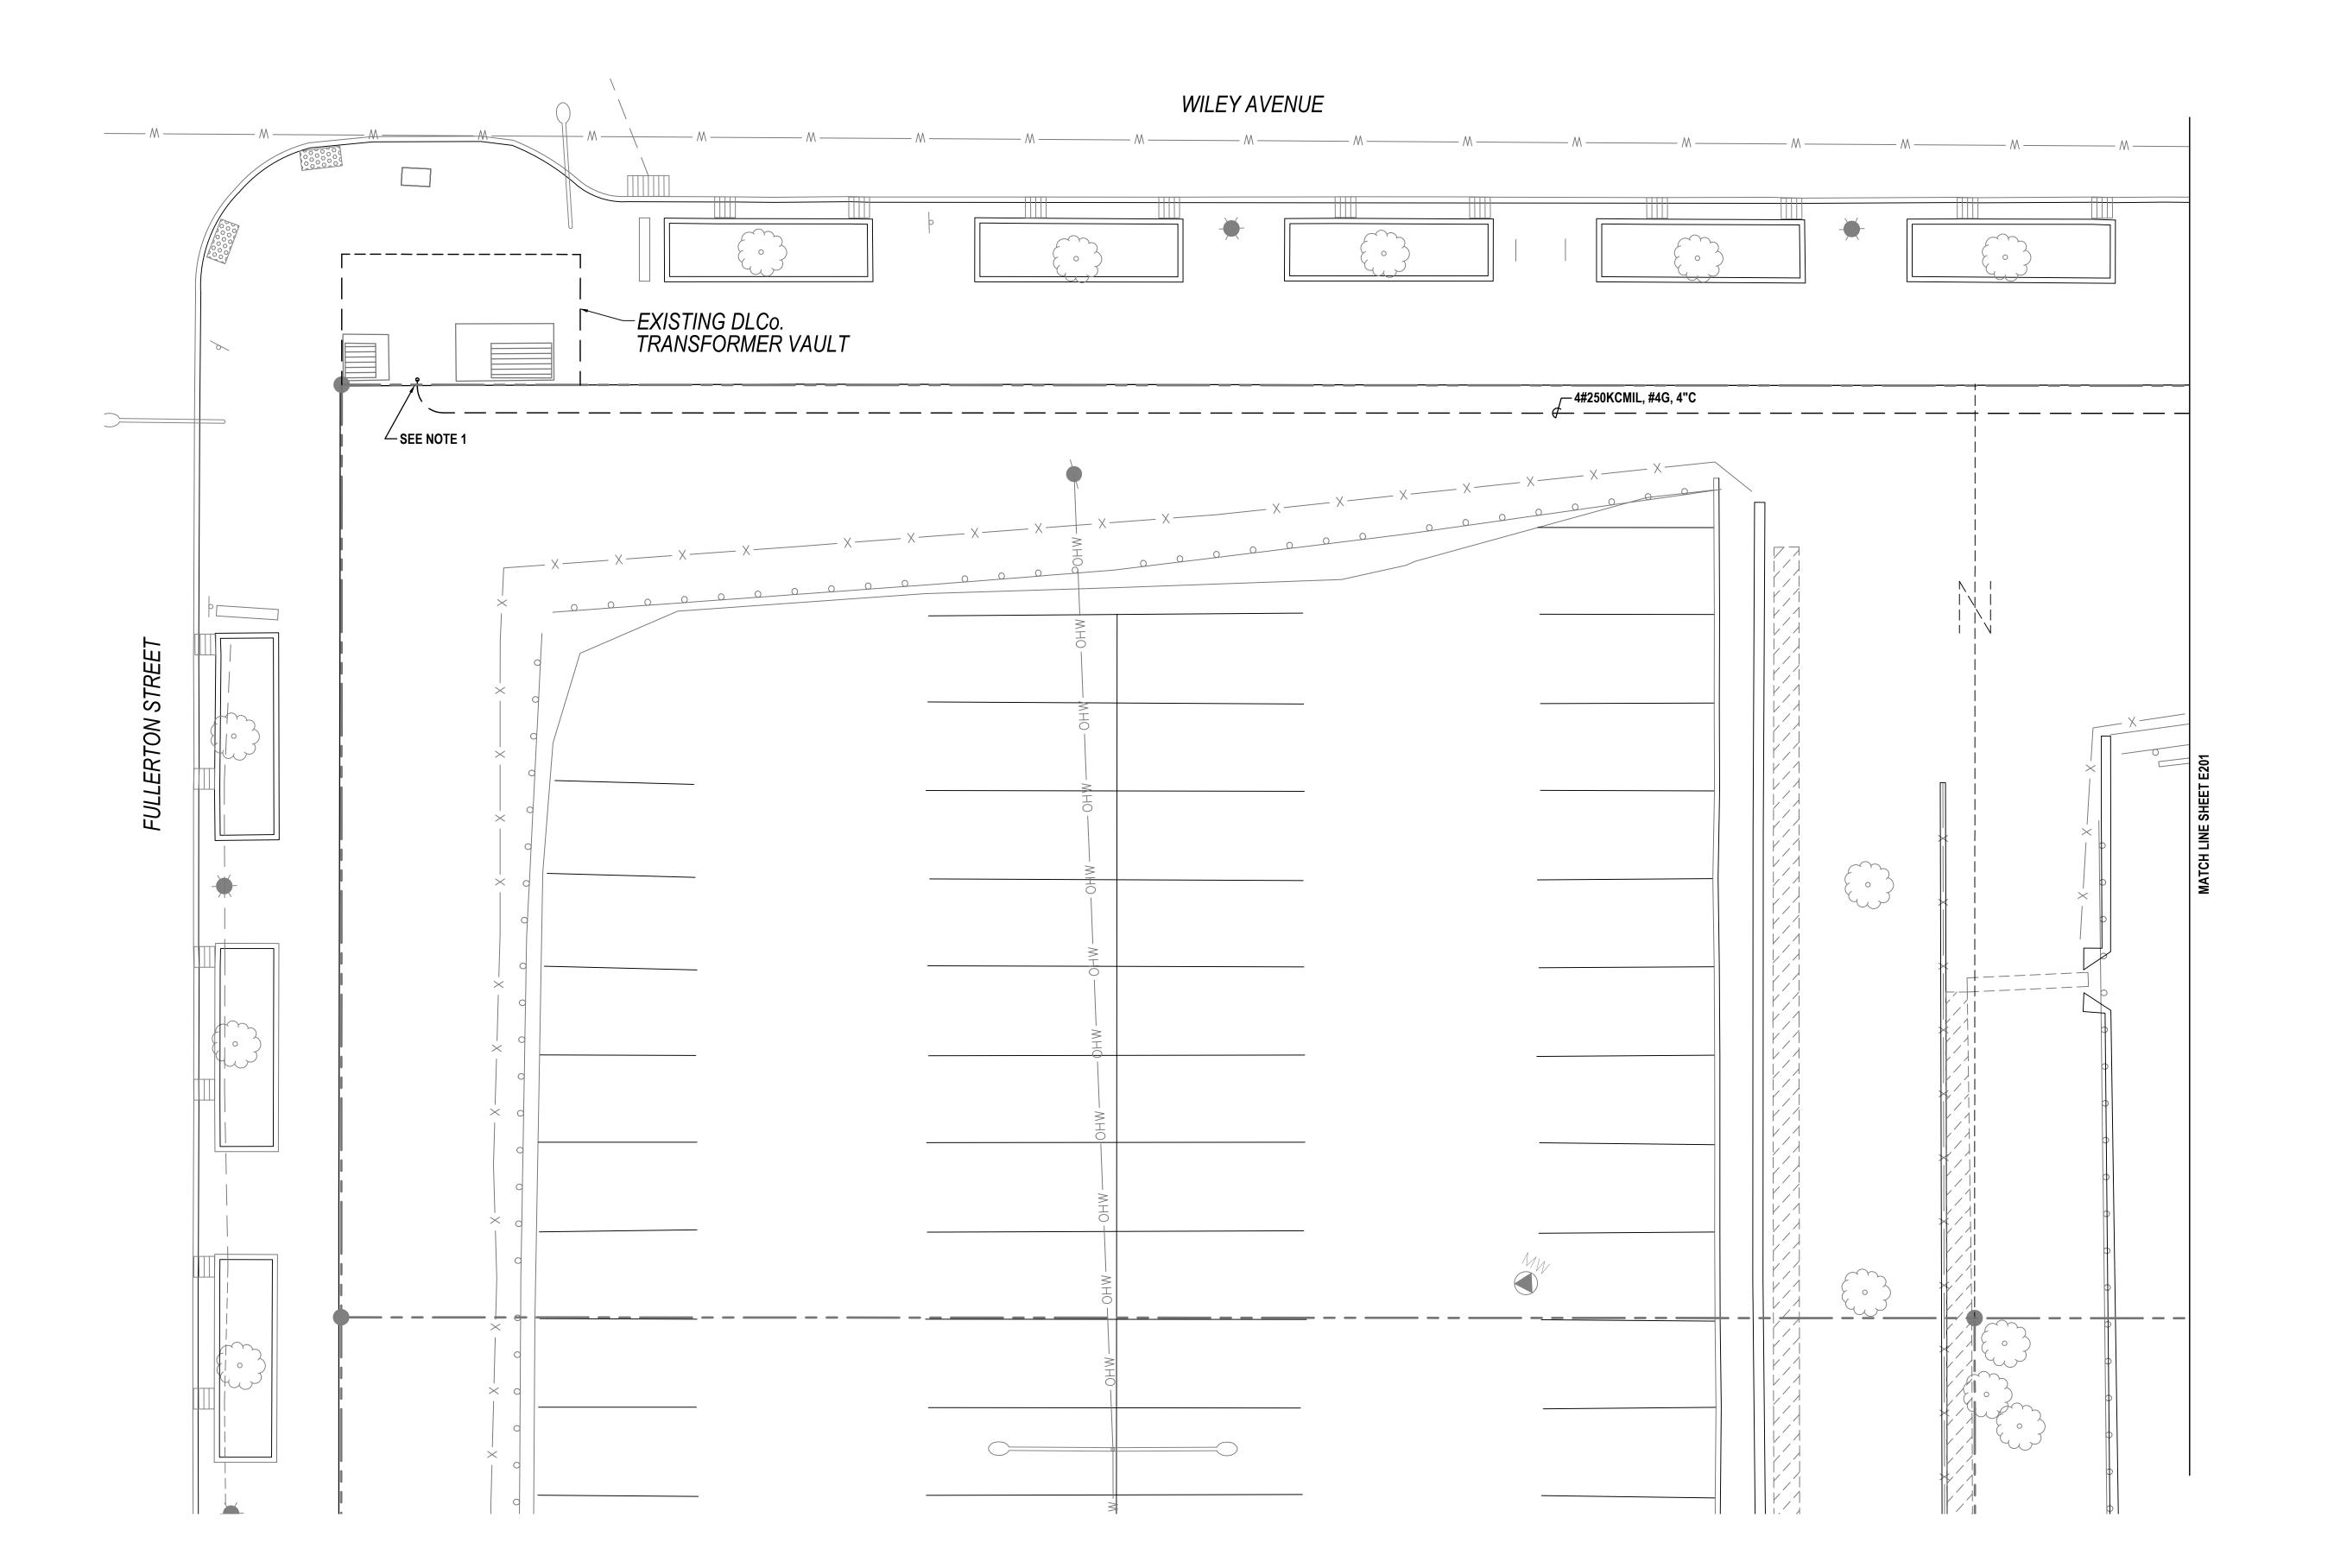
Site Lighting Plan

Submission:

100% Construction Documents

Sheet Number:

E201



NOTES:

1. COORDINATE SERVICE WITH DUQUESNE LIGHT COMPANY.

REFERENCES:

1. FOR GENERAL NOTES, SEE SHEET E100.

2. FOR LEGEND, SEE SHEET E100.

3. FOR LIGHTING FIXTURE SCHEDULE, SEE SHEET E100.



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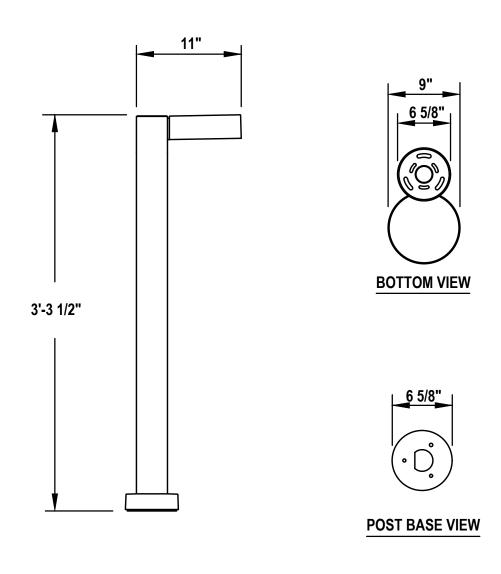
Site Lighting Plan

Submission:

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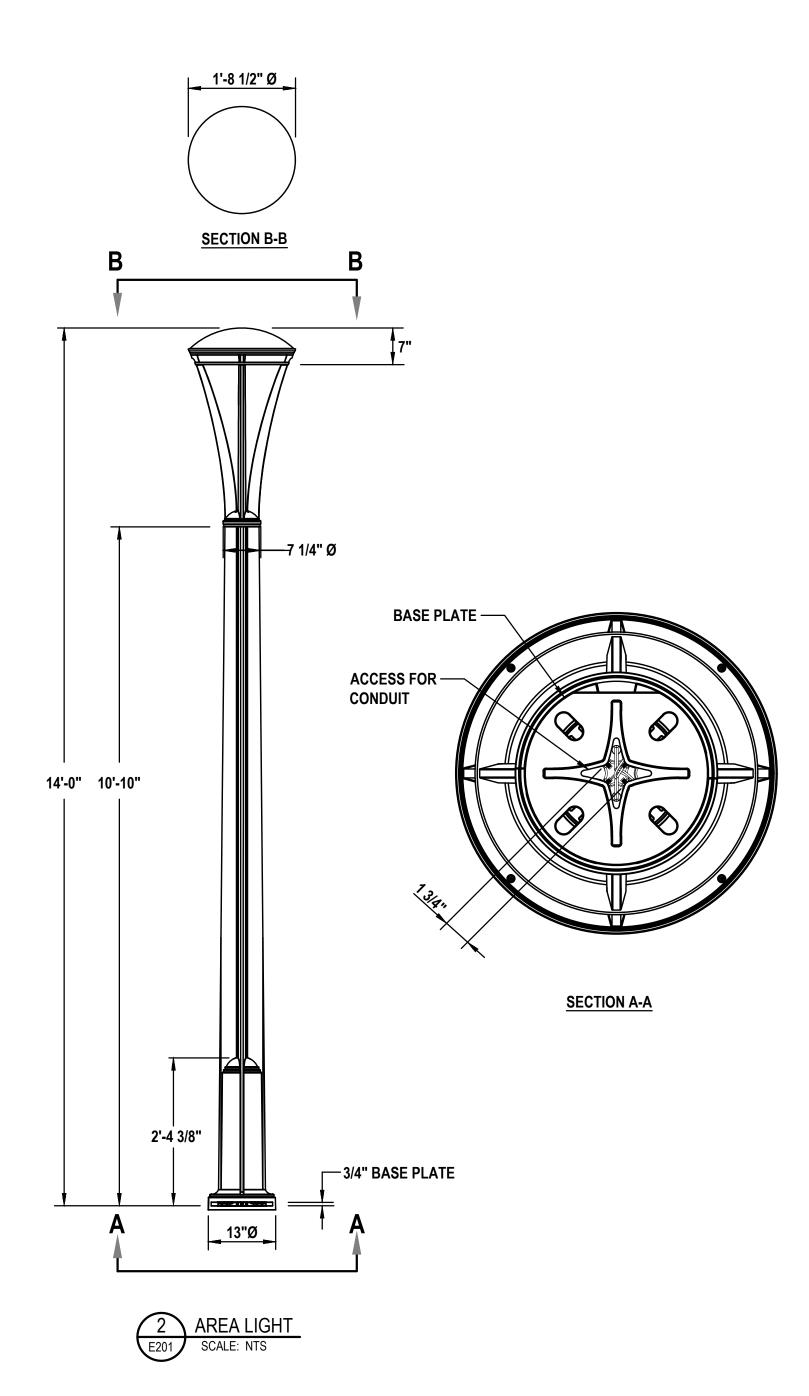
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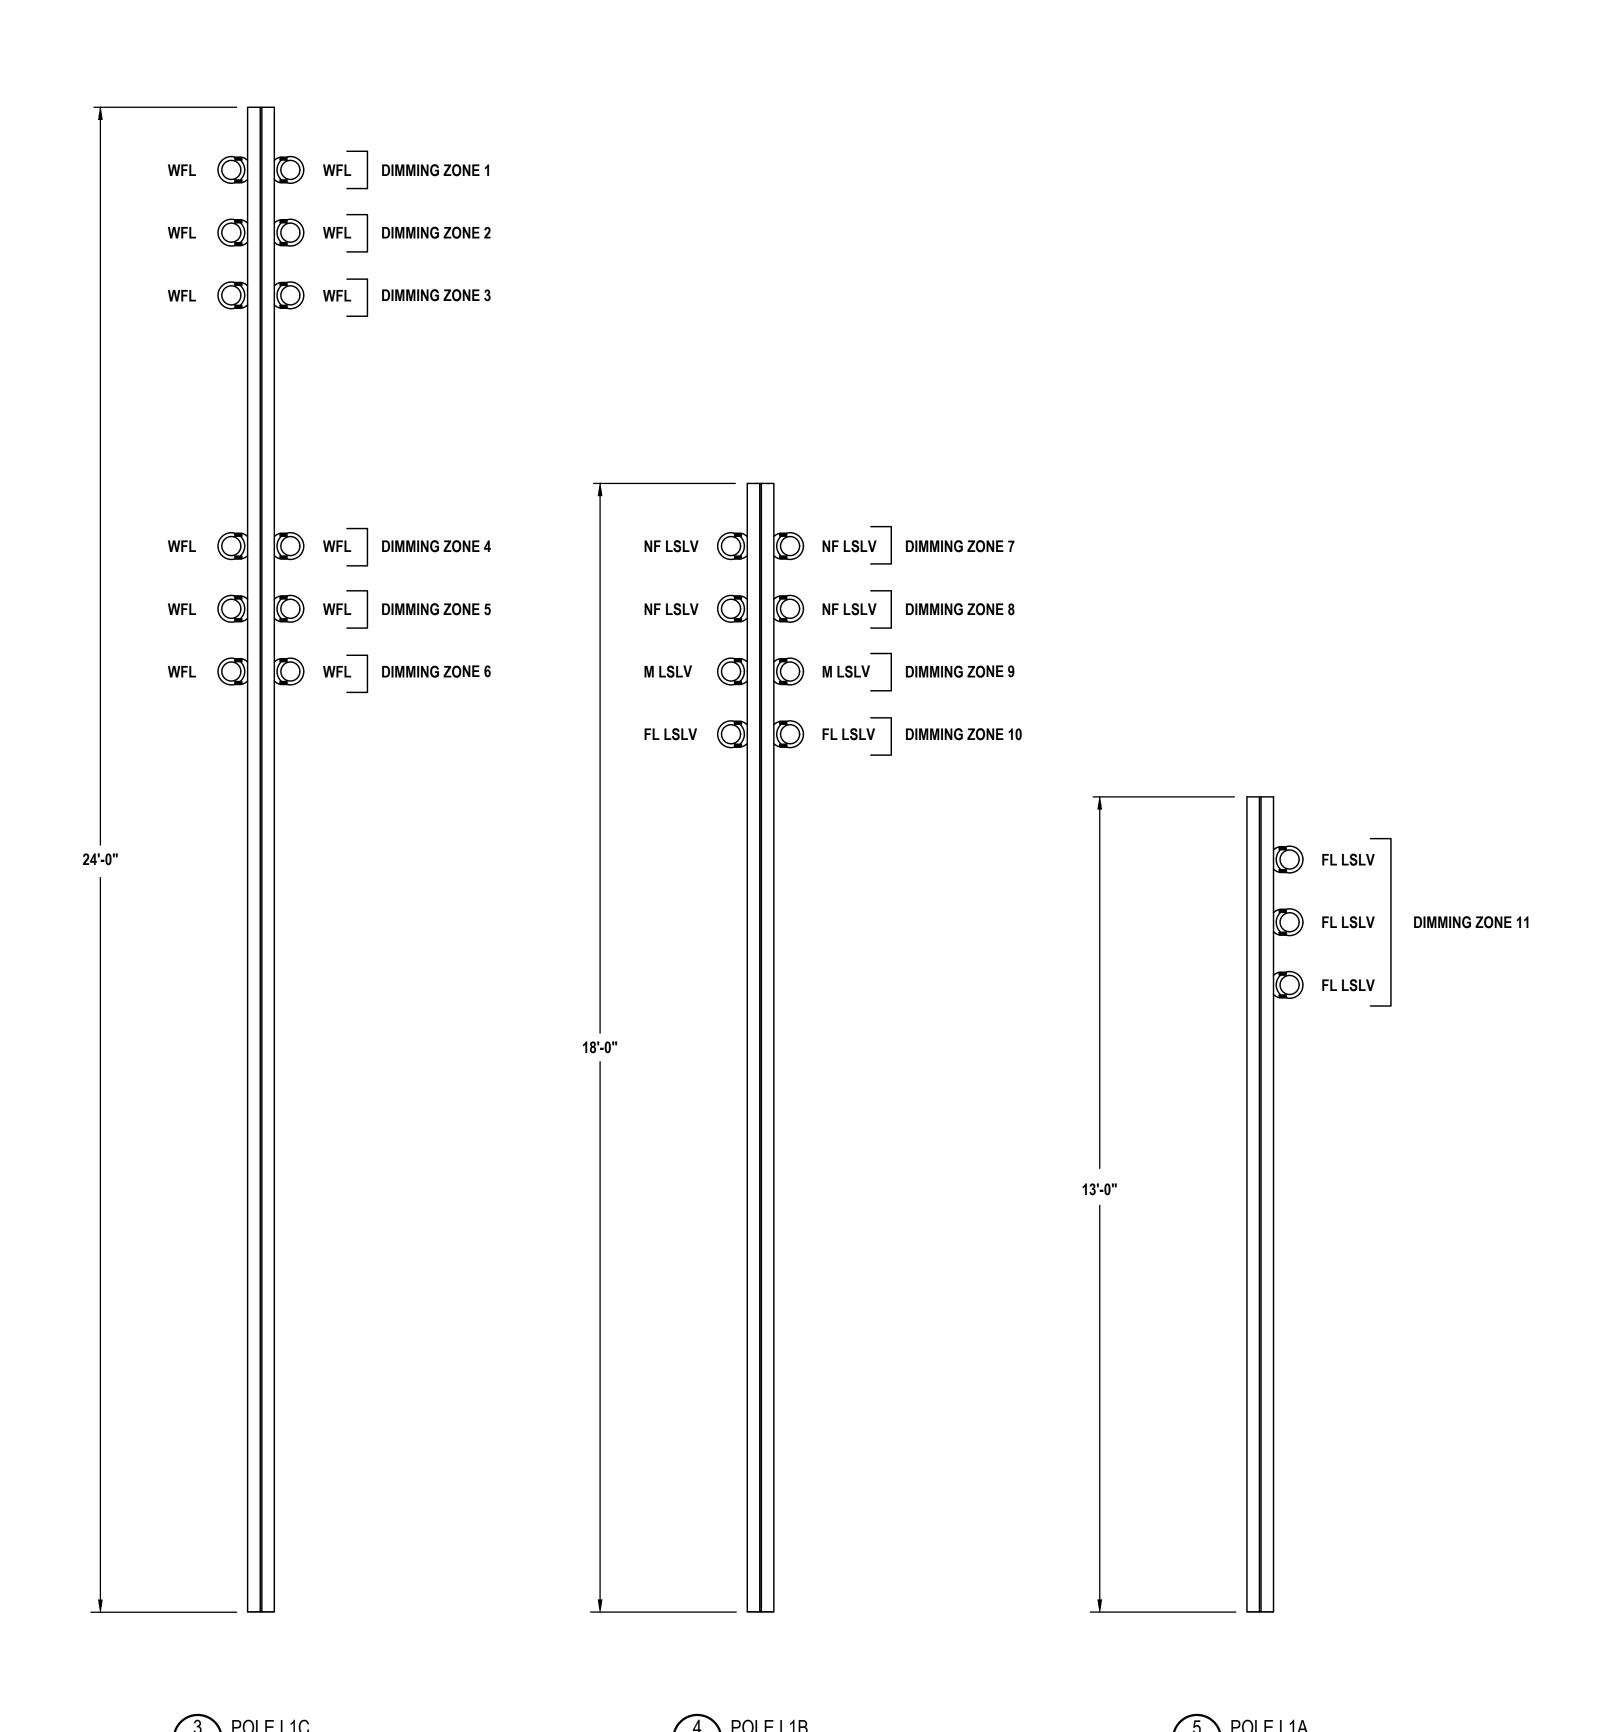
E202



1 BOLLARD LIGHT - SHIELDED DIRECT LIGHT

E201 SCALE: NTS







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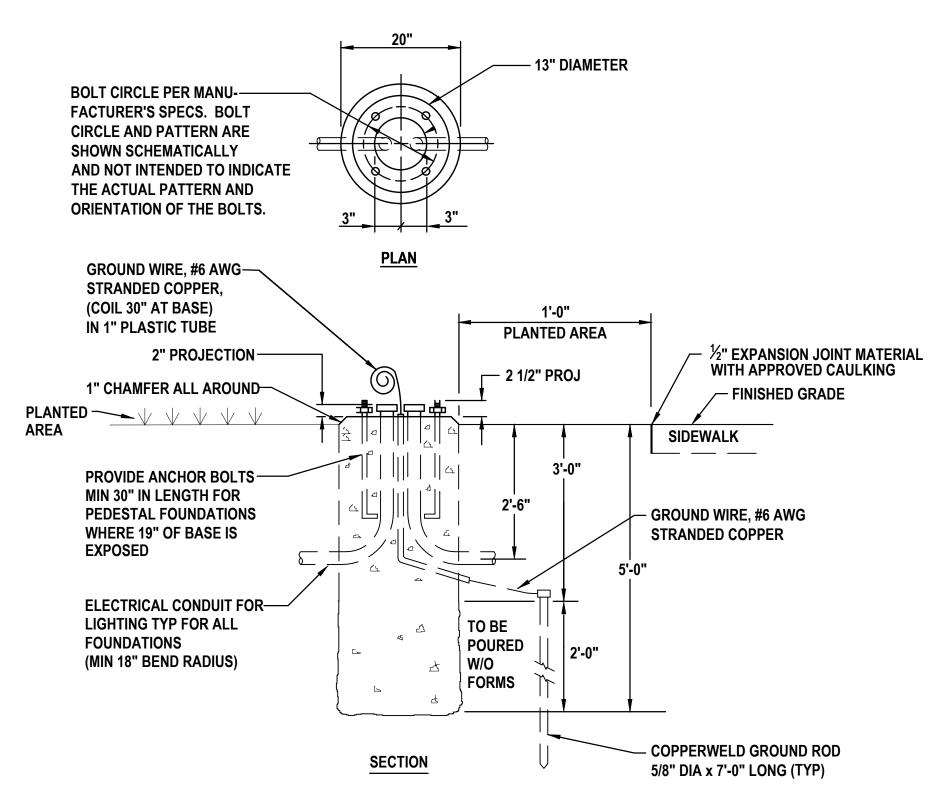
Electrical Details 1

Submission:

100% Construction Documents

Sheet Number:

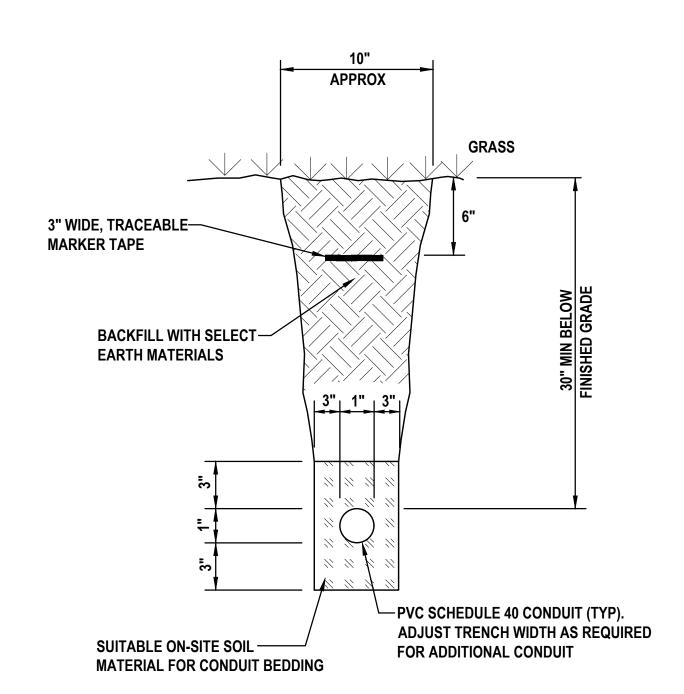
E300



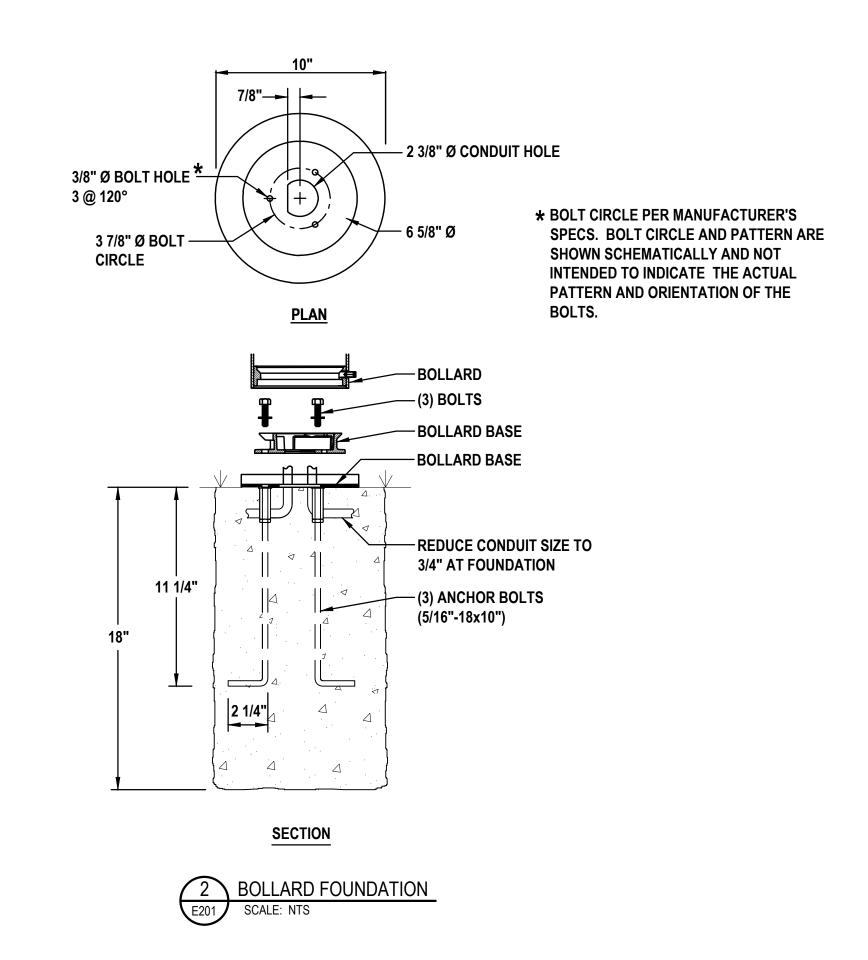
NOTE:

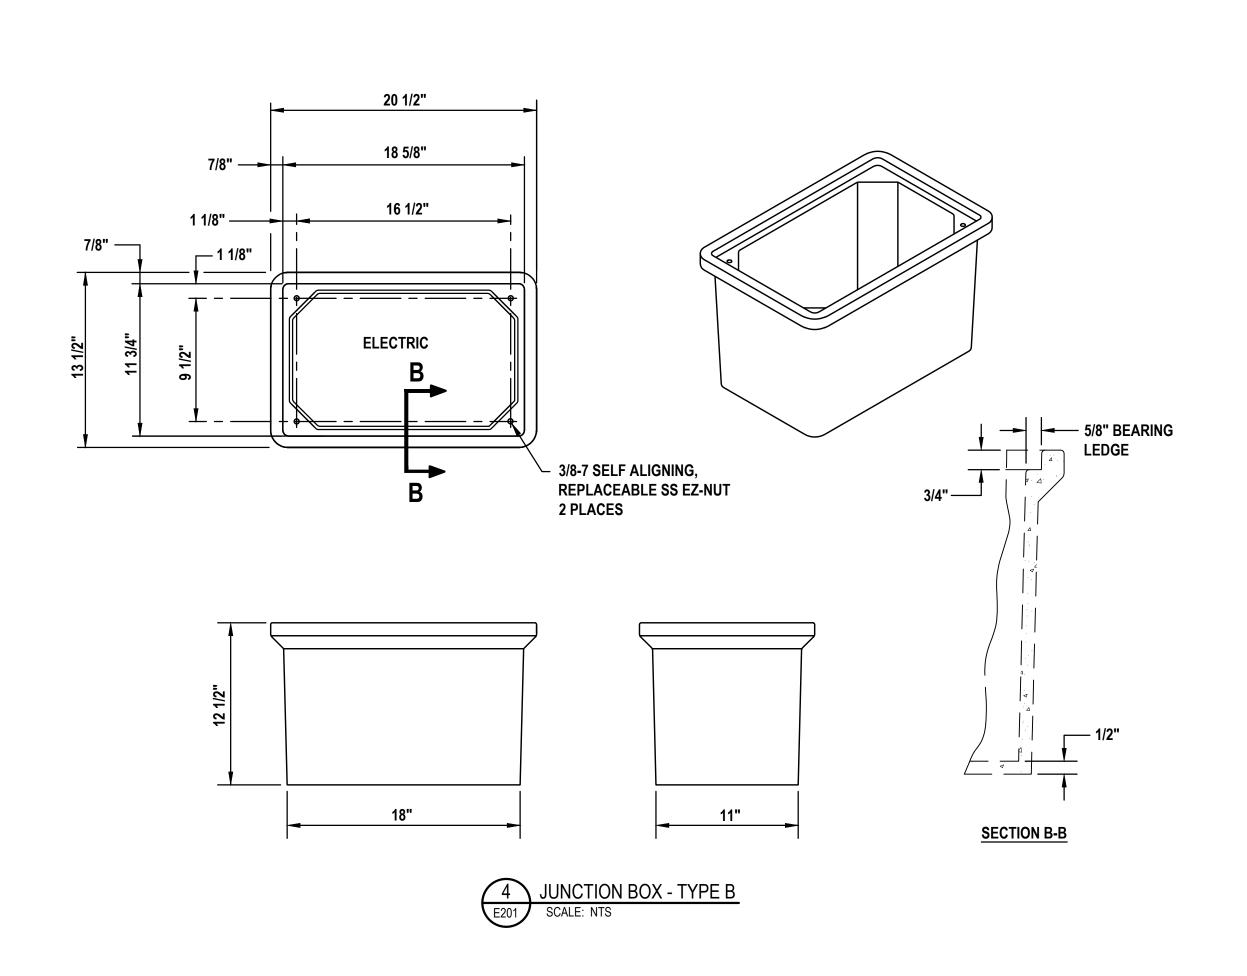
1. PAYMENT FOR POLE FOUNDATION INCLUDES EXCAVATION, REMOVAL AND DISPOSAL OF EXCESS EXCAVATED MATERIAL.













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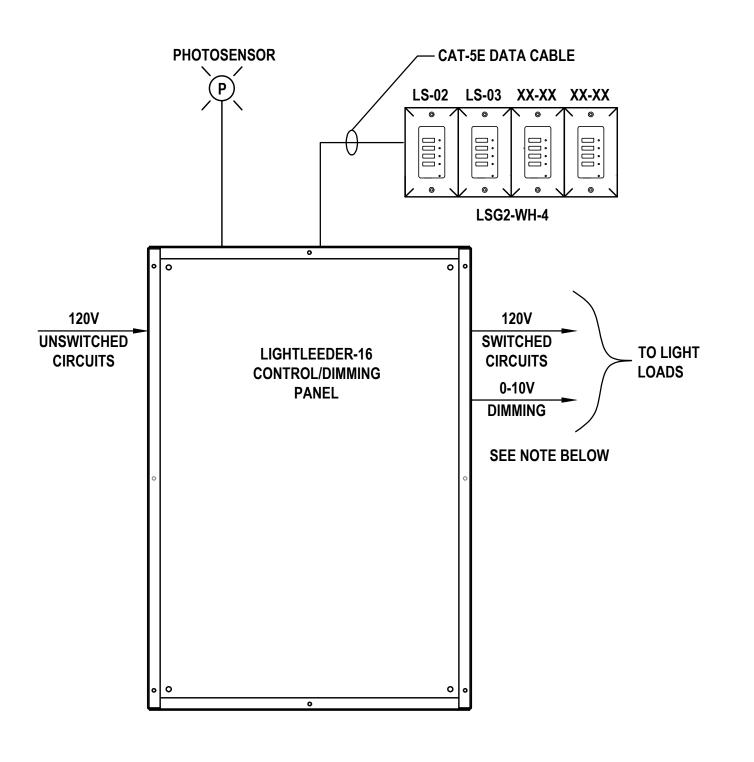
Electrical Details 2


Submission:

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Sheet Number:

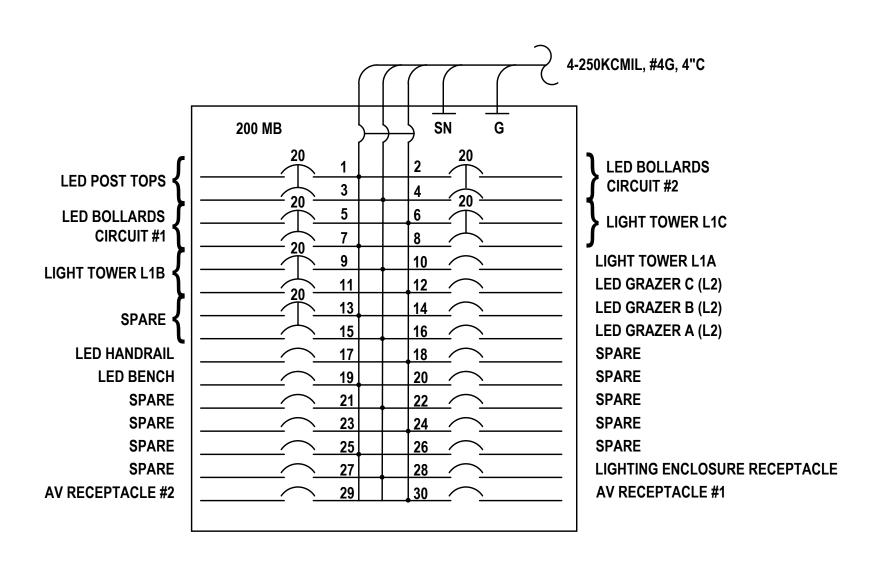
E301







2 "PANEL A" IN CONTROL CABINET #1

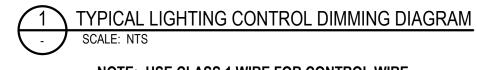120/208V, 3 Ø, 4 WIRE ALL BREAKERS 20A TRIP UNLESS NOTED



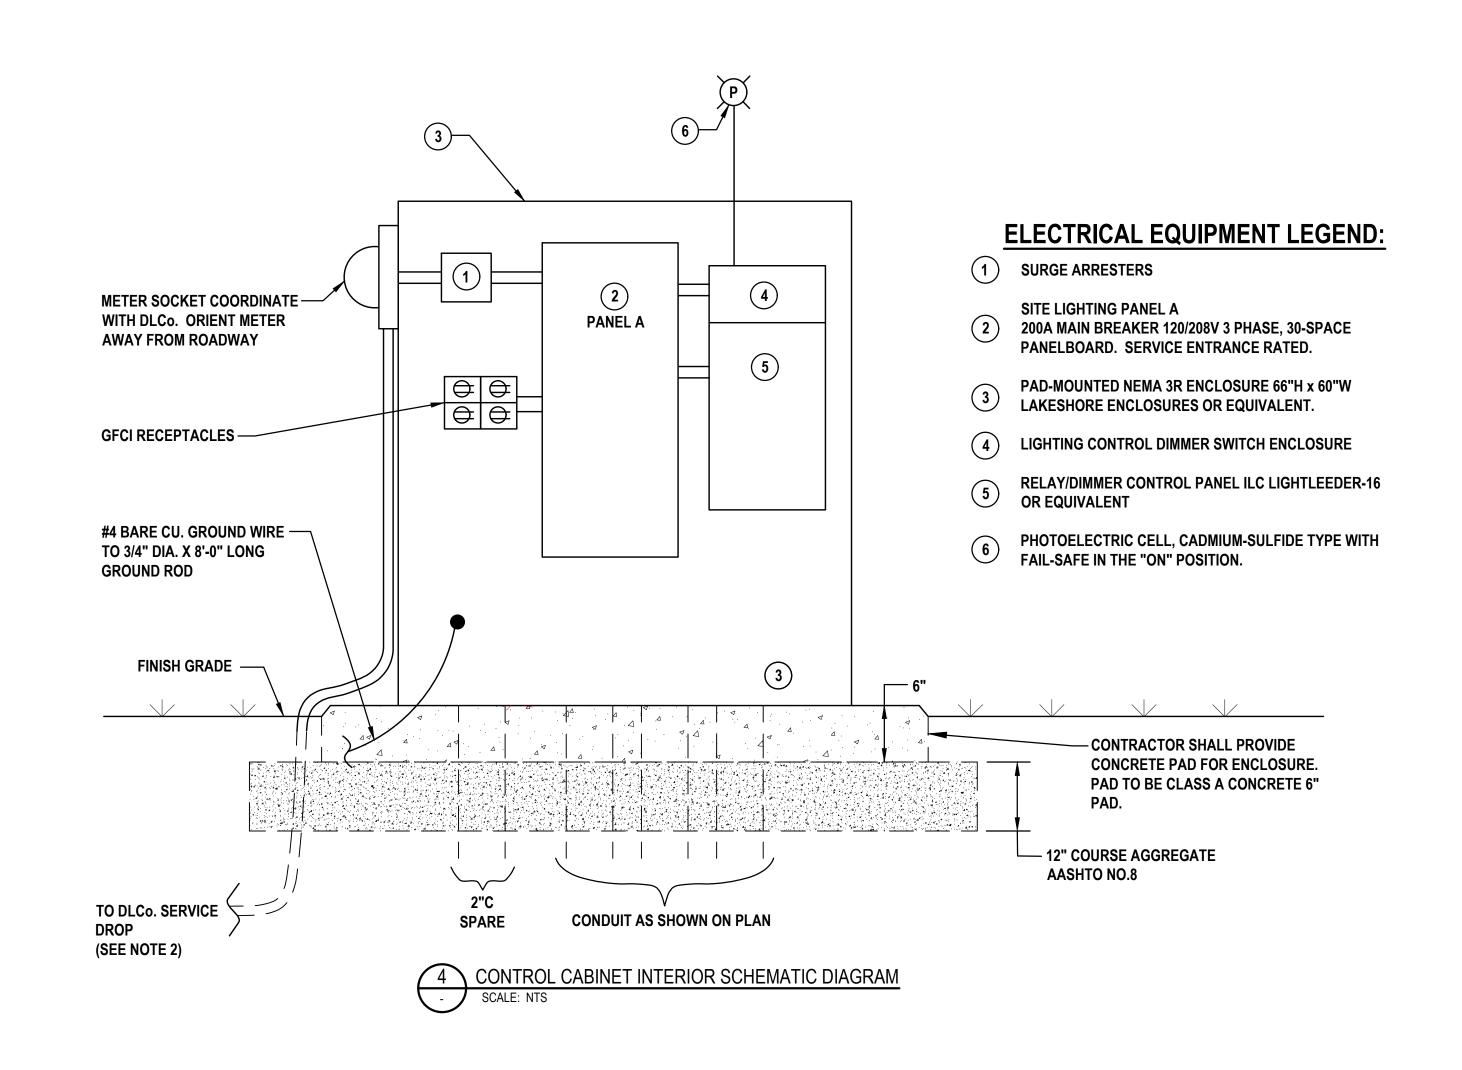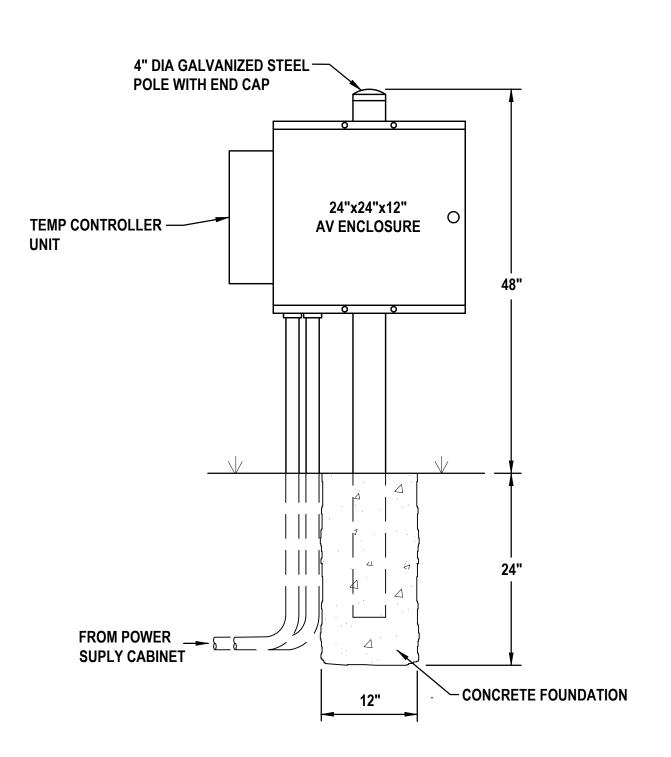NOTE: USE CLASS 1 WIRE FOR CONTROL WIRE.







PROVIDE MIER #BW-124ACHT WITH POLE MOUNTING KIT. REFERENCE AUDIO/VISUAL PLANS FOR MORE DETAILS

LIGHTING CONTROL CABINET NOTES:

- PROVIDE LAKESHORE ENCLOSURE OR EQUIVALENT.
- CONDUIT AND WIRE FROM SERVICE DROP ARE INCIDENTAL TO POWER SUPPLY.
- COORDINATE SERVICE WITH DUQUESNE LIGHT COMPANY.
- 4. REFERENCE PANELBOARD SCHEDULE FOR CIRCUIT QUANTITY AND DETAILS.



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Electrical Details 2

Submission:

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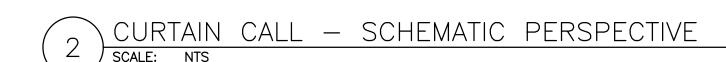
Sheet Number:

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SHEE	T LIST
LSK0.0	CURTAIN CALL - GENERAL NOTES + SCHEDULES
LSK1.1	CURTAIN CALL — OVERALL SITE PLAN
LSK1.2	CURTAIN CALL - LAYOUT PLAN
LSK1.3	CURTAIN CALL - AUDIO AND LIGHTING PLAN
LSK2.0	CURTAIN CALL - UNROLLED ELEVATIONS
LSK2.1	CURTAIN CALL AREA A - UNIT ELEVATION AND SECTION
LSK2.2	CURTAIN CALL AREA B — UNIT ELEVATION AND SECTION
LSK2.3	CURTAIN CALL AREA C - UNIT ELEVATION AND SECTION
LSK2.4	CURTAIN CALL - SITE SECTION
LSK6.1	CURTAIN CALL AREA A - FRAMING DETAILS
LSK6.2	CURTAIN CALL AREA A - FRAMING DETAILS
LSK6.3	CURTAIN CALL AREA B - FRAMING DETAILS
LSK6.4	CURTAIN CALL AREA B - FRAMING DETAILS
LSK6.5	CURTAIN CALL AREA C - FRAMING DETAILS
LSK6.6	CURTAIN CALL AREA C - FRAMING DETAILS
LSK7.1	CURTAIN CALL AREA A — ASSEMBLY AXONS
LSK7.2	CURTAIN CALL AREA B — ASSEMBLY AXONS
LSK7.3	CURTAIN CALL AREA C - ASSEMBLY AXONS
LSK7.4	CURTAIN CALL - GLASS DETAILS
LSK7.5	CURTAIN CALL - FASCIA DETAILS
LSK8.1	CURTAIN CALL - LIGHT TOWER
LSK8.2	CURTAIN CALL - FASCIA LIGHTING
LSK8.3	CURTAIN CALL - AUDIO SYSTEM ATTACHMENT
TA-001	CURTAIN CALL - AUDIOVISUAL SYMBOLS AND NOTES
TA-002	CURTAIN CALL - AUDIOVISUAL SCHEDULES
TA-101	CURTAIN CALL - AUDIOVISUAL FLOOR PLAN
TA-501	CURTAIN CALL - AUDIOVISUAL RISER DIAGRAM
TA-601	CURTAIN CALL — AUDIOVISUAL DETAILS
S100	CURTAIN CALL - STRUCTURE OVERVIEW
S101	CURTAIN CALL - STRUCTURE OVERVIEW
S200	CURTAIN CALL - STRUCTURE DETAILS

CURTAIN CALL public art installation









PROJECT LOCATION MAP

LOWER HILL - CURTAIN CALL LOCATION PLANS

CONTEXT MAP

E W	ALLS SCHE	<u>DULE</u>						
ΞΥ	SYMBOL	DESCRIPTION / LOCATION	MATERIAL / MODEL	COLOR / FINISH	QTY.	DETAIL NUMBER	SPEC. SECTION	COMMENTS
11)		GLASS CURTAIN WALL	9/16-INCH TEMPERED LAMINATED ARTWORK GLASS WITH AN SBG IMAGE INTERLAYER	-	SF	2/LSK7.4	-	MAX 4 SAMPLES TO BE PROVIDED BY FABRICATOR FOR REVIEW BY HDS AND OWNER.
3		WALL FRAMING	CUSTOM STRUCTURAL FRAME	PAINTED STEEL FRAME WITH ANTI-GRAFFITI COATING	LF	1,2,3/LSK6.1 1,2,3/LSK6.2 1,2,3/LSK6.3 1,2,3/LSK6.4 1,2,3/LSK6.5 1,2,3/LSK6.6		ONE IN PERSON MOCK-UP REVIEW BY HDS AND OWNER AT FABRICATOR'S FACILITY AT 50% SHOP DRAWING SUBMITTAL. MOCK-UP SHALL INCLUDE TWO CONNECTED CURTAIN CALL MODULE UNITS, FRAME, GLASS, HARDWARE AND FASCIA. IF NECESSARY, THERE WILL BE ONE MOCK-UP REVIEW BY HDS AND OWNER PM AT FABRICATOR'S FACILITY AT 100% SHOP DRAWING SUBMITTAL.
23	•	WALL POST	CUSTOM STRUCTURAL POST	PAINTED STEEL POST WITH ANTI-GRAFFITI COATING	26	SEE PLAN		POST SHALL BE CUT TO LENGTH ON SITE AND THE BASE PLATE WELDED ON SITE. ONE IN PERSON MOCK-UP REVIEW BY HDS AND OWNER AT FABRICATOR'S FACILITY AT 50% SHOP DRAWING SUBMITTAL. MOCK-UP SHALL INCLUDE TWO CONNECTED CURTAIN CALL MODULE UNITS, FRAME, GLASS, HARDWARE AND FASCIA. IF NECESSARY, THERE WILL BE ONE MOCK-UP REVIEW BY HDS AND OWNER PM AT FABRICATOR'S FACILITY AT 100% SHOP DRAWING SUBMITTAL.
010	AND VISUAL	_ SCHEDULE						
Y	SYMBOL	DESCRIPTION / LOCATION	MATERIAL / MODEL	COLOR / FINISH	QTY.	DETAIL NUMBER	SPEC. SECTION	COMMENTS
A	•	MULTI-HEAD LIGHT POLE IN RAINGARDEN AREA A	LUMENPULSE LBM LED FLOODLIGHTS MOUNTED ON LMT SMARTPOLE PL-T; SEE MANUFACTURER SKETCH	WHITE	1/3 FIXTURES	LSK8.1		LIGHTING DESIGNER SHALL PROVIDE ONE LIGHTING MOCK—UP TO INCLUDE A SELECTION OF SAMPLE FIXTURES TO SUPPORT THE DESIGN CONCEPTS FOR INTEGRATION INTO FABRICATOR'S MOCK—UP AT 50% AND 100% SHOP DRAWINGS ELECTRICAL CONTRACTOR TO PROVIDE ON—SITE AIMING MOCK—UP.
В	•	MULTI-HEAD LIGHT POLE IN RAINGARDEN AREA B	LUMENPULSE LBM LED FLOODLIGHTS MOUNTED ON LMT SMARTPOLE PL-T; SEE MANUFACTURER SKETCH	WHITE	1/8 FIXTURES	LSK8.1		LIGHTING DESIGNER SHALL PROVIDE ONE LIGHTING MOCK-UP TO INCLUDE A SELECTION OF SAMPLE FIXTURES TO SUPPORT THE DESIGN CONCEPTS FOR INTEGRATION INTO FABRICATOR'S MOCK-UP AT 50% AND 100% SHOP DRAWINGS ELECTRICAL CONTRACTOR TO PROVIDE ON-SITE AIMING MOCK-UP.
С	•	MULTI-HEAD LIGHT POLE IN RAINGARDEN AREA C	LUMENPULSE LBM LED FLOODLIGHTS MOUNTED ON LMT SMARTPOLE PL-T; SEE MANUFACTURER SKETCH	WHITE	1/ 12 FIXTURES	LSK8.1		LIGHTING DESIGNER SHALL PROVIDE ONE LIGHTING MOCK-UP TO INCLUDE A SELECTION OF SAMPLE FIXTURES TO SUPPORT THE DESIGN CONCEPTS FOR INTEGRATION INTO FABRICATOR'S MOCK-UP AT 50% AND 100% SHOP DRAWINGS ELECTRICAL CONTRACTOR TO PROVIDE ON-SITE AIMING MOCK-UP.
2		LINEAR DOWNLIGHTING AT ARTWORK FASCIA	ECOSENSE TROV L50-E-48-06-27-90-MULT-ASY M	STANDARD	44	1/LSK8.2		LIGHTING DESIGNER SHALL PROVIDE ONE LIGHTING MOCK-UP TO INCLUDE A SELECTION OF SAMPLE FIXTURES TO SUPPORT THE DESIGN CONCEPTS FOR INTEGRATION INTO FABRICATOR'S MOCK-UP AT 50% AND 100% SHOP DRAWINGS VERIFY FIXTURE LENGTH PRIOR TO ORDERING. ELECTRICAL CONTRACTOR TO PROVIDE ON-SITE AIMING MOCK-UP.
.1		CUSTOM AUDIO SPEAKER CLUSTER MOUNTED ON CURTAIN CALL FRAME	LEON/TERRA TR50-MTM 70V, SEE MANUFACTURER SKETCH	WHITE	4	1/LSK8.3		ONE MOCK-UP TO TEST FEASIBILITY OF SPEAKER PROTOTYPES, AMPLIFIERS, AND PLAYBACK SYSTEM TO ILLUSTRATE THE DESIGN CONCEPTS IN A EXTERIOR TEMPORARY AUDIO ENVIRONMENT REPRESENTATIVE OF FINAL INSTALLATION.
					1	1		



NOTES

- 1. CONTRACTOR AND INSTALLER IS RESPONSIBLE FOR PROVIDING COMPLETE, OPERATIONAL SYSTEMS AND INSTALLATIONS. ALL MATERIALS SHALL BE FURNISHED AND INSTALLED BY THE CONTRACTOR AND INSTALLER UNLESS OTHERWISE NOTED.
- 2. ALL DIMENSIONAL NOTES AND DETAILS SHOWING A PORTION OF A DRAWING SHALL APPLY TYPICALLY TO ALL OPPOSITE HAND AND/OR SIMILAR CONDITIONS, UNLESS OTHERWISE NOTED.
- 3. THE CONTRACTOR AND INSTALLER IS RESPONSIBLE TO FIELD INVESTIGATE, AND VERIFY ALL CONDITIONS, ELEVATIONS AND DIMENSIONS OF THE PROJECT, AS SHOWN ON OR REFERENCED ON THE DRAWINGS. IF THERE ARE ANY DISCREPANCIES BETWEEN DIMENSIONS OR GRADES IN DRAWINGS AND EXISTING CONDITIONS WHICH WILL AFFECT THE WORK, THE CONTRACTOR SHALL BRING SUCH DISCREPANCIES TO THE ATTENTION OF THE OWNER FOR ADJUSTMENT BEFORE PROCEEDING WITH THE WORK. THE CONTRACTOR SHALL BE RESPONSIBLE FOR THE PROPER FITTING OF ALL WORK AND FOR THE COORDINATION OF ALL TRADES AND SUBCONTRACTORS.
- 4. REFER TO SURVEY PROVIDED BY COSMOS TECHNOLOGIES (SURVEYOR) DATED 04.18.2022 FOR ALL NOTES AND INFORMATION RELATED TO EXISTING AND PROPOSED UTILITIES PRIOR TO ANY SITE DEMOLITION OR CLEARING OR ASSOCIATED WITH ANY SITE GRADING OR TRENCHING OPERATIONS.
- 5. VERIFY ABOVE AND BELOW GROUND UTILITY LOCATIONS AND COORDINATE INSTALLATION OF ART SCULPTURE COMPONENTS.
- 6. CONTRACTOR SHALL MAINTAIN A QUALIFIED ENGLISH SPEAKING SUPERVISOR ON THE SITE AT ALL TIMES; DURING CONSTRUCTION THROUGH COMPLETION OF PUNCH LIST ITEMS.

CODES AND REGULATIONS

CONSTRUCTION SHALL CONFORM TO ALL APPLICABLE CODES AND REGULATIONS INCLUDING BUT NOT LIMITED TO:

- 2018 UNIFORM CONSTRUCTION CODE, AS AMMENDED
- CITY OF PITTSBURGH MUNICIPAL CODE AMERICANS WITH DISABILITIES ACT
- ALL CONSTRUCTION ACTIVITIES SHALL BE PERFORMED IN SUCH A MANNER AS TO COMPLY WITH THE STANDARDS ESTABLISHED BY THE AIR QUALITY MAINTENANCE DISTRICT FOR AIRBORNE PARTICULATE (DUST).

SITE LAYOUT AND GRADING NOTES

1. REFER TO CIVIL AND SITE UTILITY DRAWINGS TO BE PROVIDED BY COSMOS SURVEY DATED 04.18.2022 FOR INFORMATION RELATED TO SITE PREPARATION AND UTILITIES PRIOR TO ANY SITE INSTALLATION OR CONSTRUCTION.

2. THE CONTRACTOR IS RESPONSIBLE FOR MATCHING EXISTING STREETS, SURROUNDING LANDSCAPE AND OTHER IMPROVEMENTS WITH A SMOOTH TRANSITION IN PAVING, CURBS, GUTTERS, SIDEWALKS, LANDSCAPE, GRADING, ETC. AS APPLICABLE, AND TO AVOID ANY ABRUPT OR APPARENT CHANGES IN GRADES OR CROSS SLOPES, LOW SPOTS OR HAZARDOUS CONDITIONS.

DEFERRED SUBMITTALS

ALL ITEMS DESIGNATED IN THESE DOCUMENTS AS DEFERRED SUBMITTAL, OR AS ELEMENTS DESIGNATED TO BE FINALIZED DURING THE SHOP DRAWING AND/OR FABRICATION PHASE OF WORK SHALL BE CONSIDERED DEFERRED SUBMITTAL AND SHALL MEET THE REQUIREMENTS STATED BELOW.

ARTIST, INCLUDING THEIR FABRICATORS, SUBCONTRACTORS AND/OR CONSULTANTS, SHALL BE RESPONSIBLE FOR PROVIDING ALL REQUIREMENTS OF THE DEFERRED SUBMITTAL PROCESS, INCLUDING BUT NOT LIMITED TO, SUBMITTING SHOP DRAWINGS AND RELATED DOCUMENTS FOR REVIEW TO THE OWNER AND LAOR PRIOR TO SUBMITTING TO THE AUTHORITY HAVING JURISDICTION (AHJ) IN ACCORDANCE WITH ALL APPLICABLE CODES AND REGULATIONS.

ITEMS INCLUDED AS DEFERRED SUBMITTALS INCLUDE, BUT ARE NOT LIMITED TO:

- CURTAIN CALL FRAME SHOP DRAWINGS
- GLASS SHOP DRAWINGS
- REQUIRED HARDWARE BASE PLATE MOUNTING DETAILS
- FABRICATION SAMPLES
- AUDIOVISUAL SYSTEMS DRAWINGS
- AUDIOVISUAL SYSTEMS SPECIFICATIONS



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Lower Hill-Curtain Call Pittsburgh, PA

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CURTAIN CALL -GENERAL NOTES AND SCHEDULES Submission:

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Sheet Number:

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WYLIE AVENUE ARTWORK LIMIT OF WORK —CURTAIN CALL SCULPTURE • • • • • • . . . PATHWAY AND STEPS, BY OTHERS. REFER TO LANDSCAPE ARCHITECT'S DRAWINGS

NOTES:

- REFER TO CIVIL FOR ALL EXISTING CONDITIONS CONSIDERATIONS.
- 2. REFER TO CIVIL DRAWINGS FOR GRADING INFORMATION.
- 3. REFER TO LANDSCAPE DRAWINGS FOR PATH &STEPS LAYOUT AND DIMENSIONS.



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Revisions:

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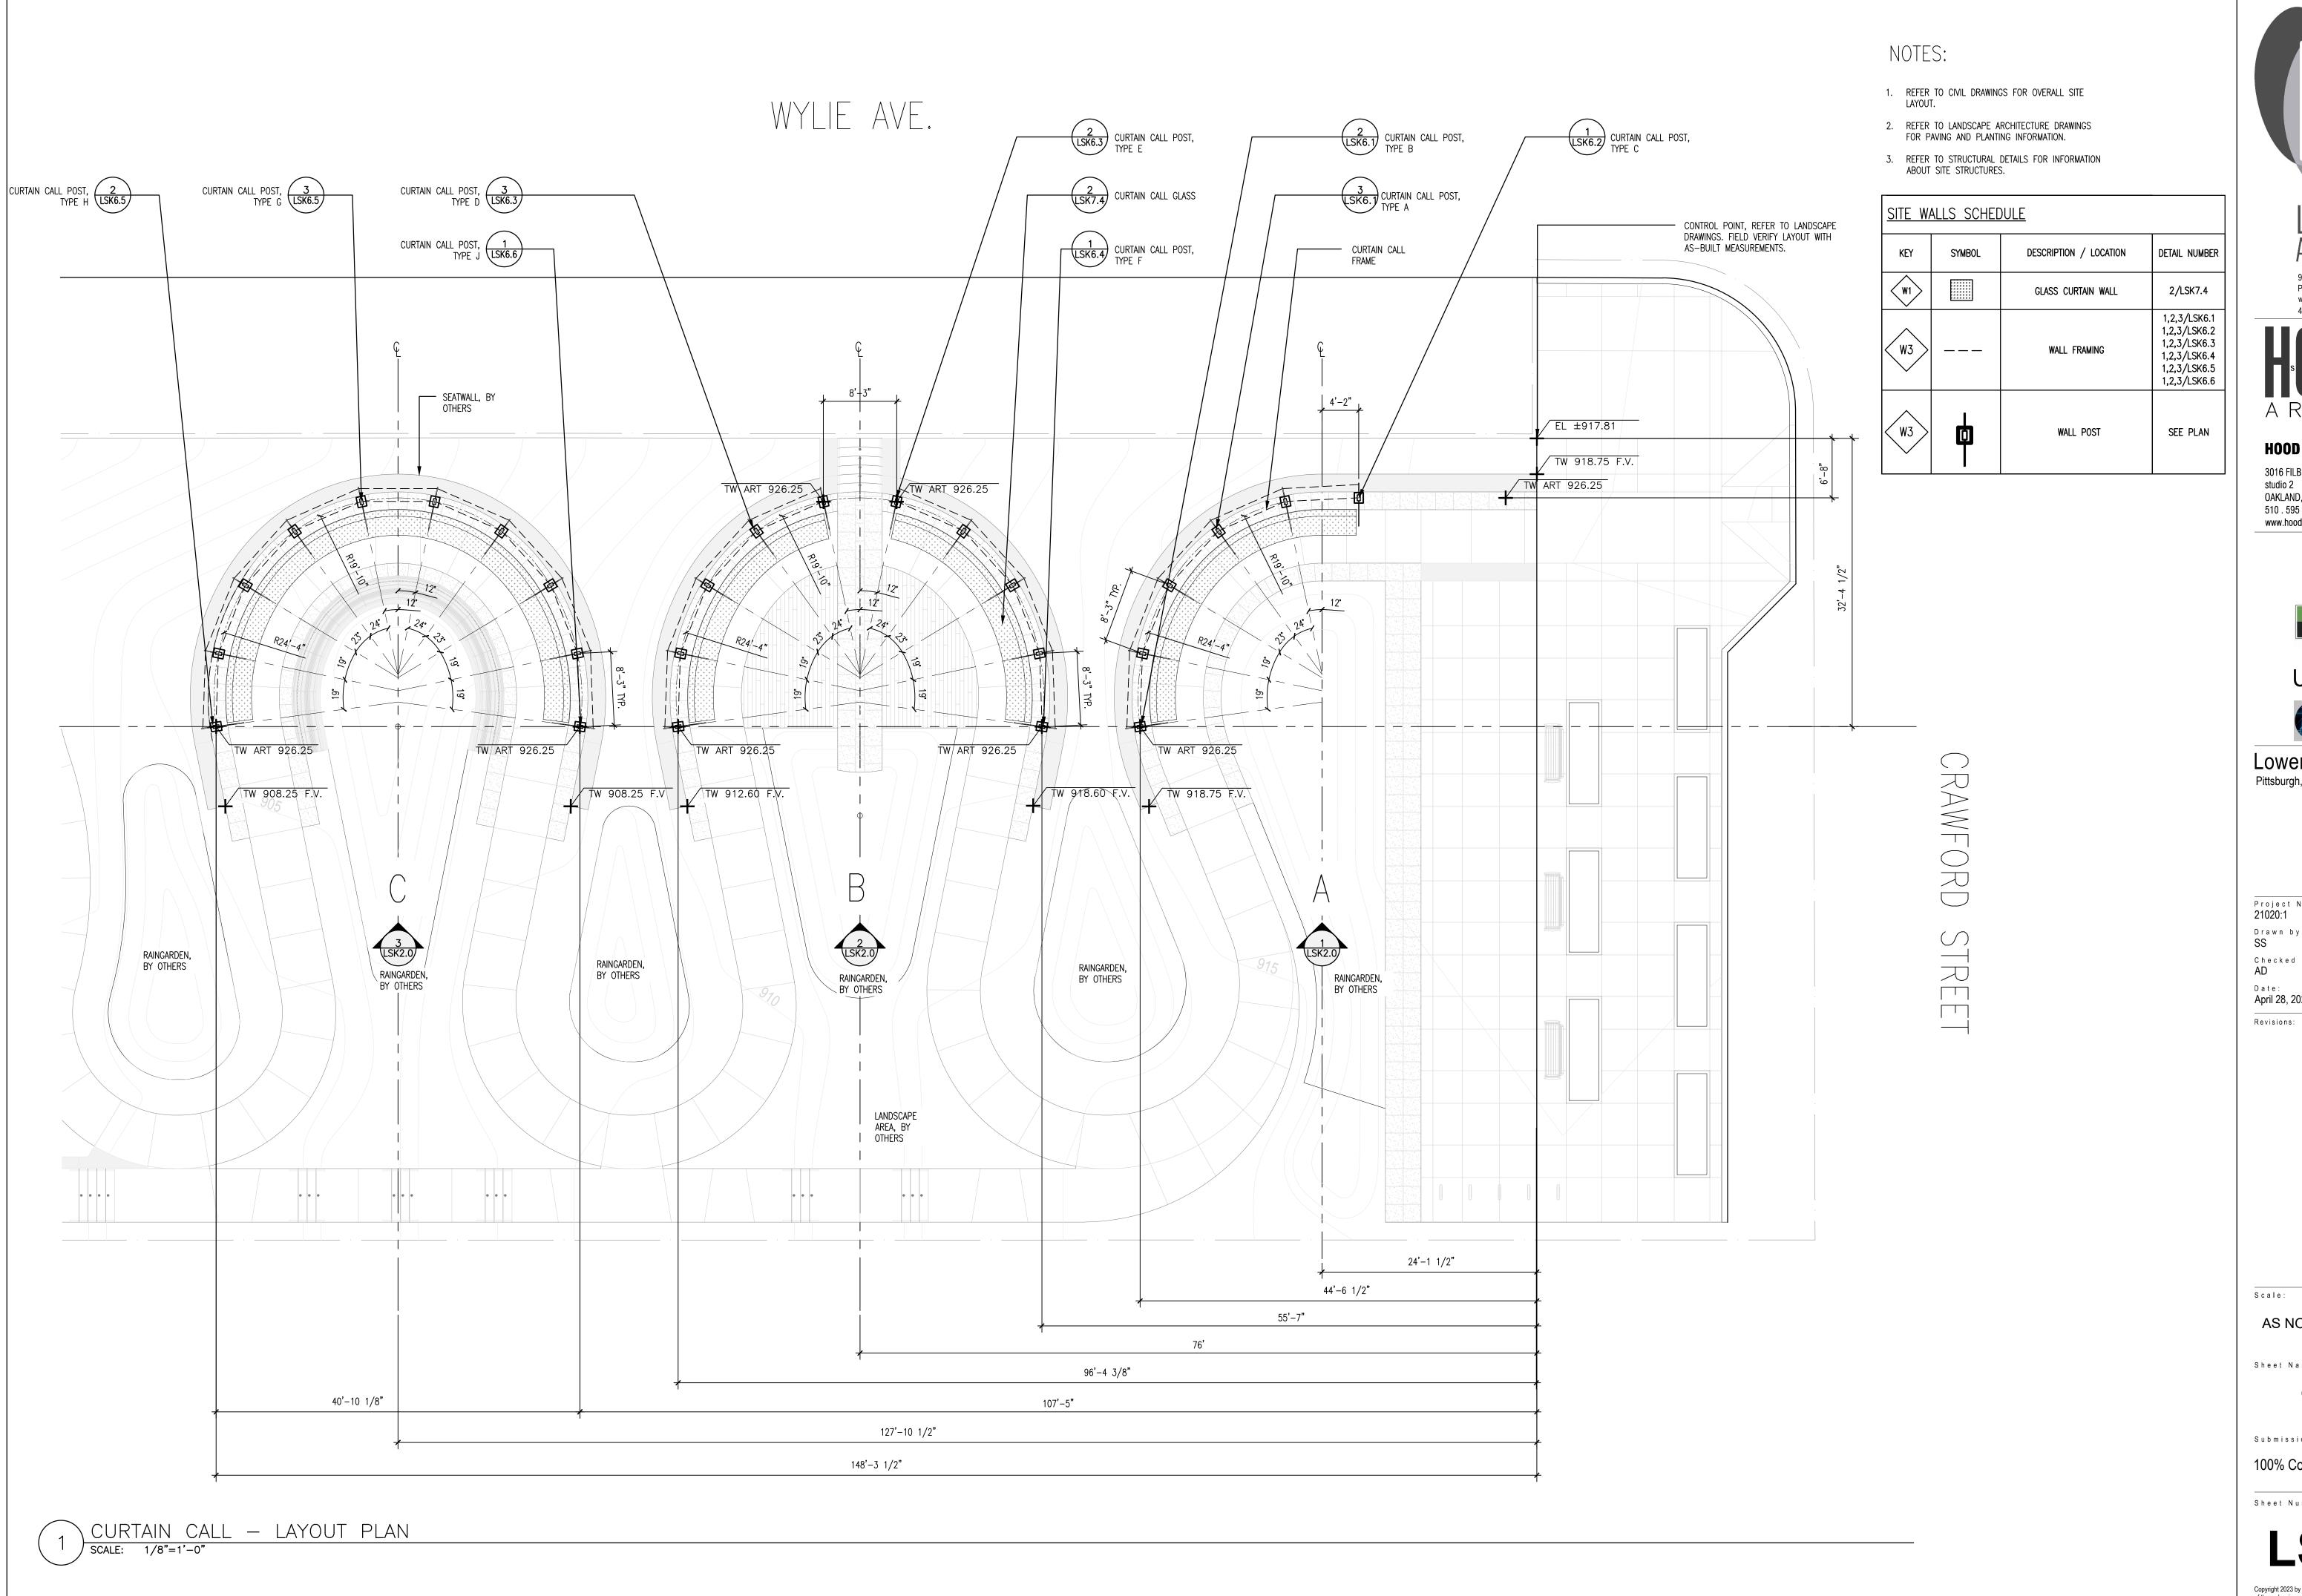
CURTAIN CALL -OVERALL SITE PLAN

Submission:

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Sheet Number:

LSK1.1





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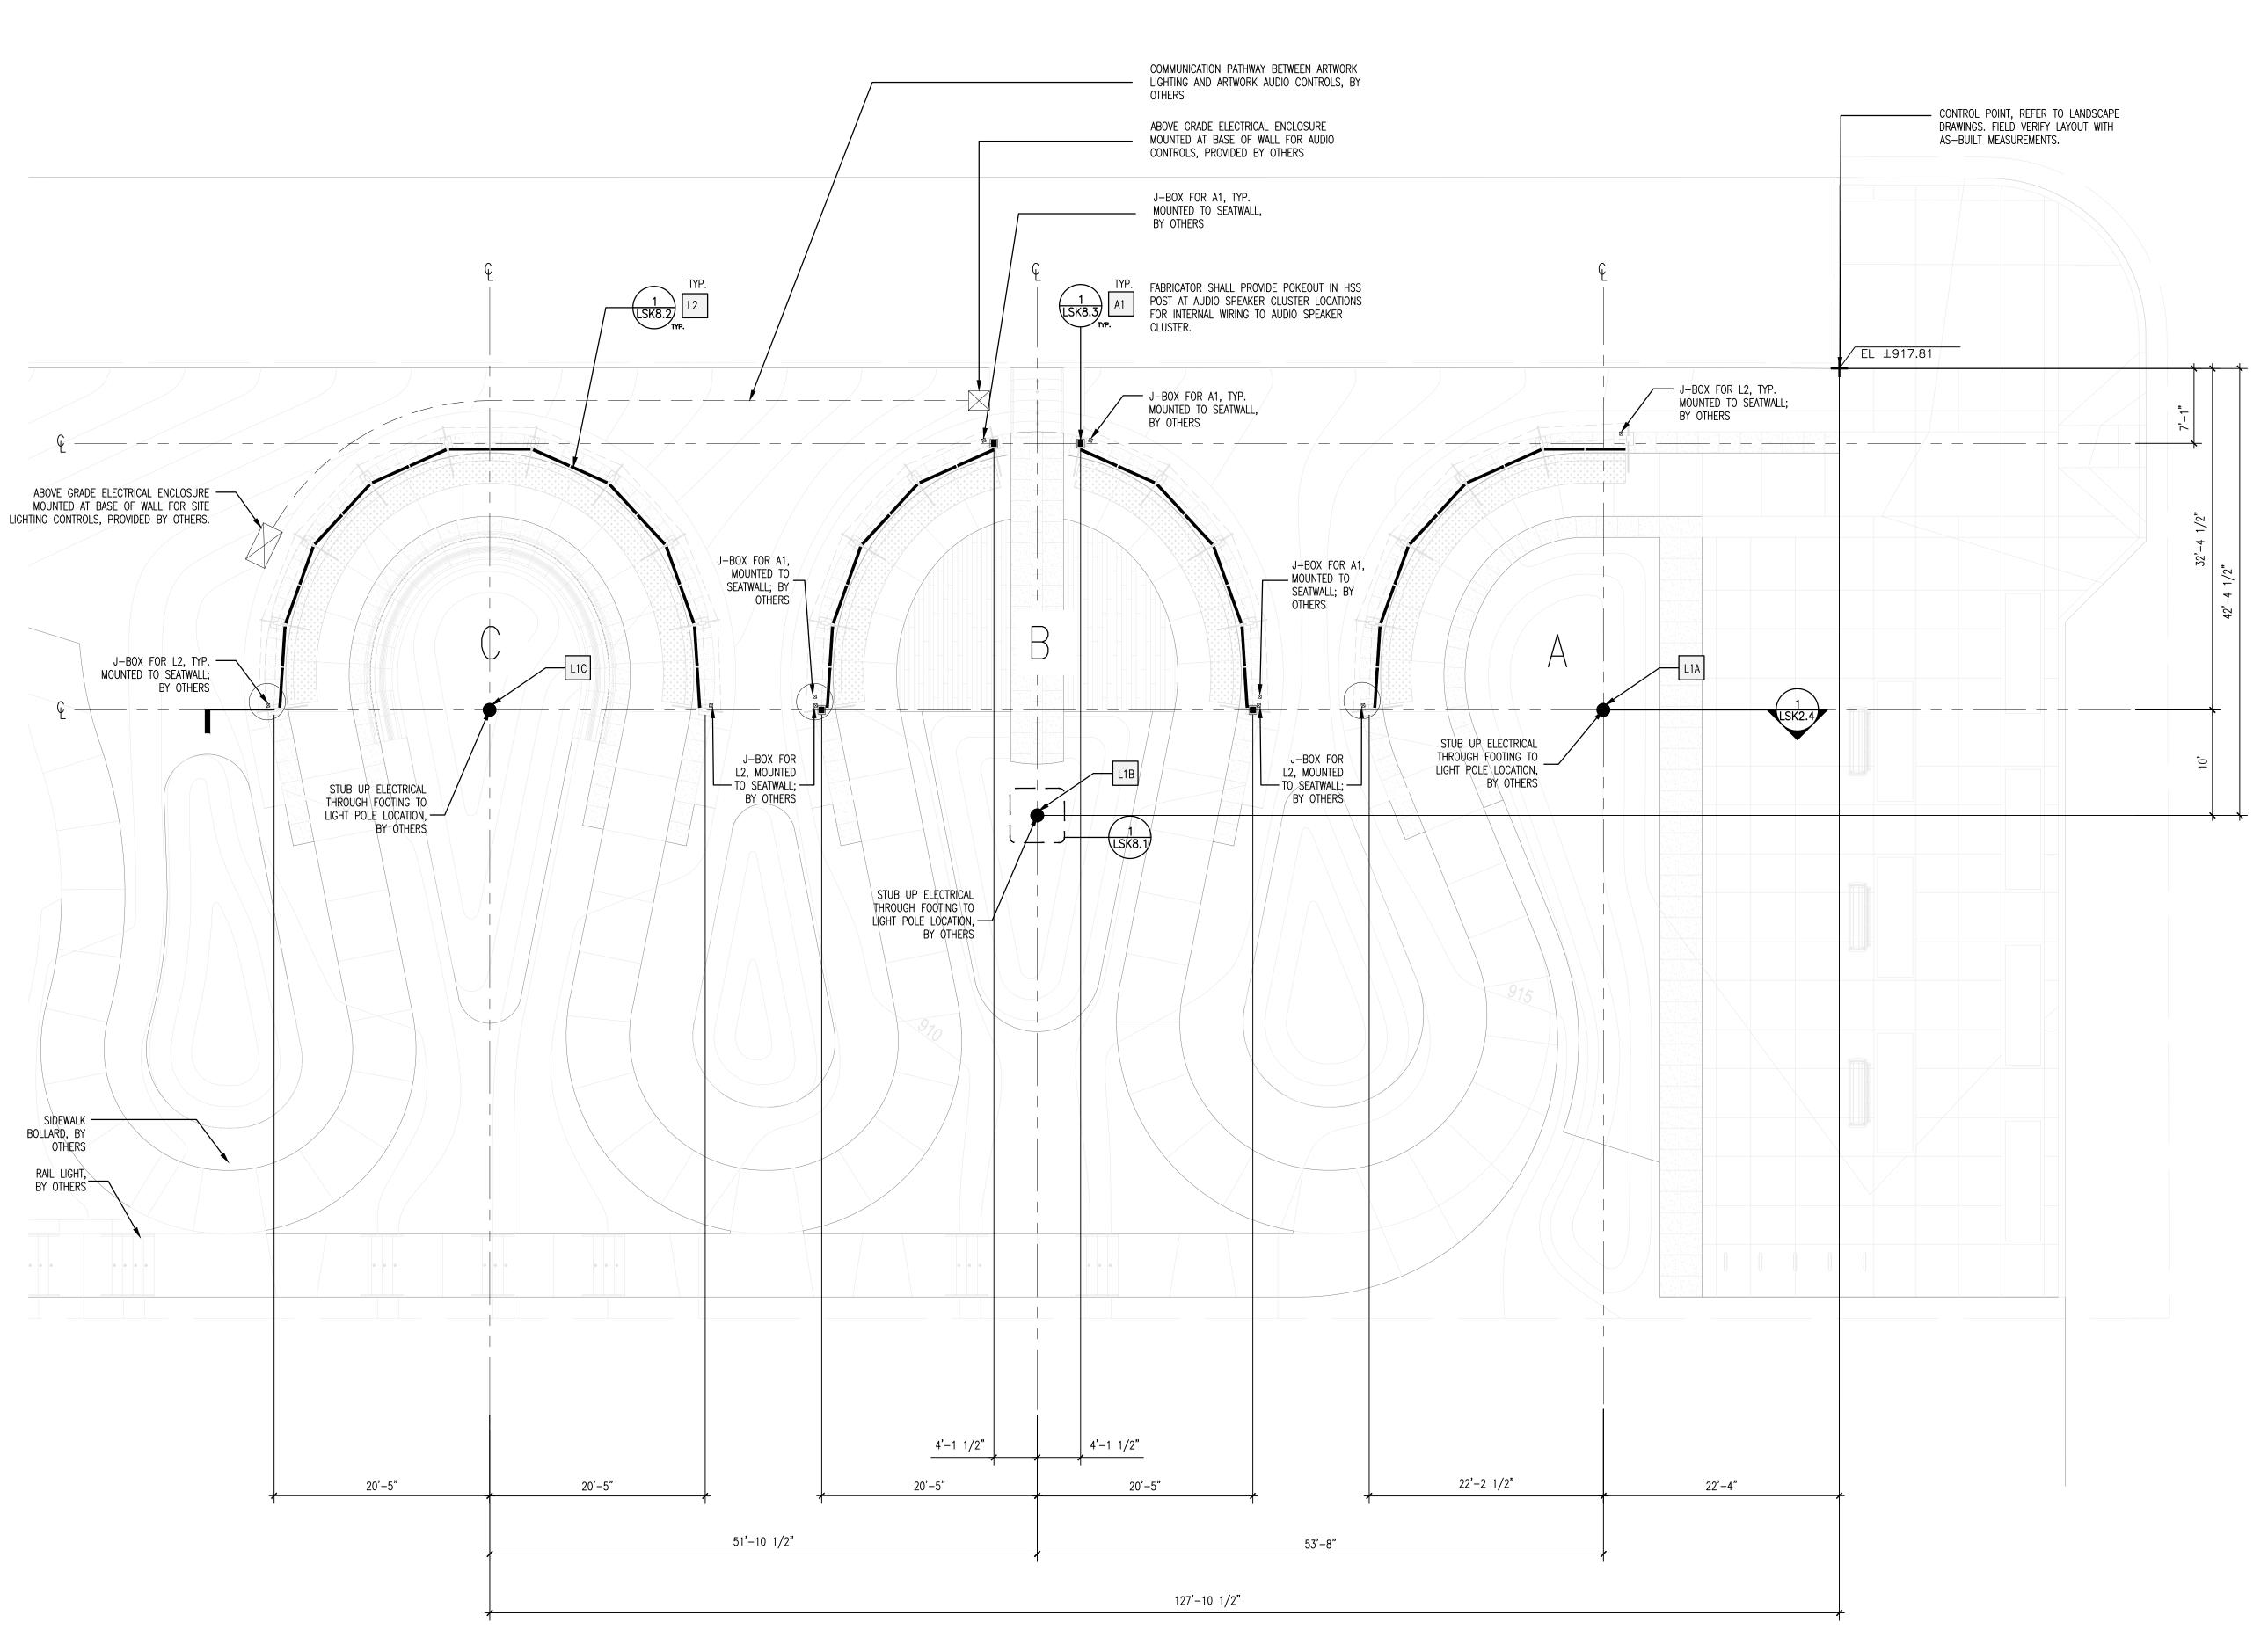
CURTAIN CALL LAYOUT PLAN

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- 1. LIGHTING PLAN SHOWS CONCEPTUAL REFERENCE ONLY. REFER TO LANDSCAPE ARCHITECT'S ELECTRICAL DRAWINGS.
- 2. ELECTRICAL CONTRACTOR SHALL CONNECT NEW ARTWORK LIGHTING TO EXISTING SITE POWER.
- 3. REFER TO CIVIL DRAWINGS FOR OVERALL SITE LAYOUT.
- 4. REFER TO LANDSCAPE ARCHITECTURE DRAWINGS FOR PAVING AND PLANTING INFORMATION.
- 5. REFER TO STRUCTURAL DETAILS FOR INFORMATION ABOUT SITE STRUCTURES.
- 6. FABRICATOR SHALL PROVIDE POKEOUT IN POST HSS BASE ON WHICH A1 SPEAKER CLUSTERS ARE MOUNTED.
- 7. FABRICATOR SHALL PROVIDE POKEOUT IN FASCIA AT L2 J-BOX LOCATIONS TO L2 FIXTURE.
- 8. ELECTRICAL CONTRACTOR SHALL PROVIDE L2 DOWNLIGHTING AT EACH CURTAIN AREA IN TWO EQUAL RUNS STARTING FROM THE J-BOX LOCATIONS. EACH RUN SHALL BE CONTROLLED SEPARATELY SO THE FASCIA CAN BE EVENLY ILLUMINATED OVER ITS VARIABLE HEIGHT.
- 9. AUDIO SYSTEM DRAWINGS AND SPECIFICATIONS SHALL BE PROVIDED AS A DEFERRED SUBMITTAL.
- 10. A/V CONTRACTOR SHALL REFER TO AUDIO SYSTEM DRAWINGS AND SPECIFICATIONS TO PROCURE AND INSTALL AUDIO ELECTRONIC COMPONENTS, TERMINATE CABLING, CONFIGURE, TEST, AND COMMISSION THE AUDIO SYSTEM.

AUDIO AND VISUAL SCHEDULE								
KEY	SYMBOL	DESCRIPTION / LOCATION						
L1A	•	MULTI-HEAD LIGHT POLE IN RAINGARDEN AREA A						
L1B	•	MULTI-HEAD LIGHT POLE IN RAINGARDEN AREA B						
L1C	•	MULTI-HEAD LIGHT POLE IN RAINGARDEN AREA C						
L2		LINEAR DOWNLIGHTING AT ARTWORK FASCIA						
A1		CUSTOM AUDIO SPEAKER CLUSTE MOUNTED ON CURTAIN CALL FRAME						

KEY	QTY.	DETAIL NUMBER	SPEC. SECTION		
L1A	1/3 FIXTURES	LSK8.1			
L1B	1/ 8 FIXTURES	LSK8.1			
L1C	1/ 12 FIXTURES	LSK8.1			
L2	44	1/LSK8.2			
A1	4	1/LSK8.3			



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SANTANGELO

LINDSAY

ELECTRICAL ENGINEERS

UPSTUDIO -

or Hill-Curtain Ca

Pittsburgh, PA

Project Number:

Drawn by: **SS**

21020:1

Checked by:

April 28, 2023

Scale:

Sheet Name:


CURTAIN CALL -AUDIO AND LIGHTING PLAN

Submission:

100% Construction Documents

Sheet Number:

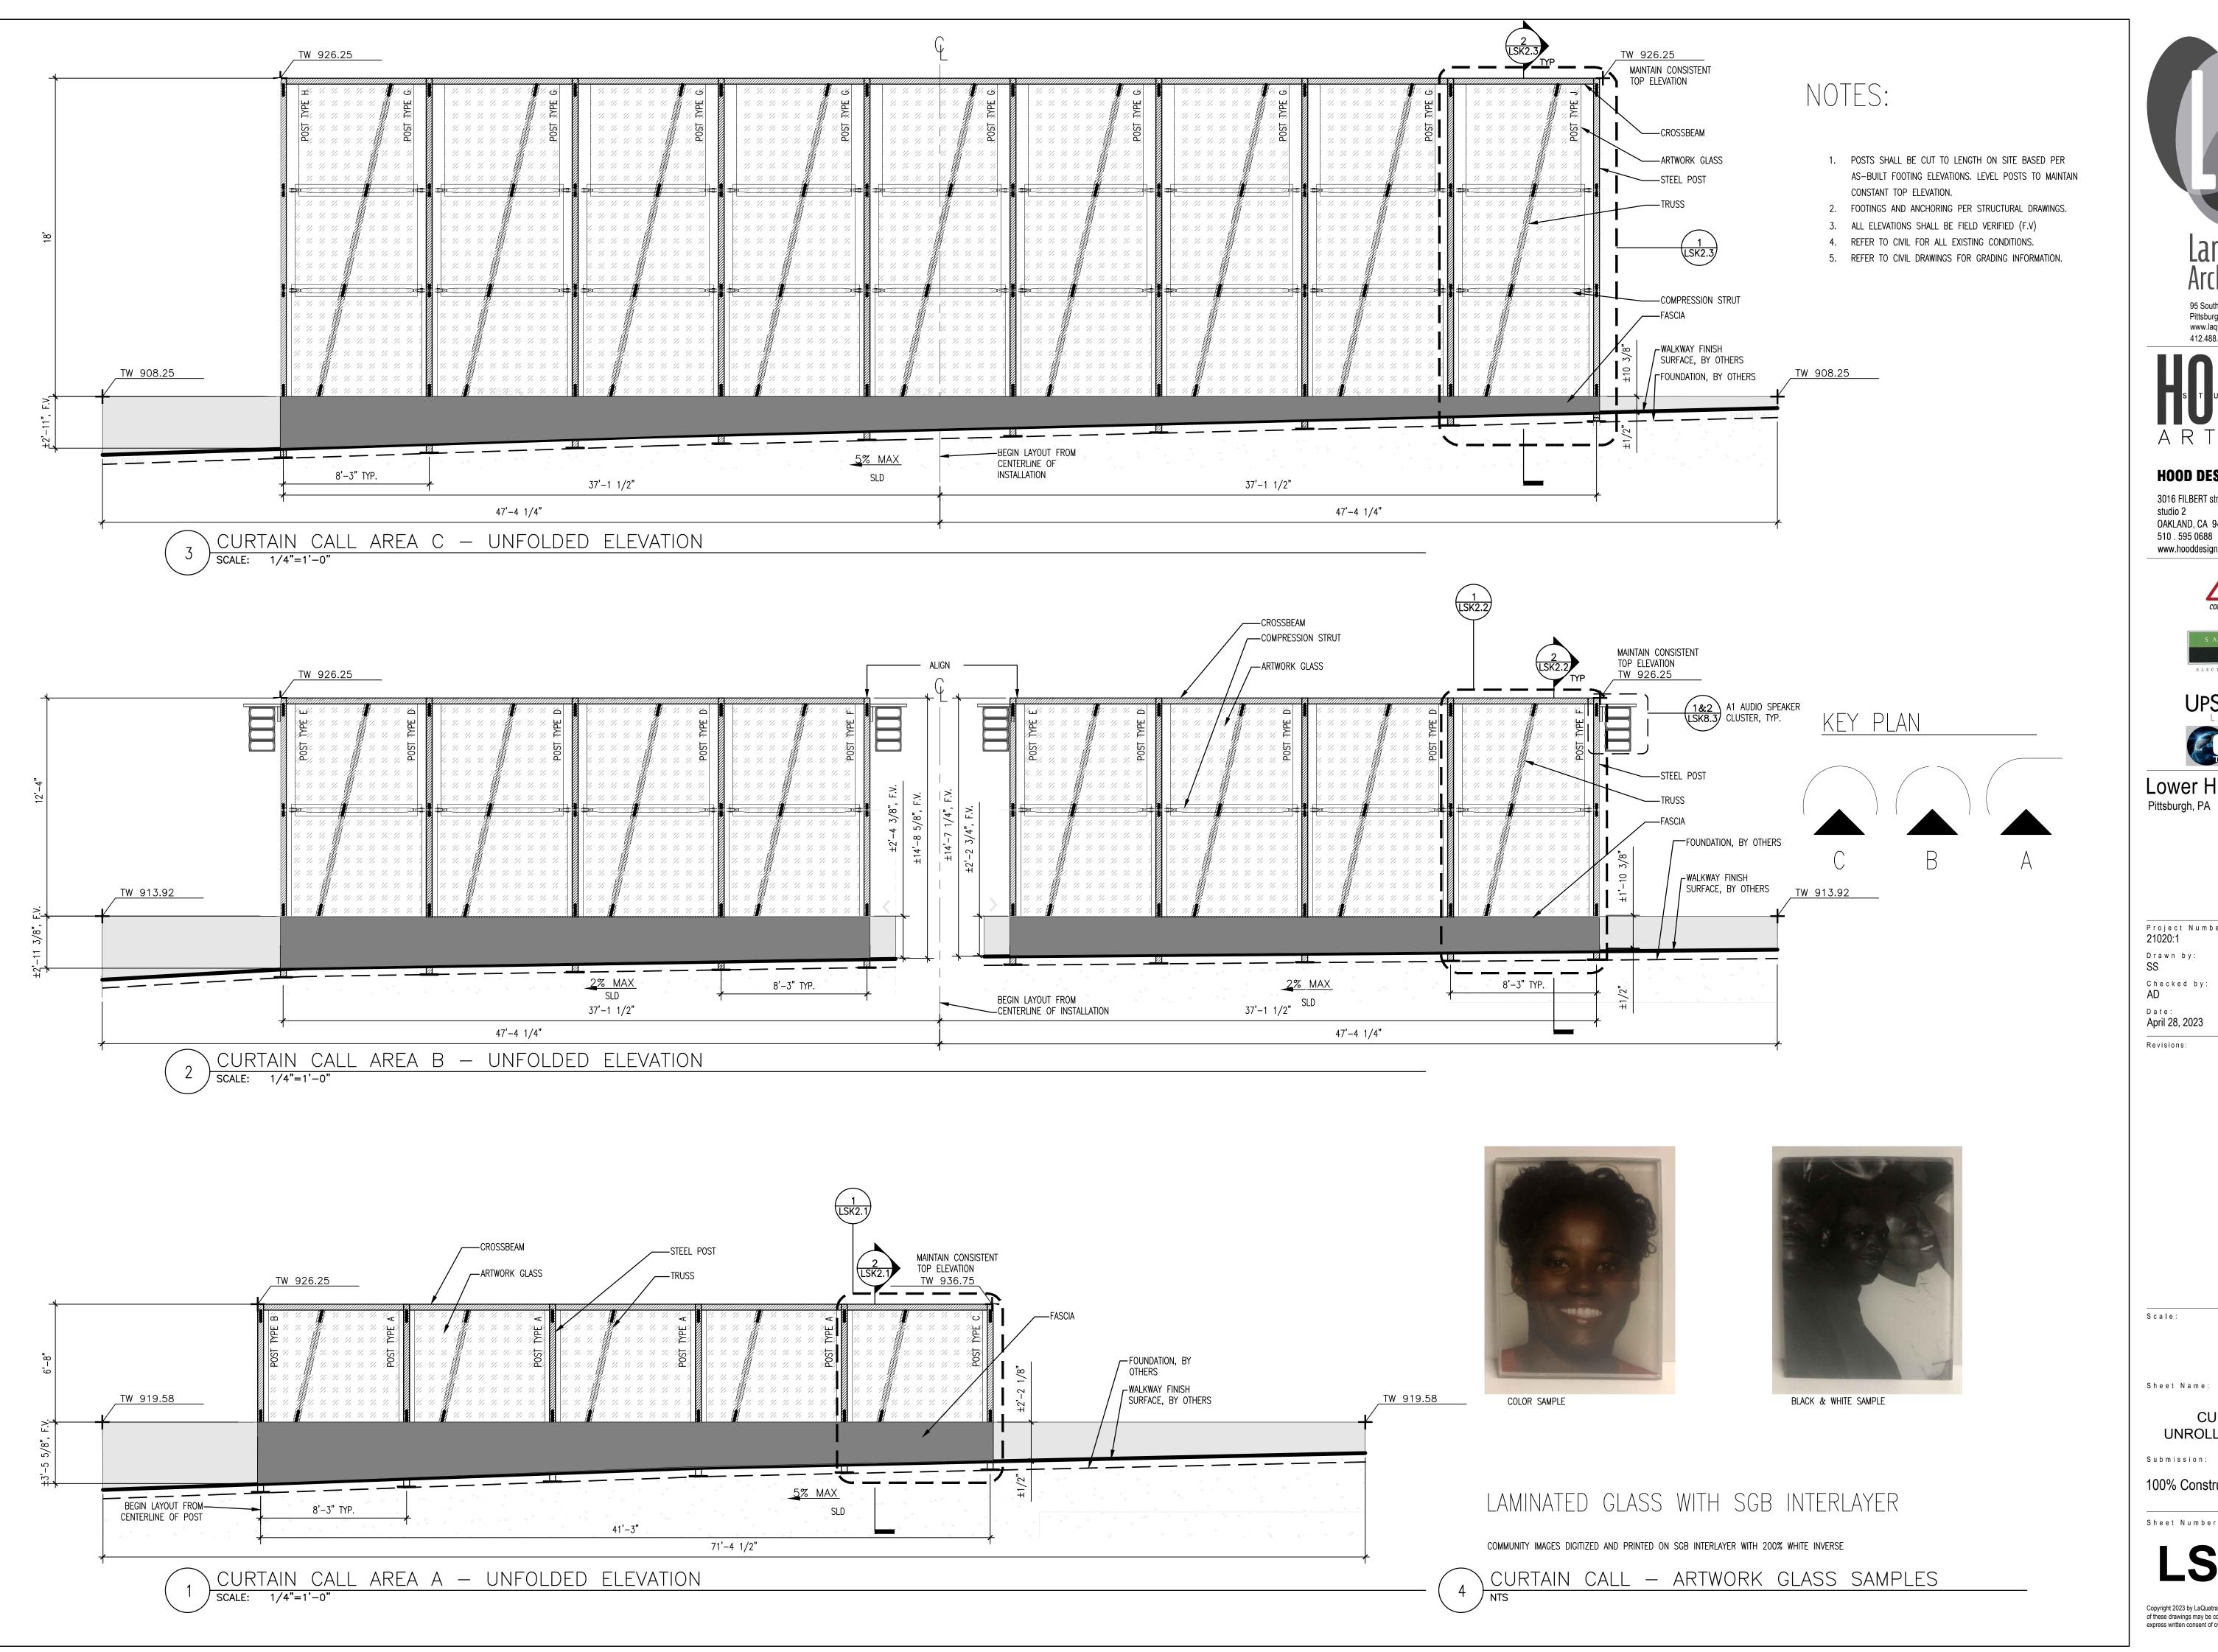LSK1.3





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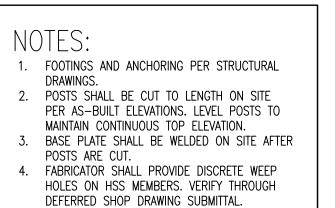
CURTAIN CALL UNROLLED ELEVATIONS

Submission:

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5. GLASS SHALL BE LAMINATED WITH SBG INTERLAYER, PER GLASS SE.



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JPSTUDIO LANDSCAPES



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Pittsburgh, PA

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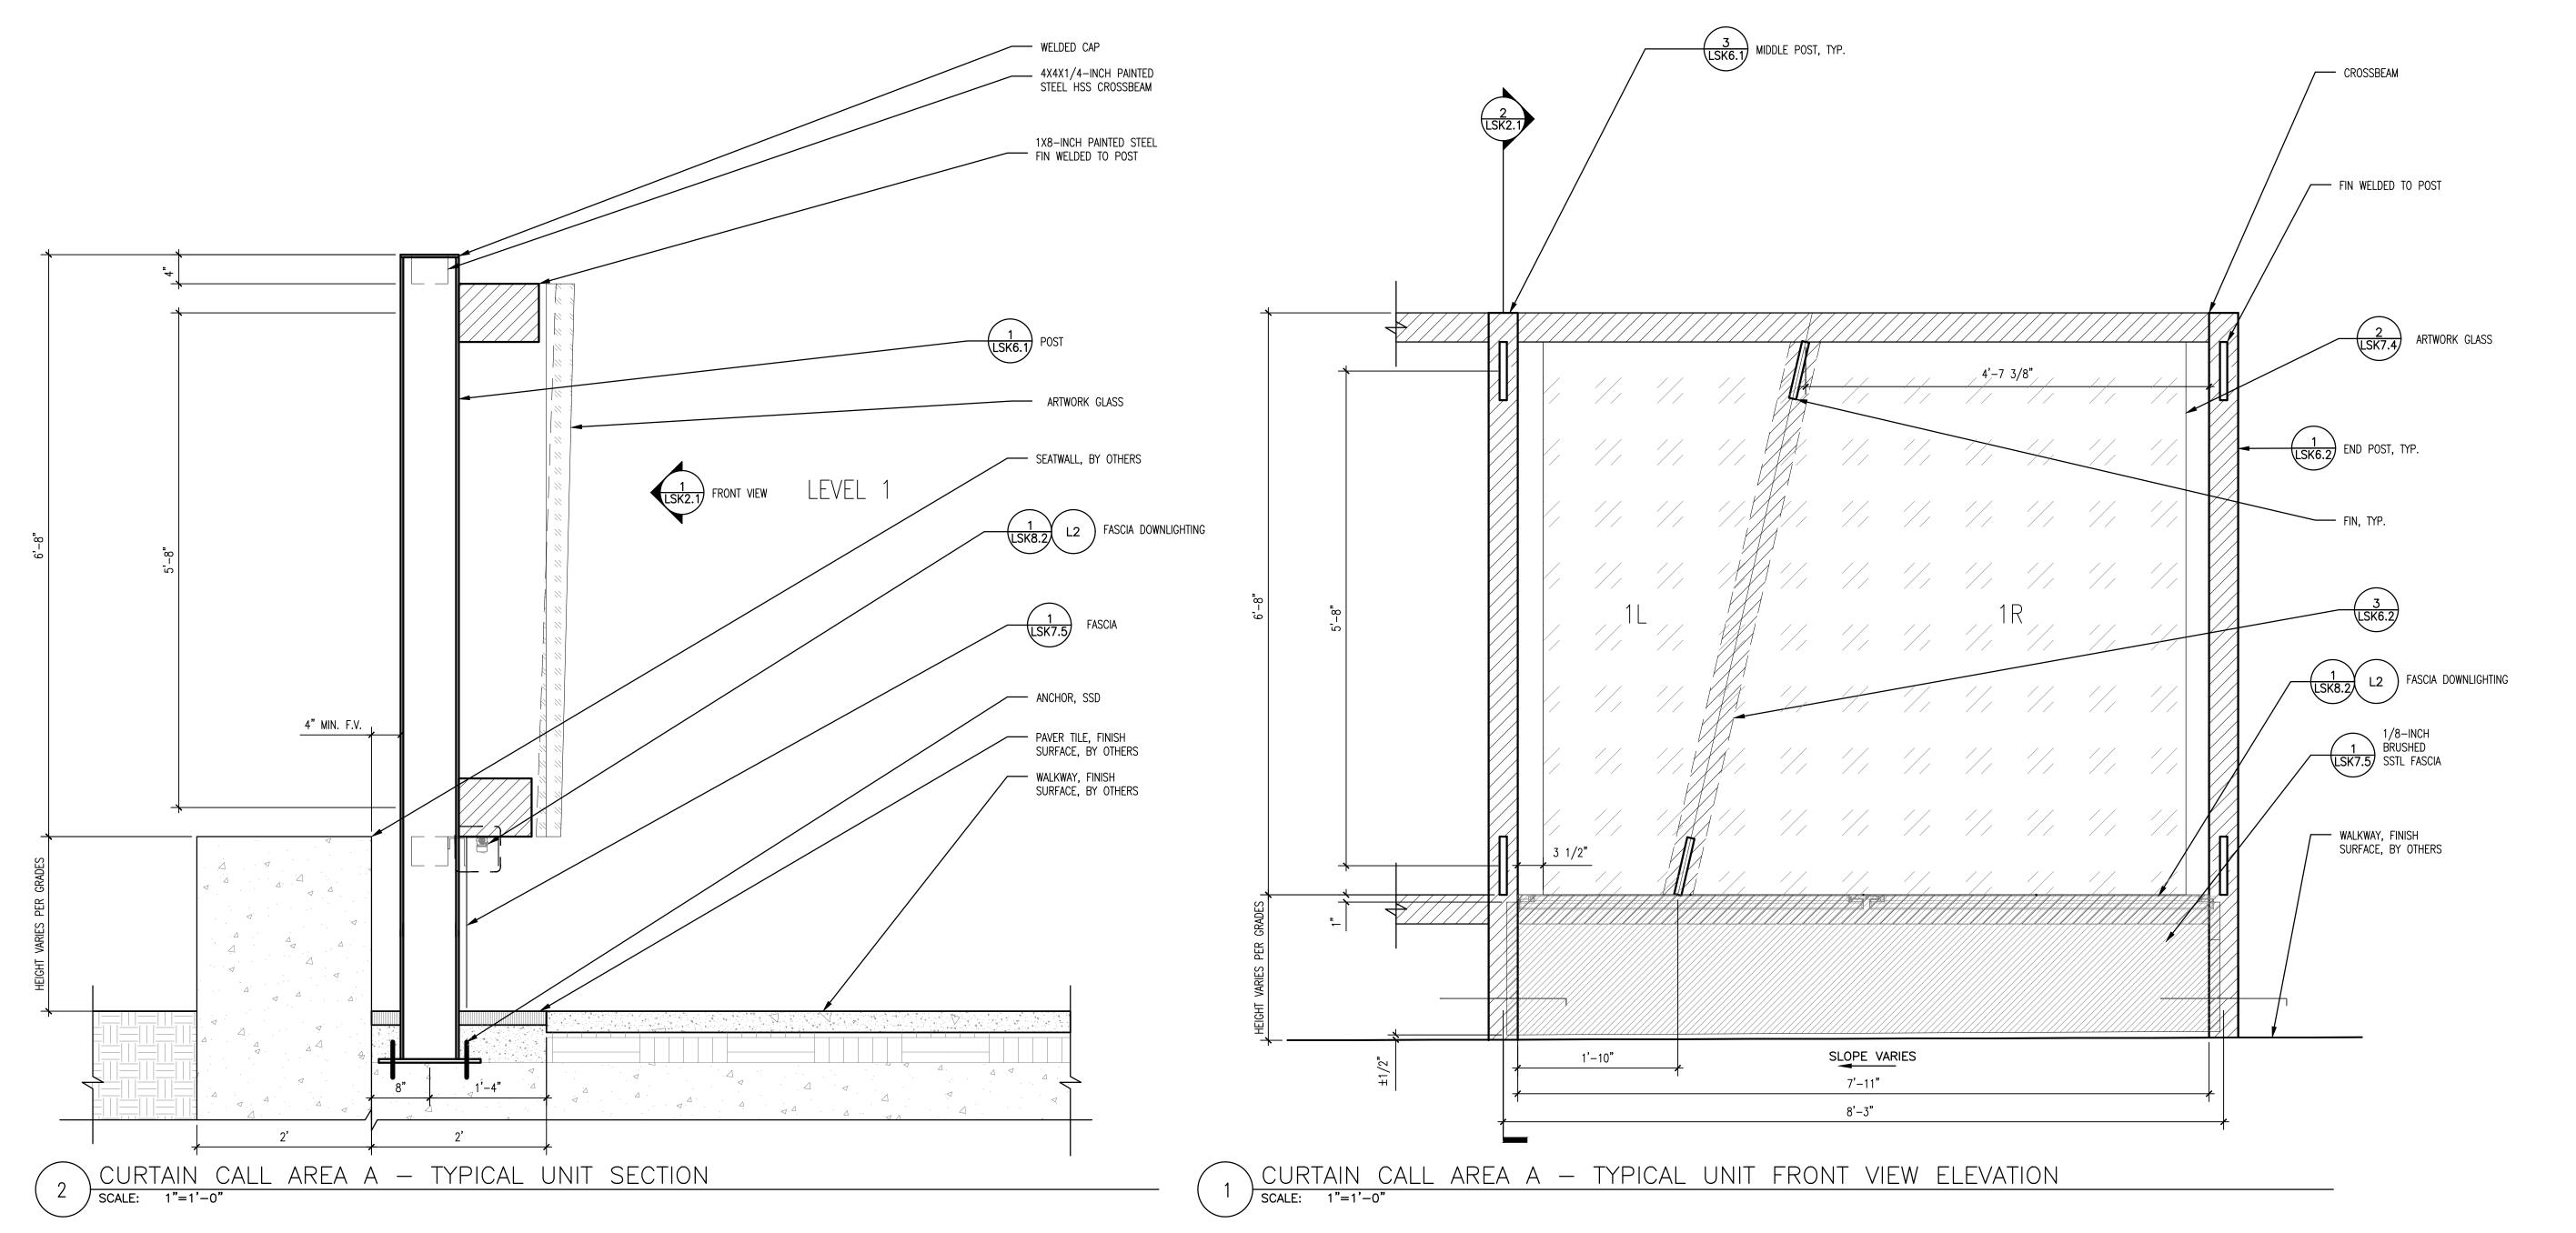
CURTAIN CALL AREA A-ELEVATION AND SECTION

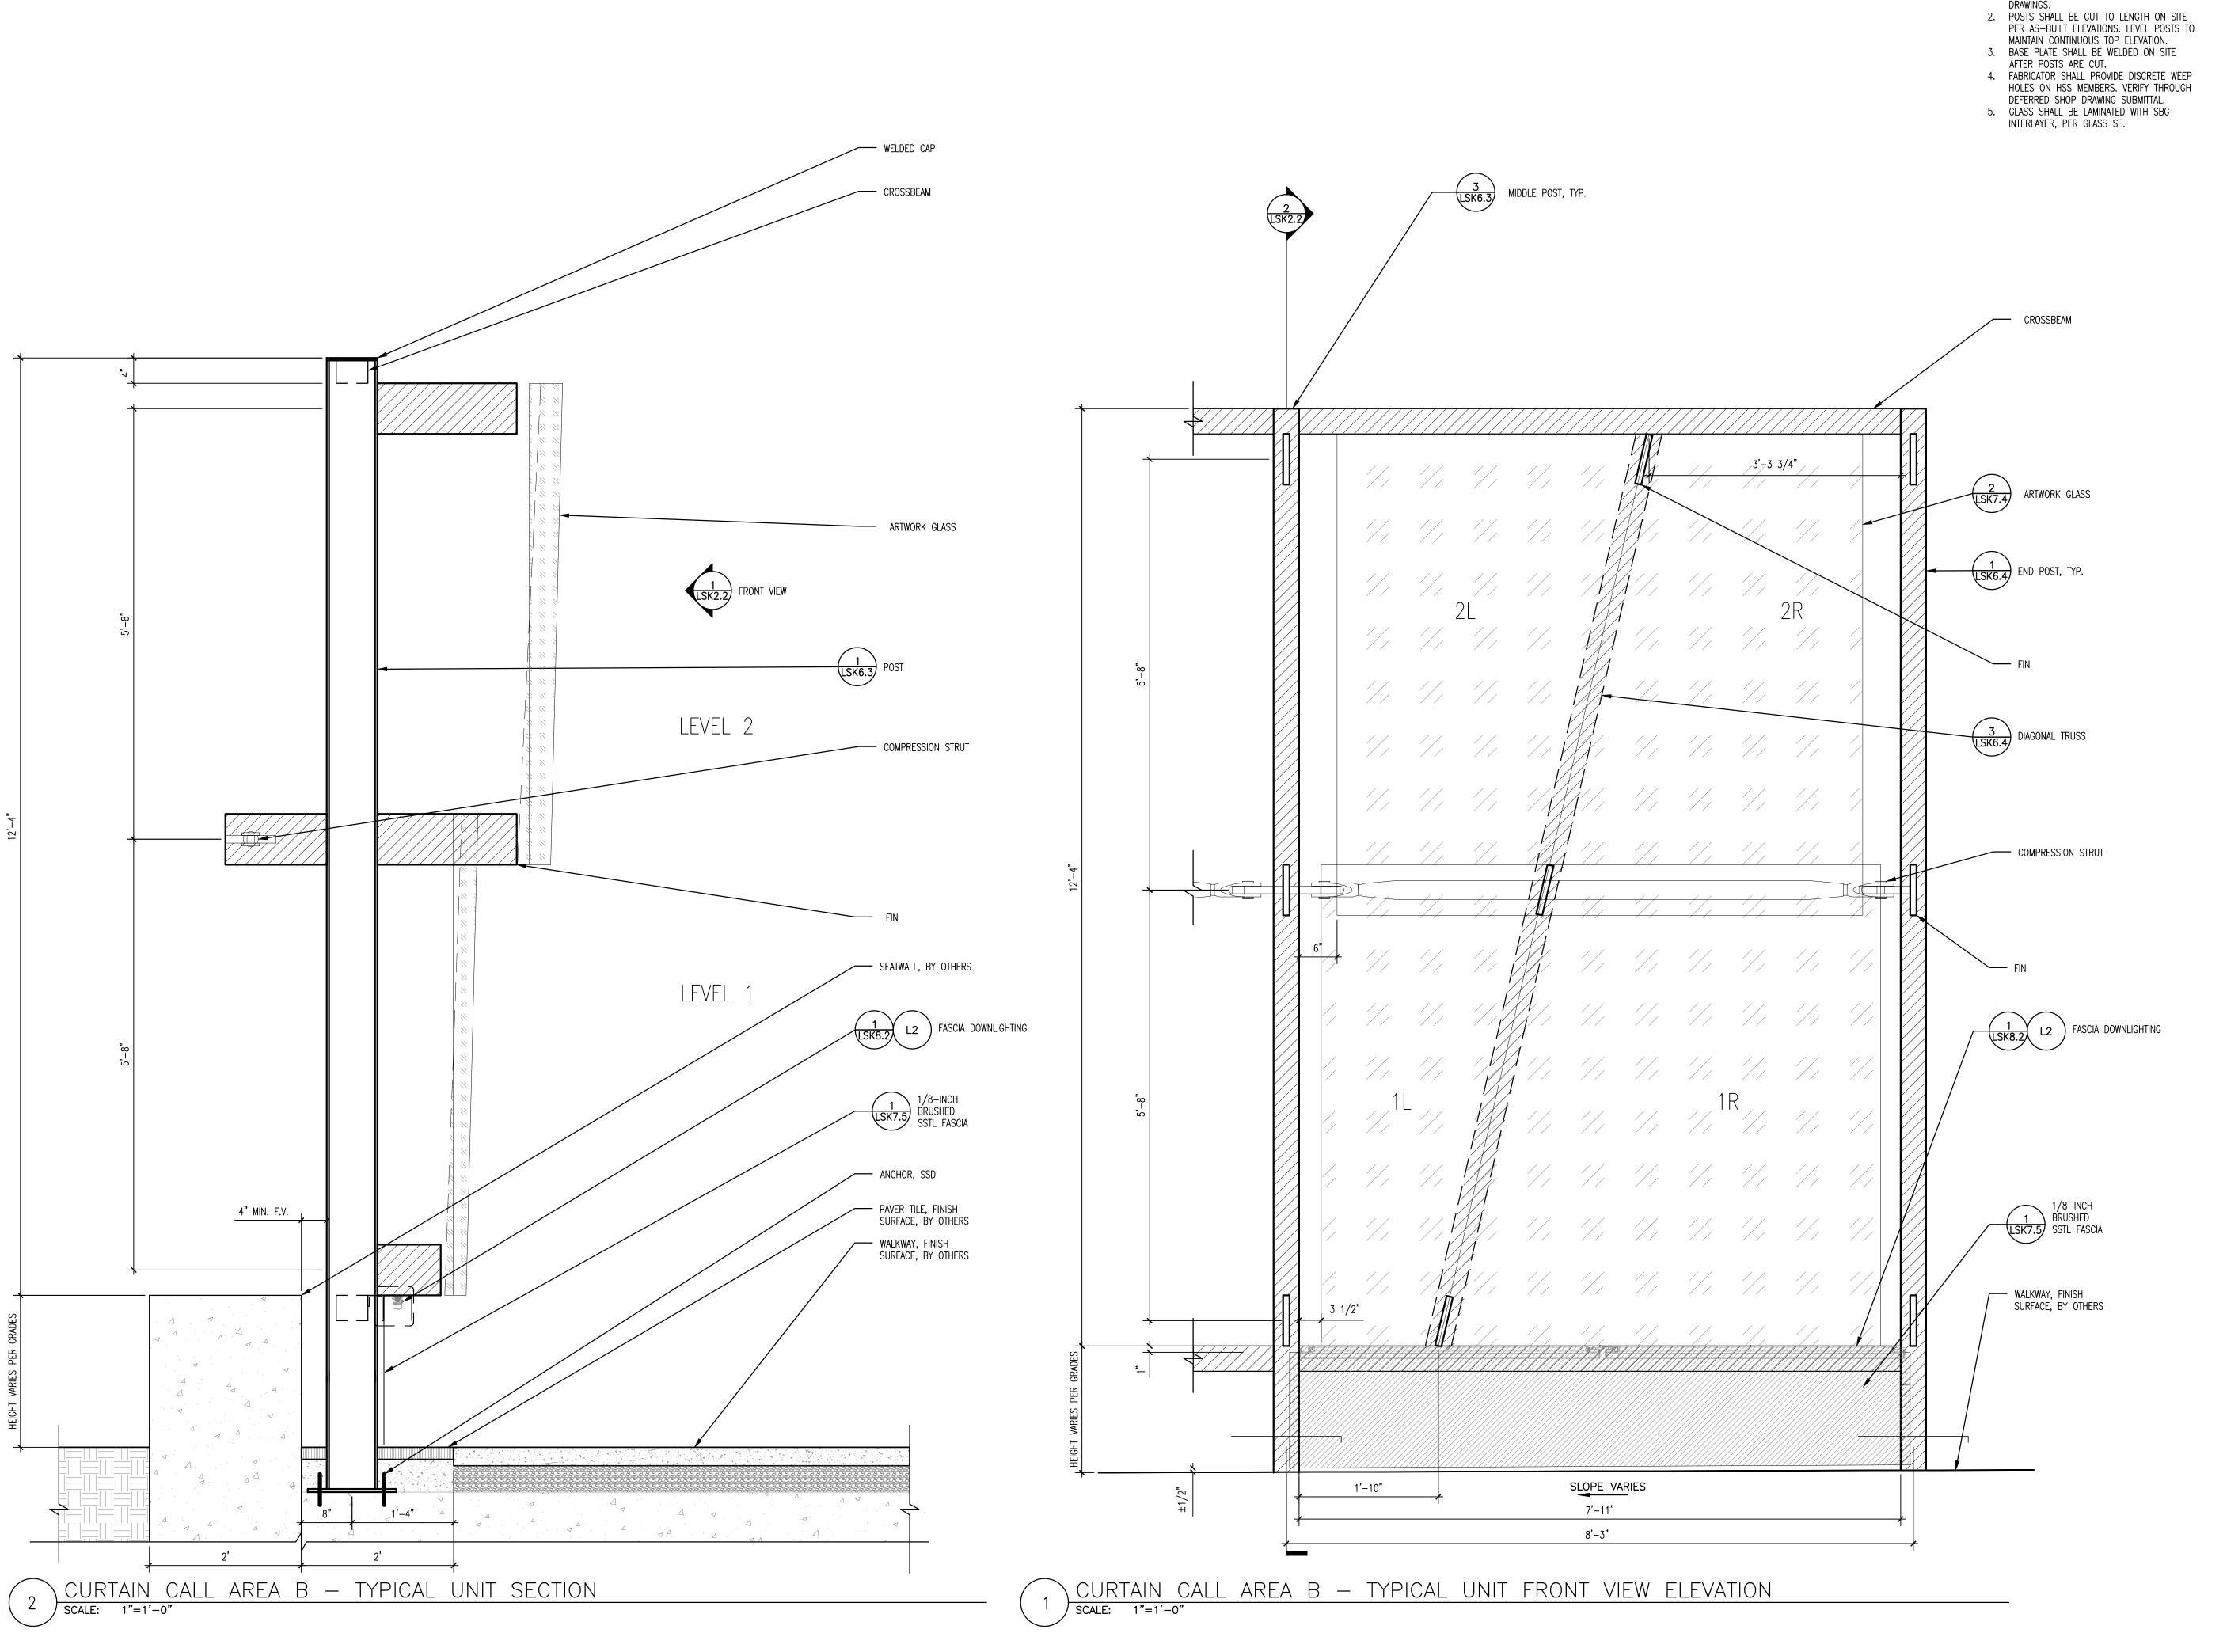
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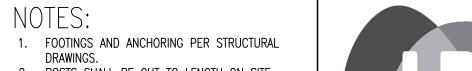
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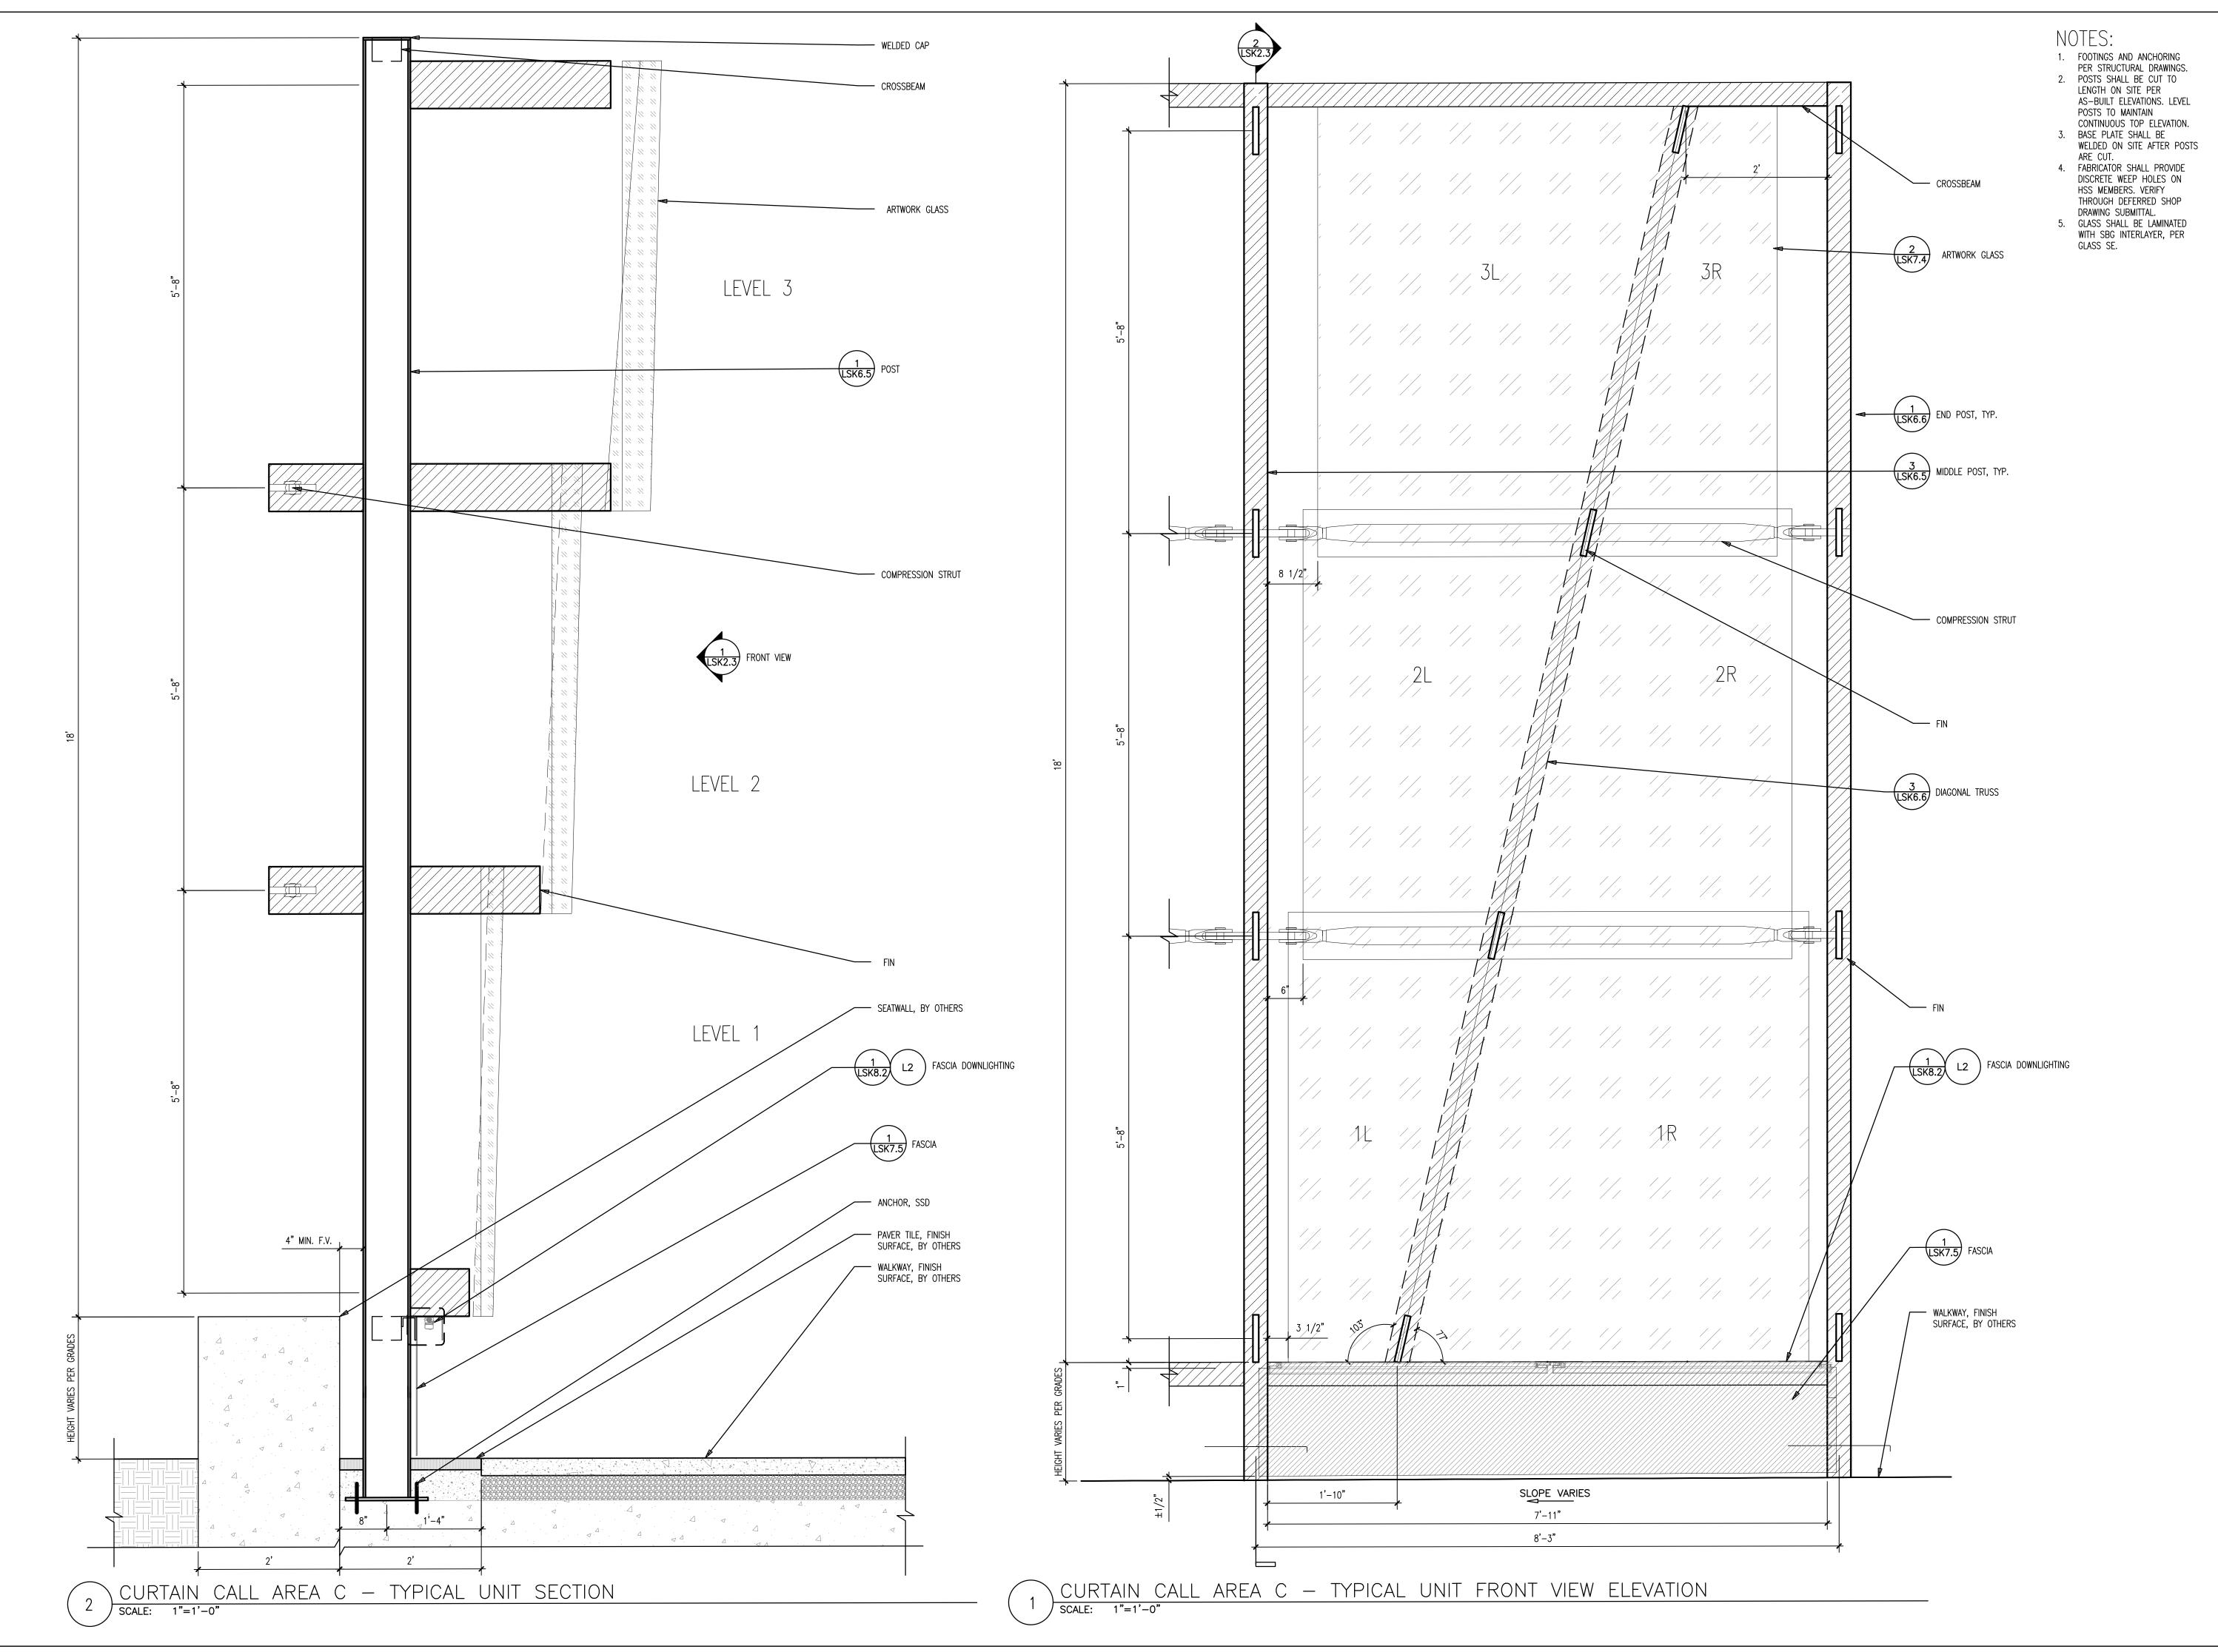
CURTAIN CALL AREA B-ELEVATION AND SECTION

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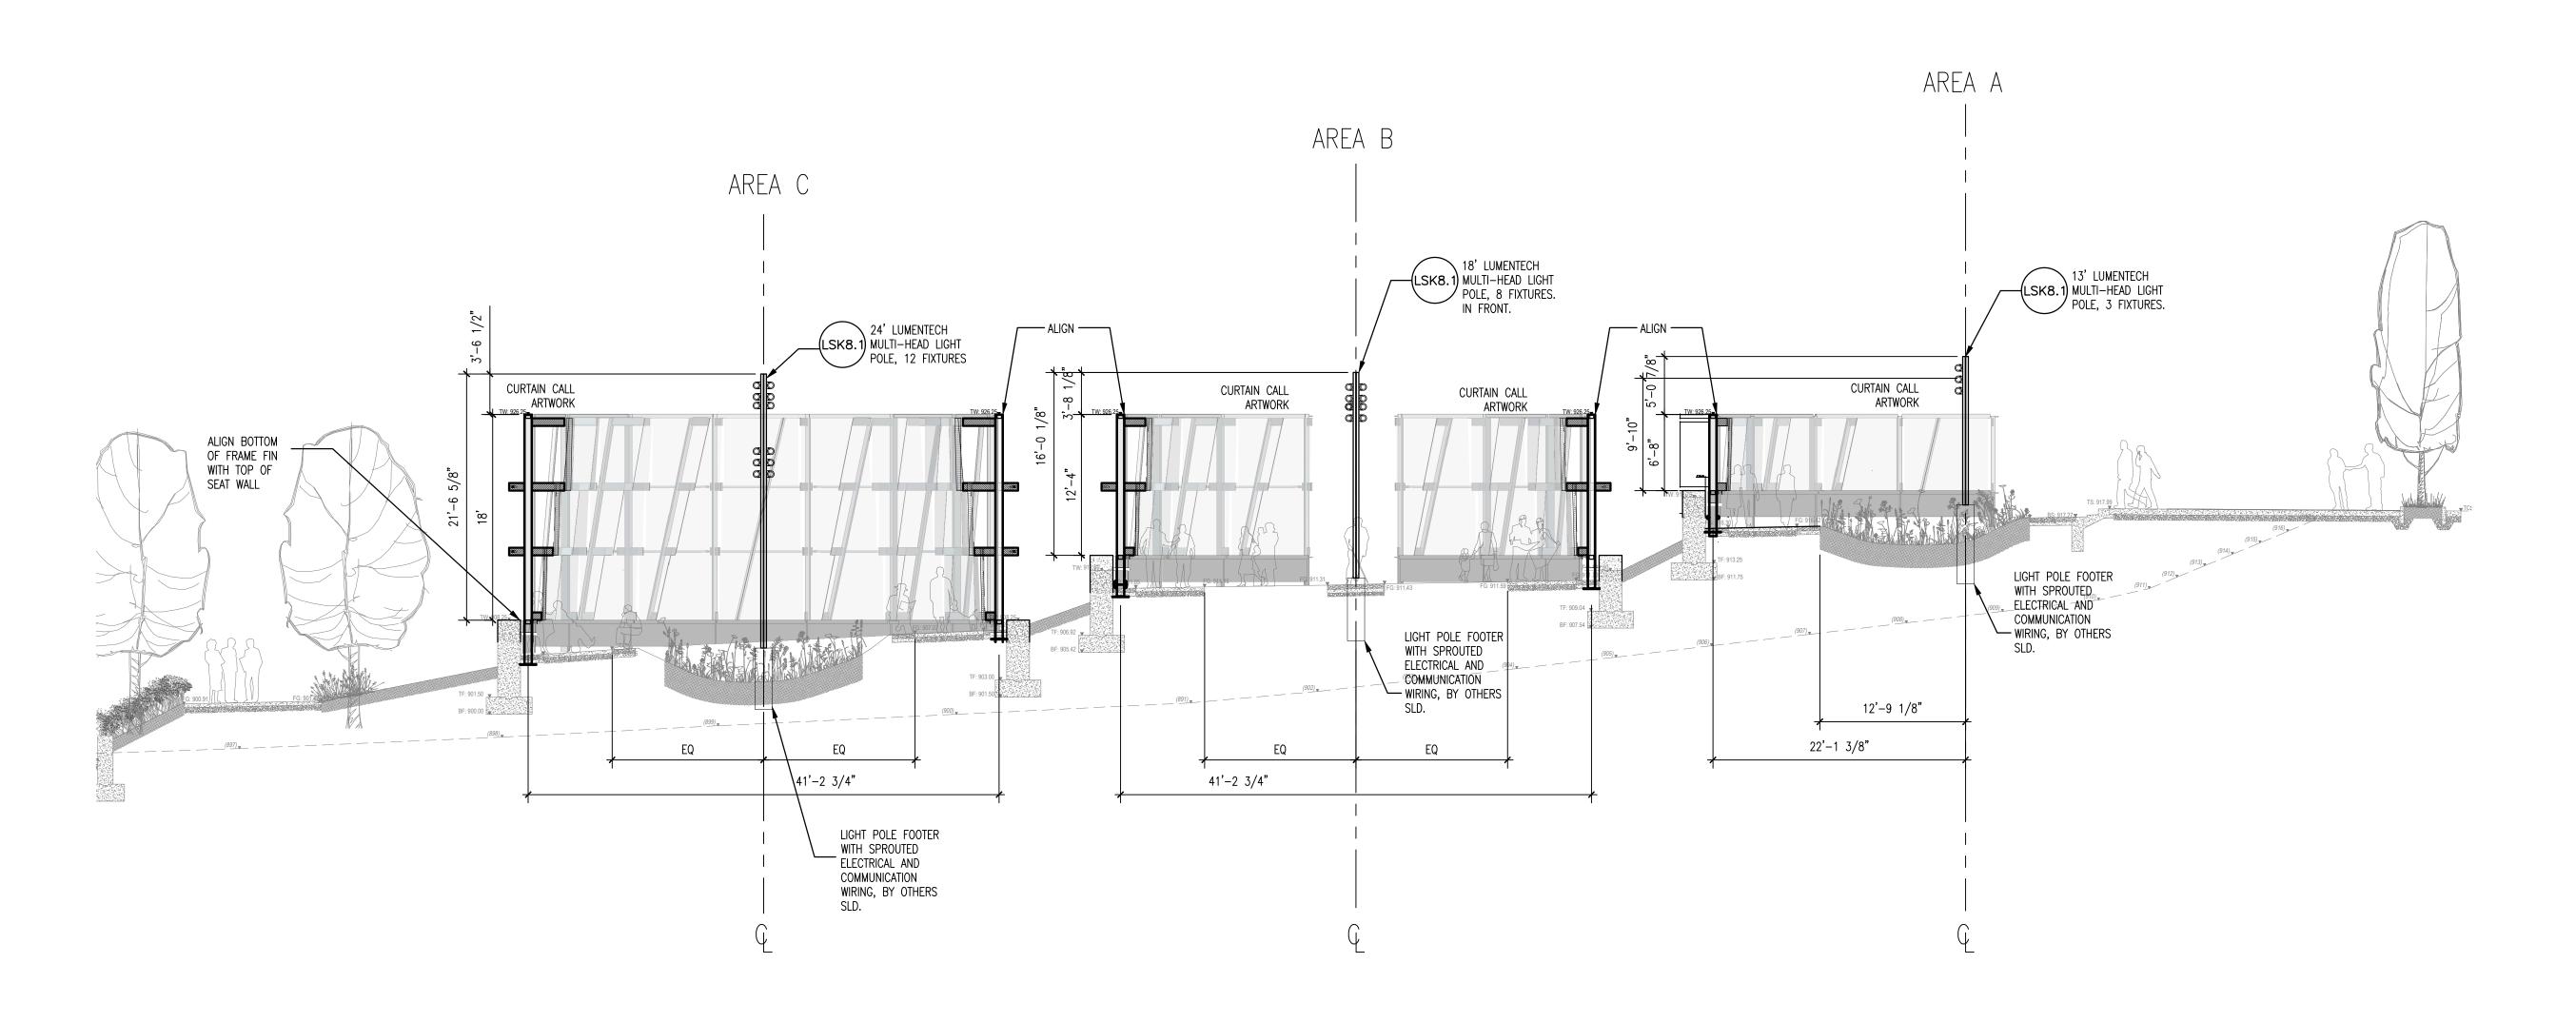
CURTAIN CALL AREA C-ELEVATION AND SECTION

Submission:

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LSK2.3







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Project Number: 21020:1

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CURTAIN CALL SITE SECTION

Submission:

100% Construction Documents

Sheet Number:

LSK2.4

- FOOTINGS AND ANCHORING PER STRUCTURAL DRAWINGS.
- 2. POSTS SHALL BE CUT TO
 LENGTH ON SITE PER AS-BUILT
 ELEVATIONS. LEVEL POSTS TO
 MAINTAIN CONTINUOUS TOP
- ELEVATION.
 3. BASE PLATE SHALL BE WELDED ON SITE AFTER POSTS ARE CUT.
 4. REFER TO SHEET LSK2.1 FOR UNIT'S COMPOSITE AND FOOTING ASSEMBLY.



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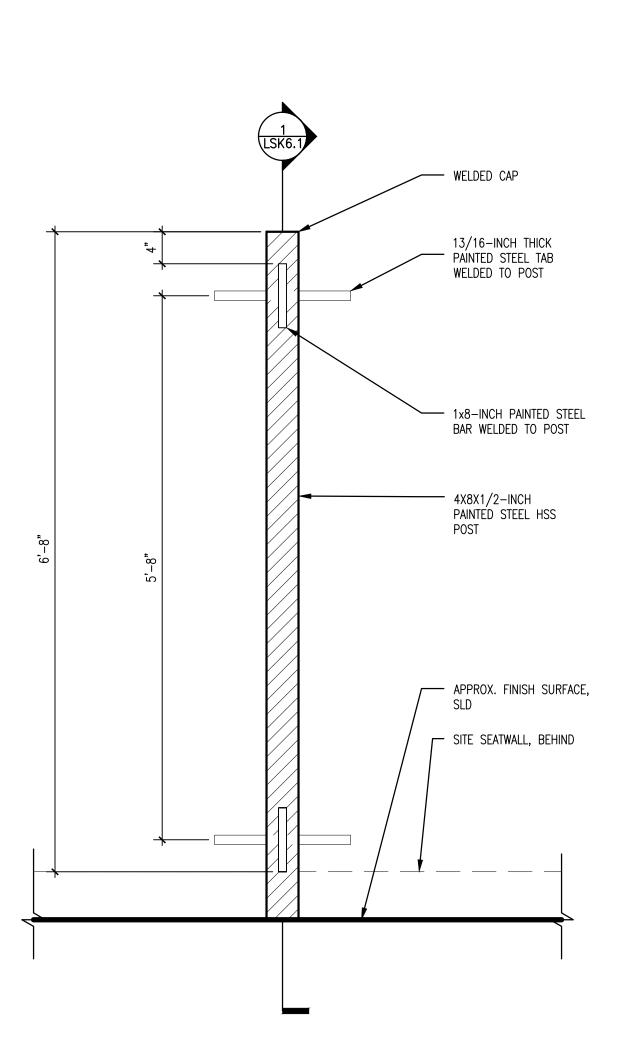
CURTAIN CALL AREA A-FRAMING DETAILS

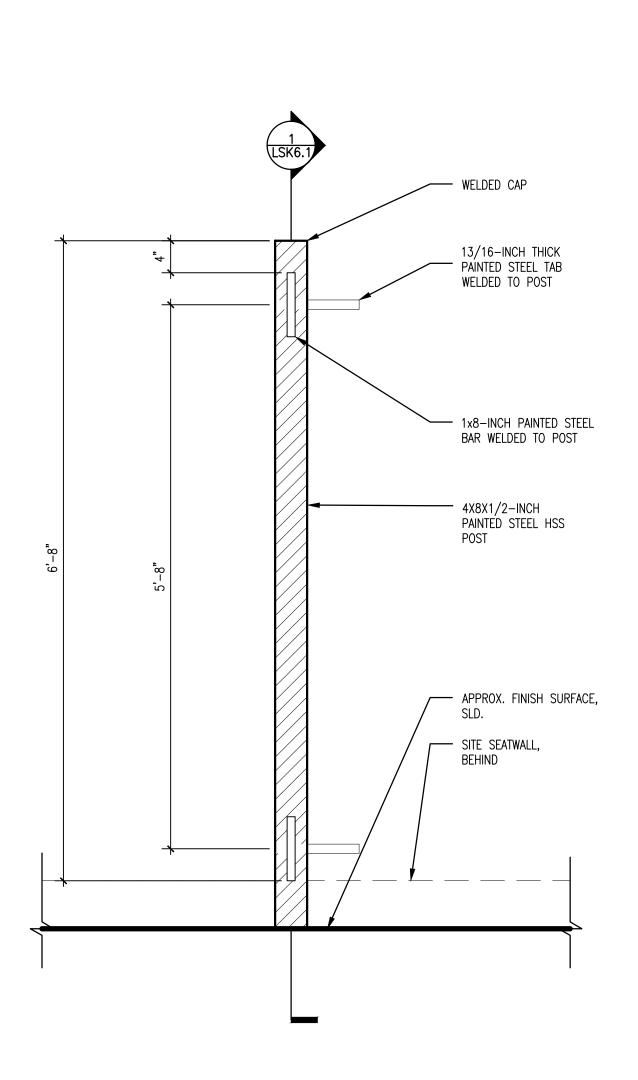
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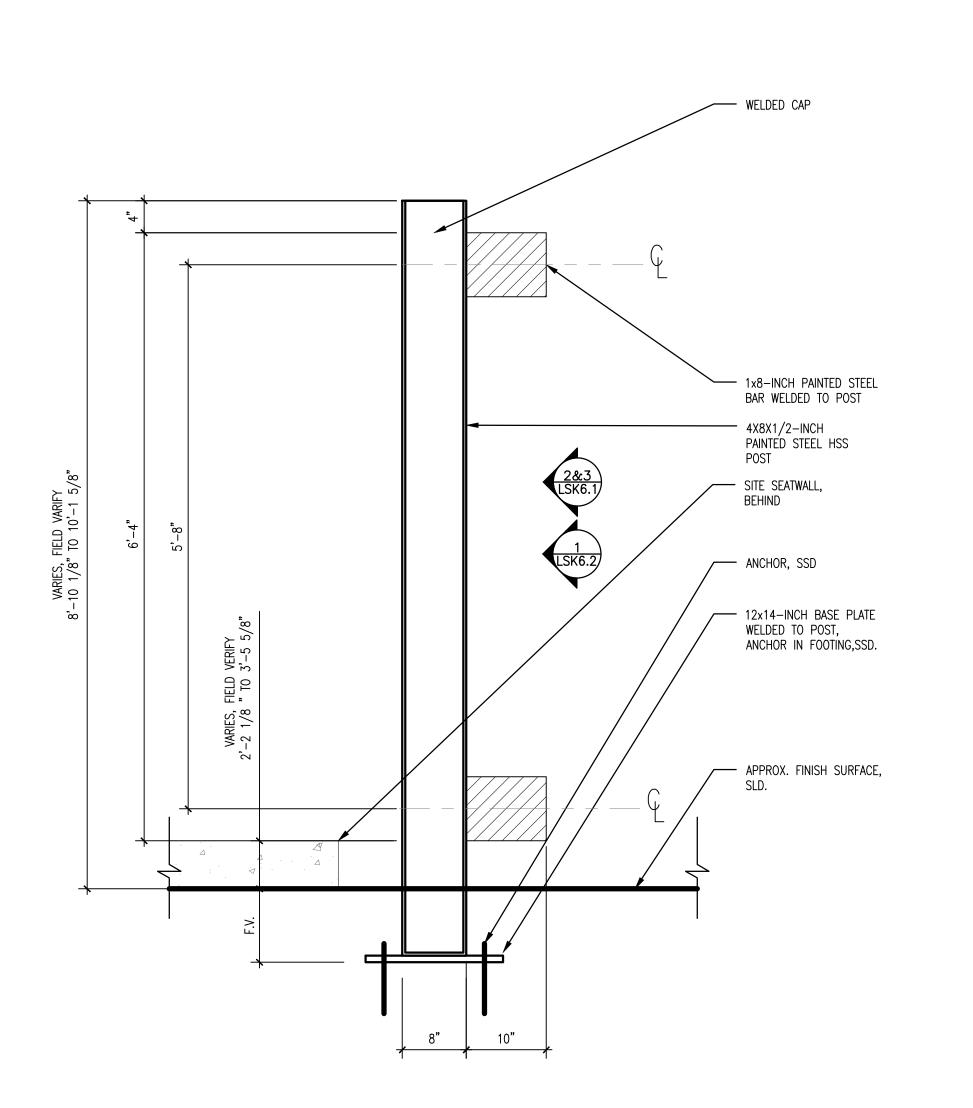
100% Construction Documents

Sheet Number:

LSK6.1

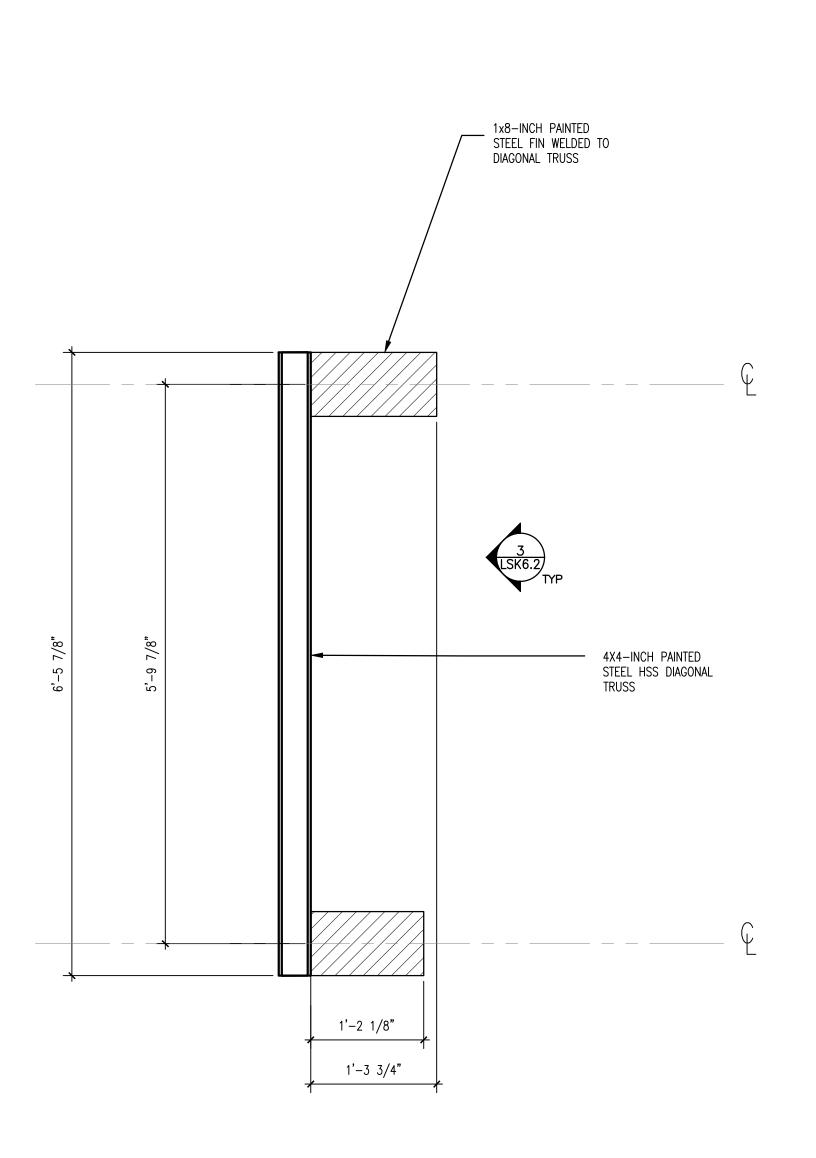


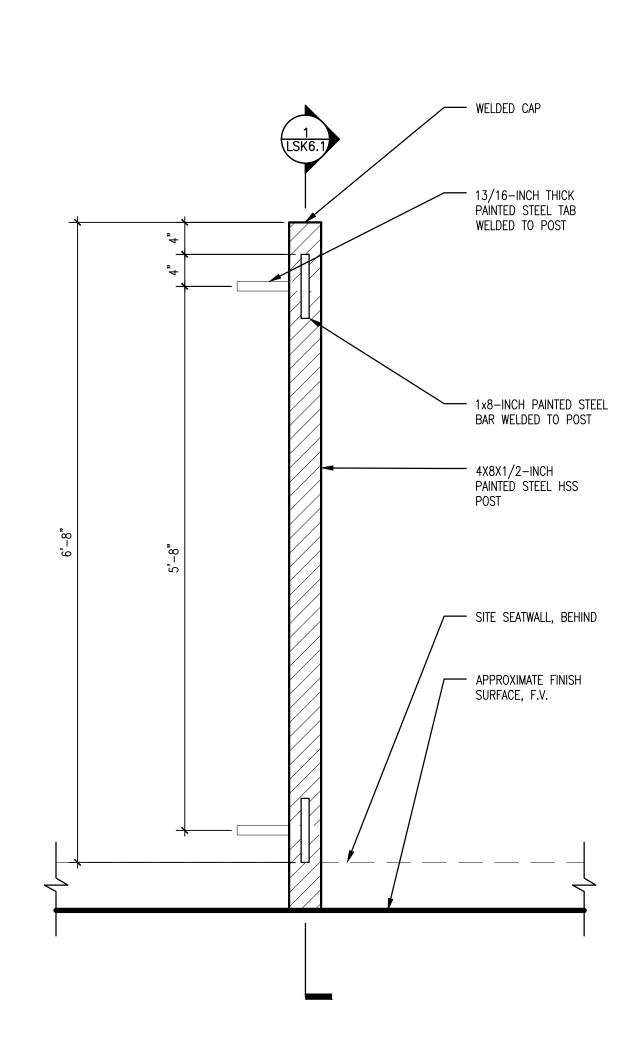




4X4-INCH PAINTED STEEL HSS DIAGONAL TRUSS 1x8-INCH PAINTED STEEL FIN WELDED TO DIAGONAL TRUSS

AREA A — DIAGONAL TRUSS ELEVATION SCALE: 1"=1'-0"





2 AREA A - DIAGONAL TRUSS SECTION

SCALE: 1"=1'-0"

1 AREA A, POST TYPE C — ELEVATION SCALE: 1"=1'-0"

NOTES:

- 1. FOOTINGS AND ANCHORING PER
- STRUCTURAL DRAWINGS.

 2. POSTS SHALL BE CUT TO
 LENGTH ON SITE PER AS-BUILT
 ELEVATIONS. LEVEL POSTS TO
 MAINTAIN CONTINUOUS TOP
- MAINTAIN CONTINUOUS TOP ELEVATION.

 3. BASE PLATE SHALL BE WELDED ON SITE AFTER POSTS ARE CUT
- AND LEVELED WITH GROUT.

 4. DIAGONAL FINS ARE BASED OFF OF A 2-INCH BUFFER FROM GLASS PANEL SEAM LOCATION. FABRICATOR TO CONFIRM BUFFER DISTANCE IN MOCK-UP
- BUFFER DISTANCE IN MOCK-UP.

 5. FABRICATOR SHALL PROVIDE
 WEEP HOLES ON DISCRETE HSS
 MEMBERS. PROVIDE IN
 DEFERRED SHOP DRAWING
- SUBMITTAL.

 6. REFER TO SHEET LSK2.1 FOR UNIT'S COMPOSITE AND FOOTING ASSEMBLY.



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CURTAIN CALL AREA A -FRAMING DETAILS

Submission:

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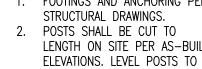
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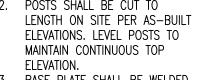
LSK6.2

- 1. FOOTINGS AND ANCHORING PER
- 2. POSTS SHALL BE CUT TO
- 3. BASE PLATE SHALL BE WELDED ON SITE AFTER POSTS ARE CUT.

 4. REFER TO SHEET LSK2.2 FOR UNIT'S COMPOSITE AND FOOTING ASSEMBLY.







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CURTAIN CALL AREA B-FRAMING DETAILS


Submission:

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- WELDED CAP

4X8X1/2-INCH

PAINTÉD STEEL HSS

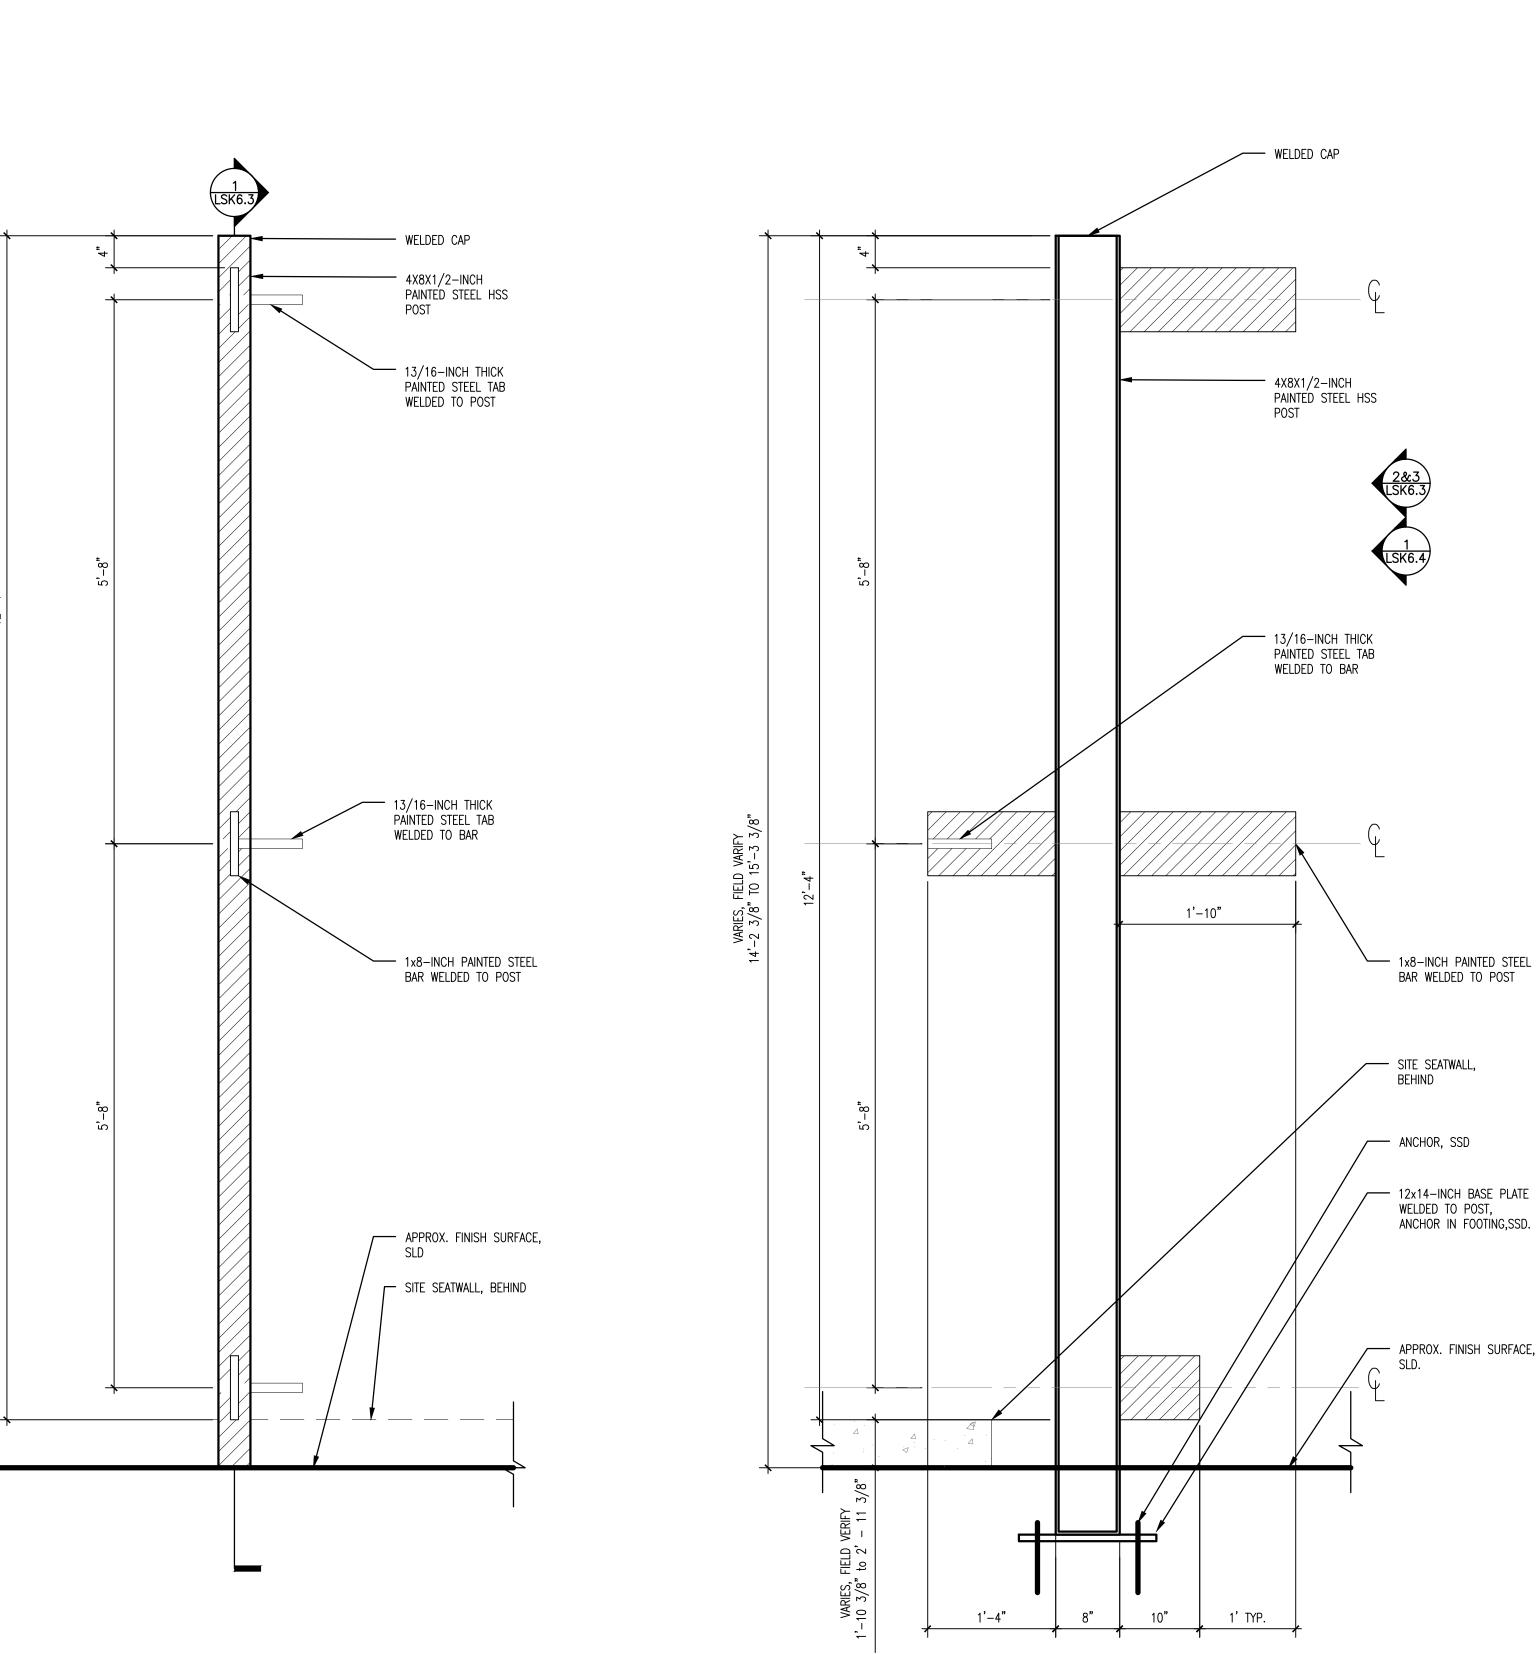- 13/16-INCH THICK

PAINTED STEEL TAB
WELDED TO POST

13/16-INCH THICK PAINTED STEEL TAB WELDED TO BAR

—— 1x8-INCH PAINTED STEEL

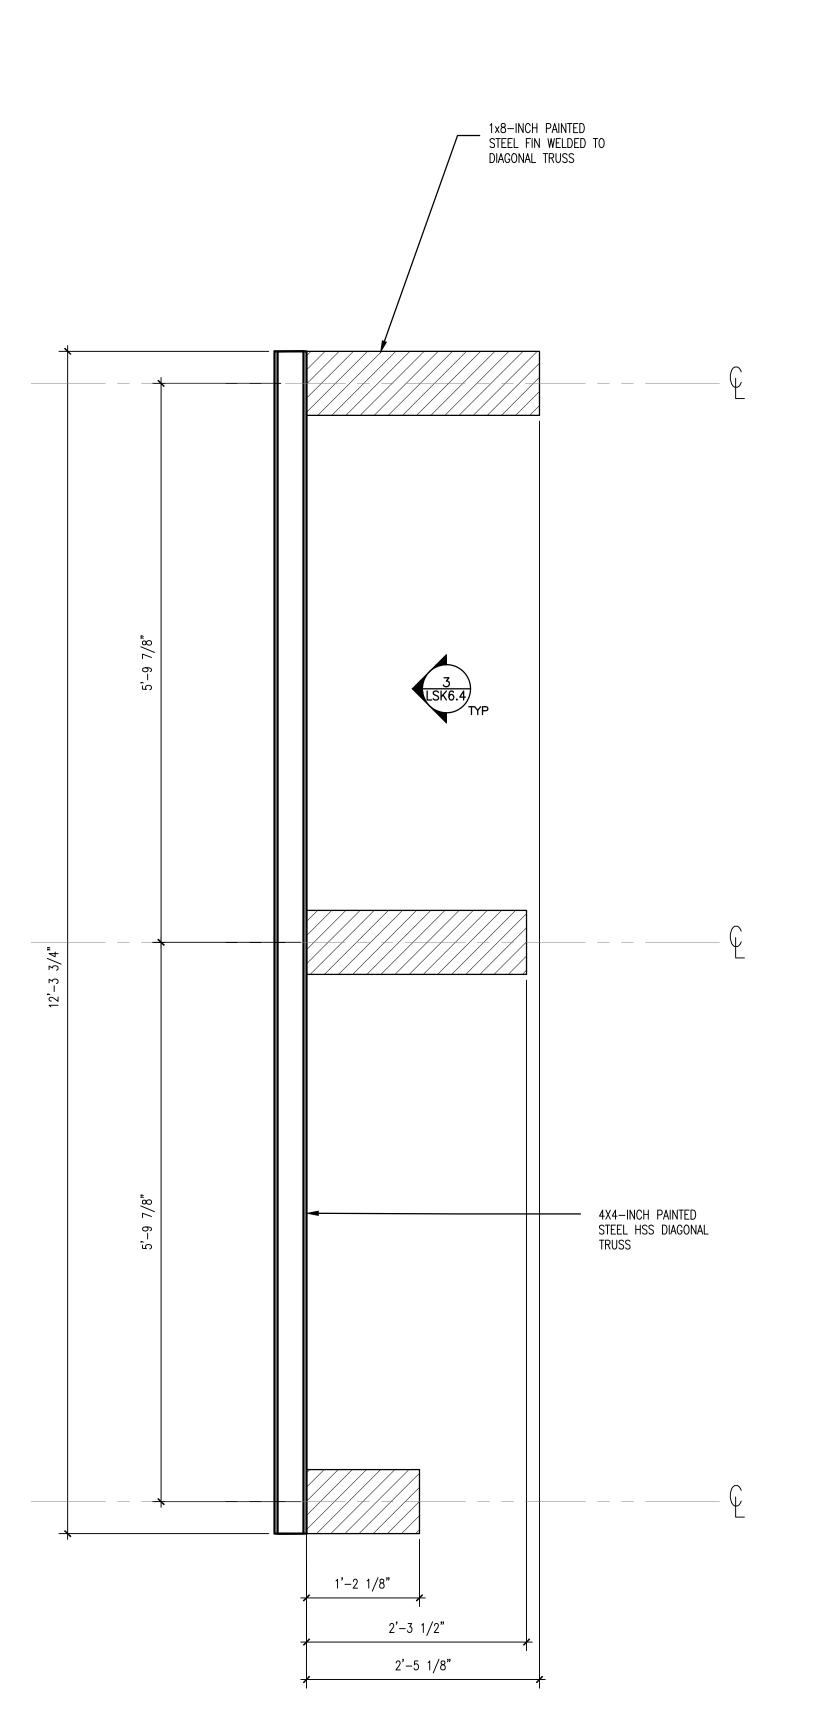
BAR WELDED TO POST

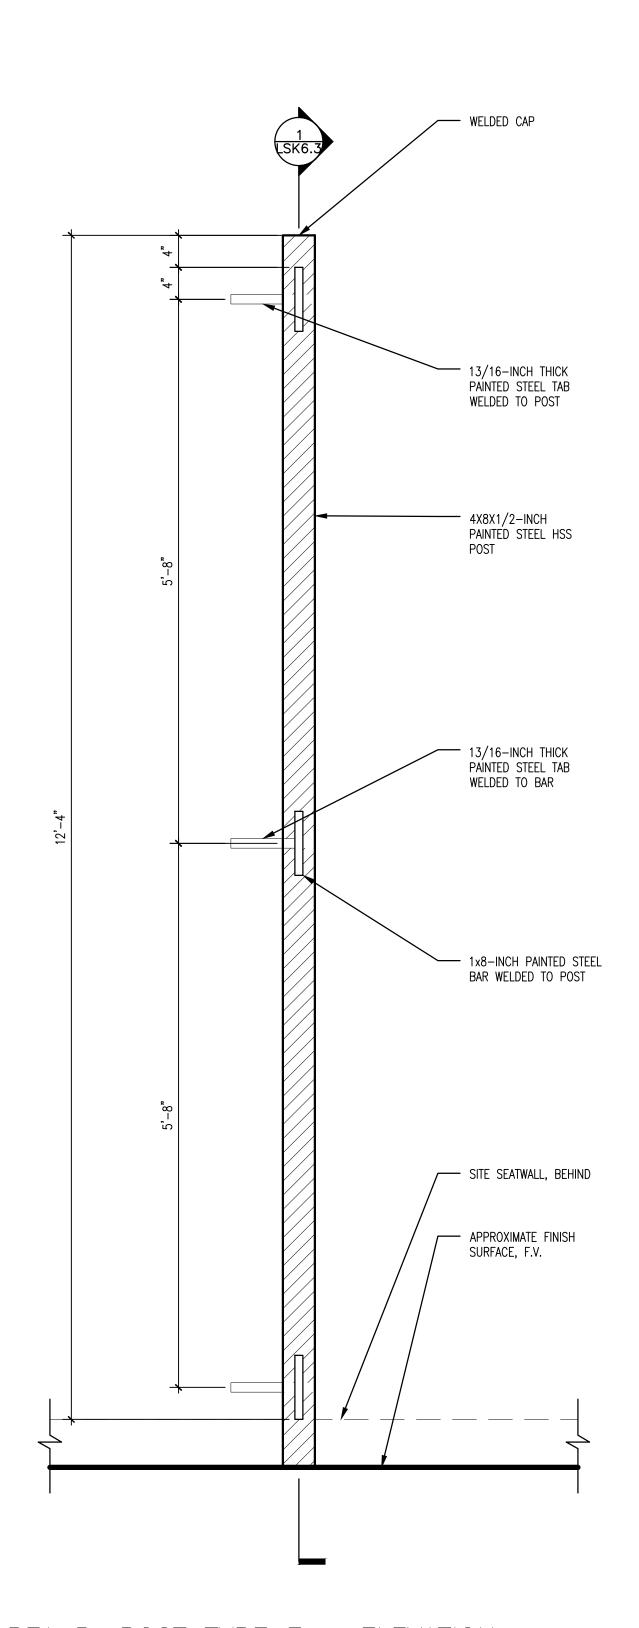
APPROX. FINISH SURFACE,

SITE SEATWALL, BEHIND



4X4-INCH PAINTED STEEL HSS DIAGONAL 1x8-INCH PAINTED STEEL FIN WELDED TO DIAGONAL





NOTES:

- 1. FOOTINGS AND ANCHORING PER
- STRUCTURAL DRAWINGS.

 2. POSTS SHALL BE CUT TO
 LENGTH ON SITE PER AS-BUILT
 ELEVATIONS. LEVEL POSTS TO
 MAINTAIN CONTINUOUS TOP
- 3. BASE PLATE SHALL BE WELDED ON SITE AFTER POSTS ARE CUT
- AND LEVELED WITH GROUT. 4. DIAGONAL FINS ARE BASED OFF OF A 2-INCH BUFFER FROM GLASS PANEL SEAM LOCATION. FABRICATOR TO CONFIRM
- BUFFER DISTANCE IN MOCK-UP. 5. FABRICATOR SHALL PROVIDE WEEP HOLES ON DISCRETE HSS MEMBERS. PROVIDE IN DEFERRED SHOP DRAWING
- SUBMITTAL. 6. REFER TO SHEET LSK2.2 FOR UNIT'S COMPOSITE AND FOOTING ASSEMBLY.



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CURTAIN CALL AREA B -FRAMING DETAILS

Submission:

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Sheet Number:


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3 AREA B — DIAGONAL TRUSS ELEVATION SCALE: 1"=1'-0"

AREA B — DIAGONAL TRUSS SECTION

SCALE: 1"=1'-0"

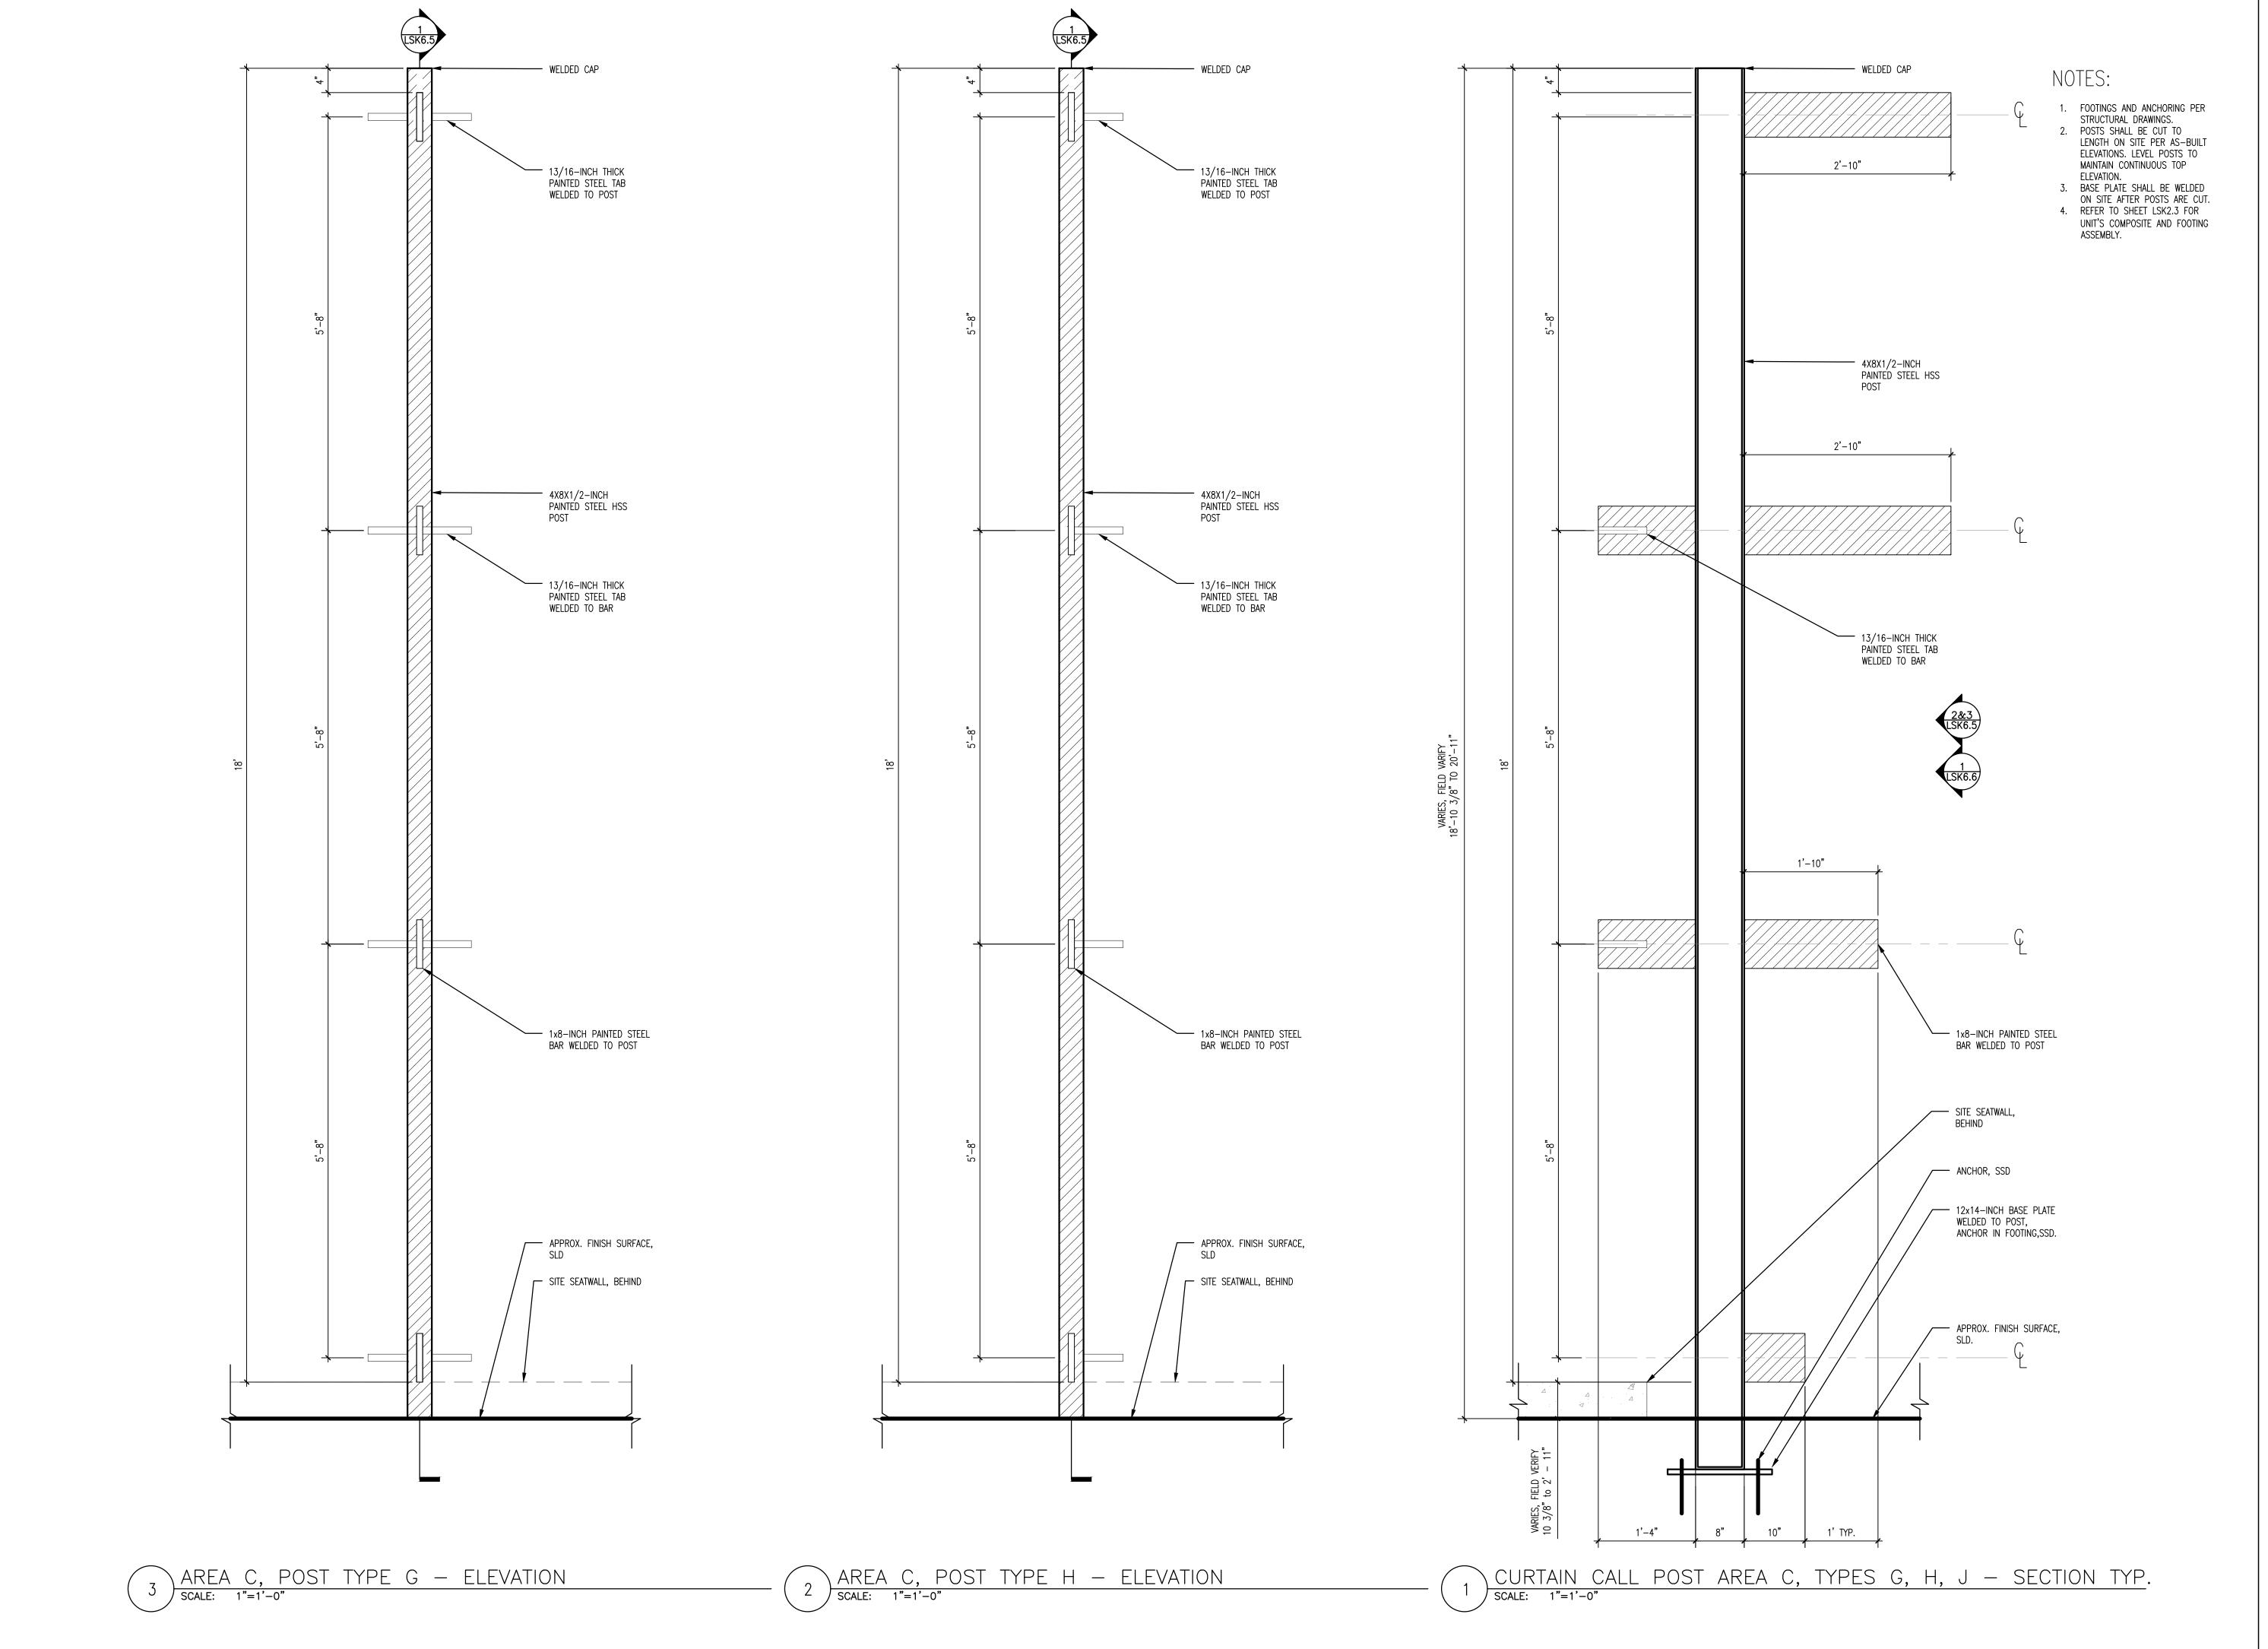AREA B, POST TYPE F — ELEVATION SCALE: 1"=1'-0"





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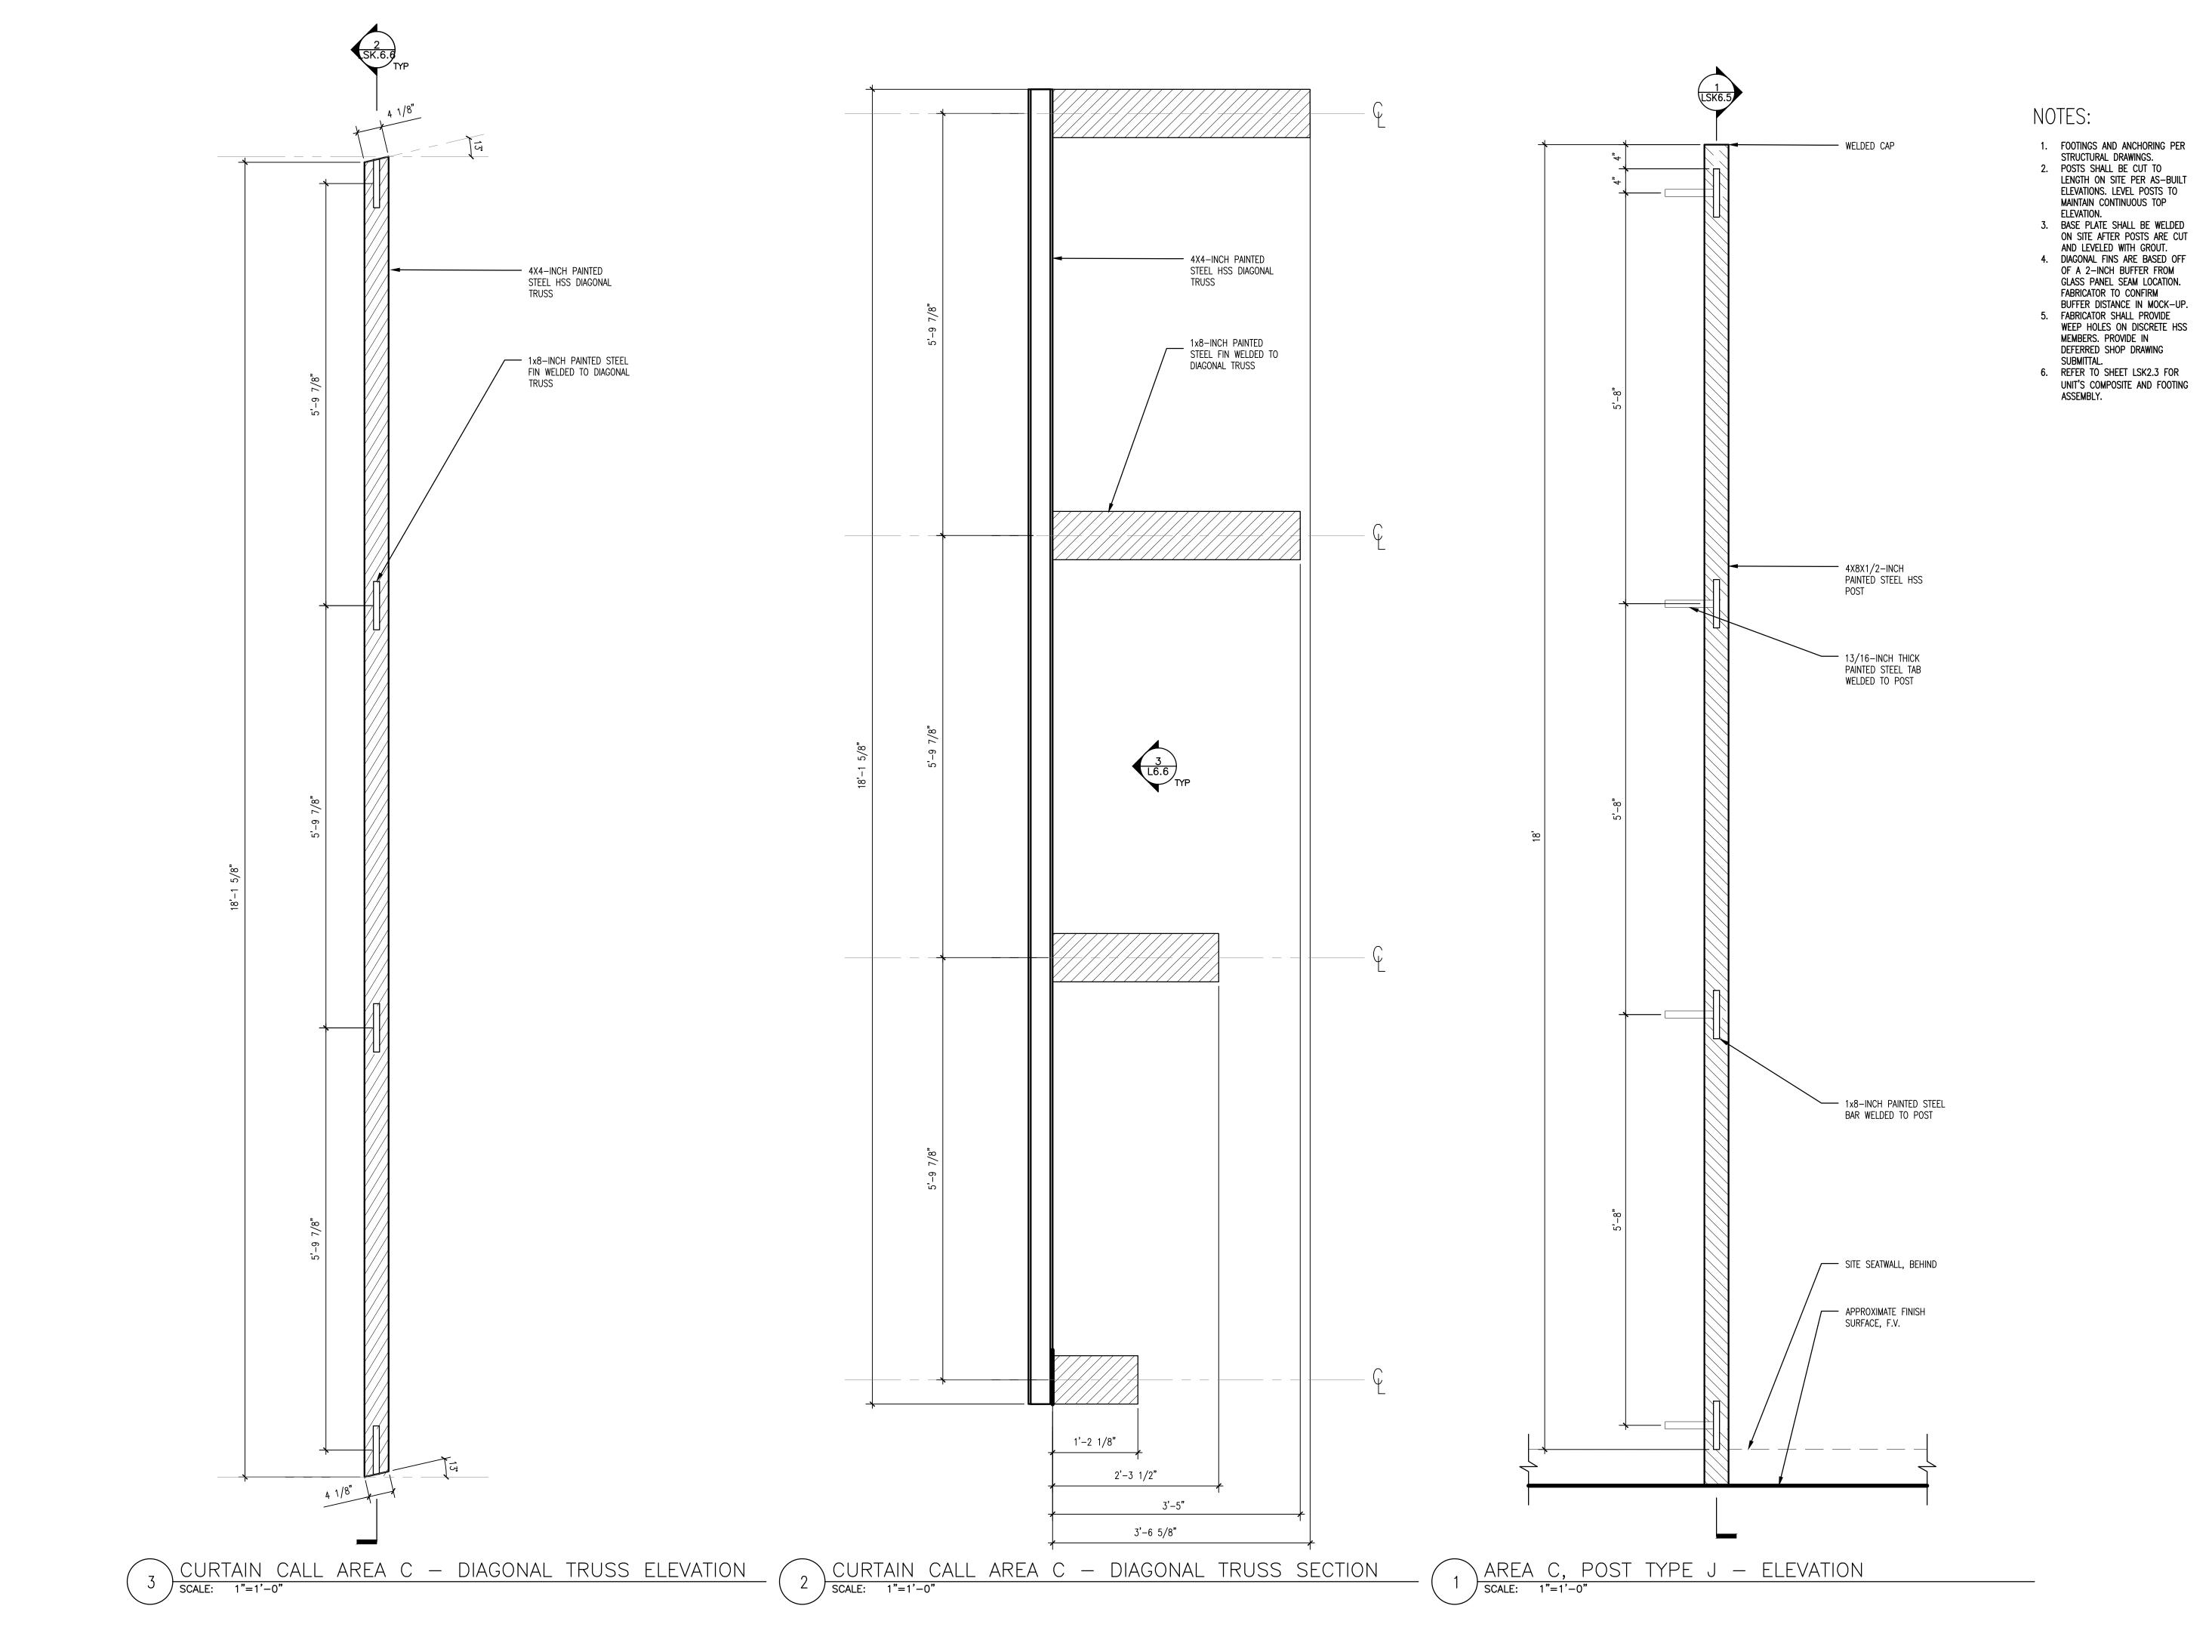
CURTAIN CALL AREA C-FRAMING DETAILS

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CONSULTING ENGINEERS



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CURTAIN CALL AREA C -FRAMING DETAILS

Submission:

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LSK6.6

1. FABRICATOR SHALL SUBMIT SHOP DRAWINGS TO GLASS ENGINEER FOR FINAL REVIEW AND APPROVAL OF GLASS COMPOSITION, SUPPORT SPECIFICATION, AND LAYOUT.



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CURTAIN CALL AREA A -ASSEMBLY AXONS

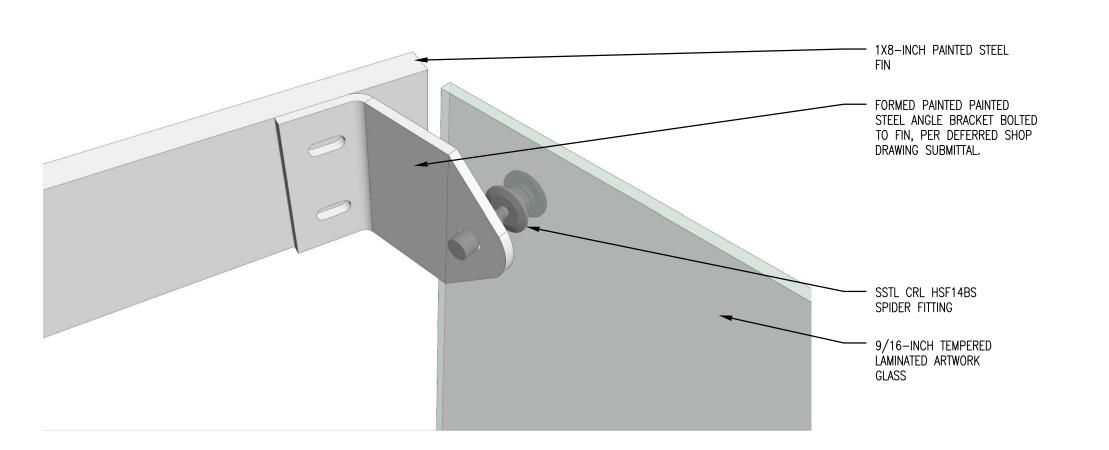
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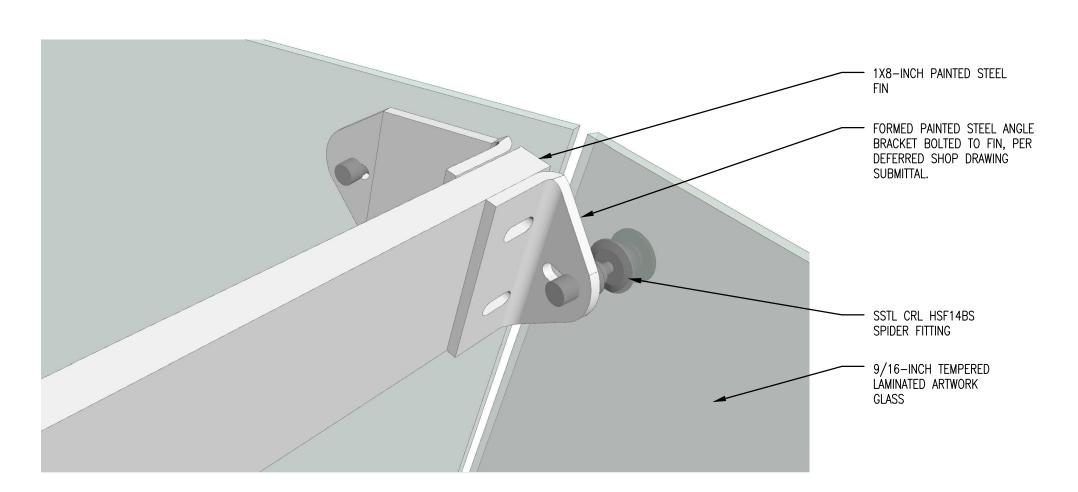
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SSTATE STEEL STEEL




GLASS ATTACHMENT AT SINGLE PANEL EDGE




GLASS ATTACHMENT AT SINGLE PANEL INTERSECTION

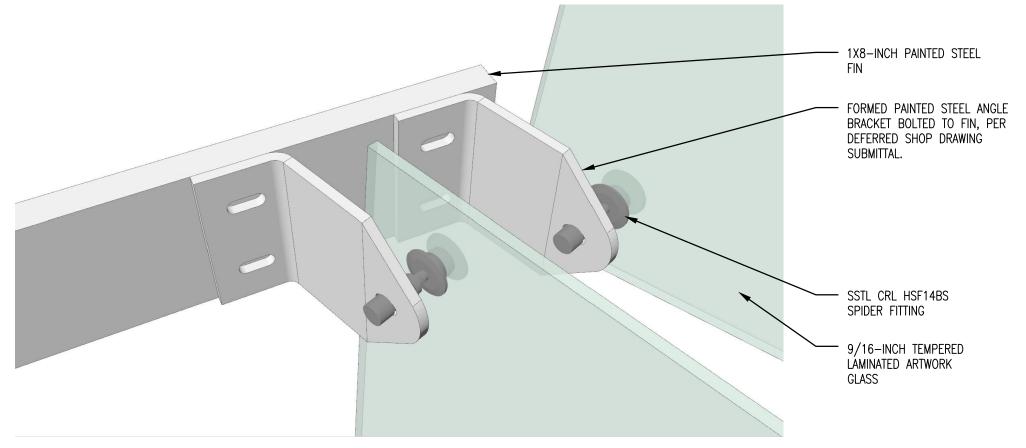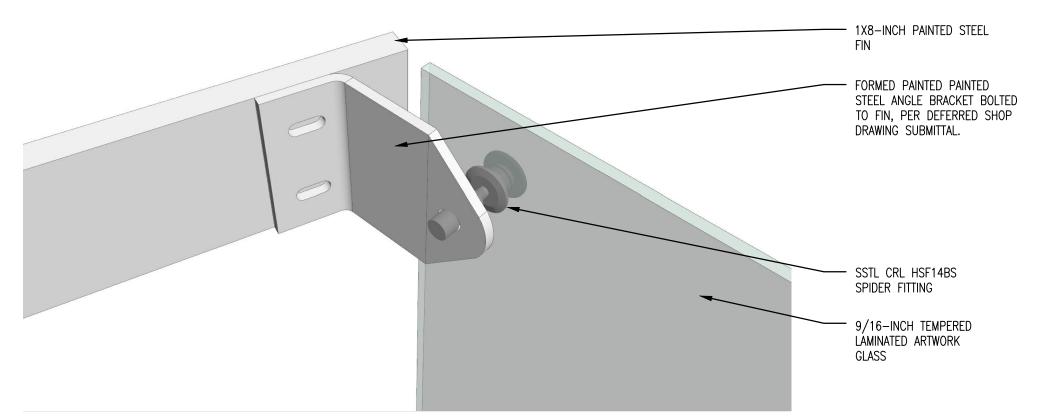3 AREA A — TYPICAL GLASS AND FRAME ASSEMBLY AXON

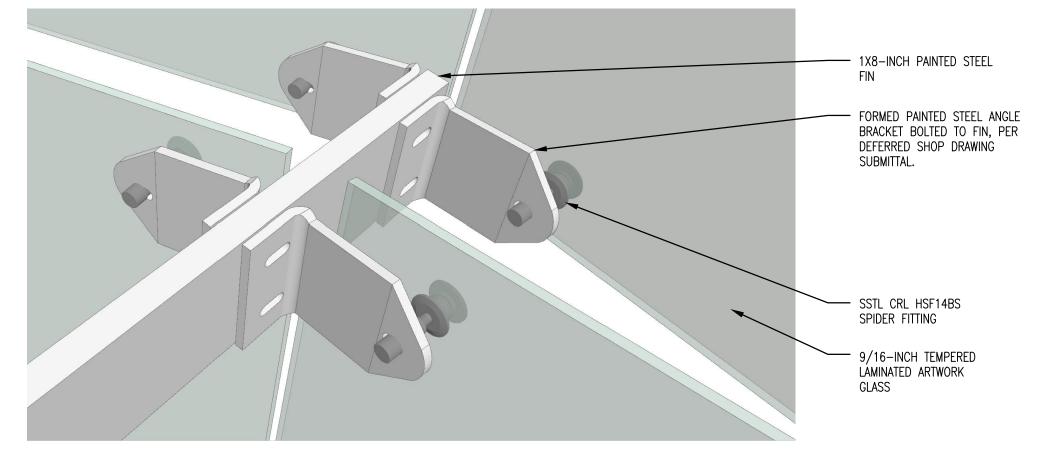
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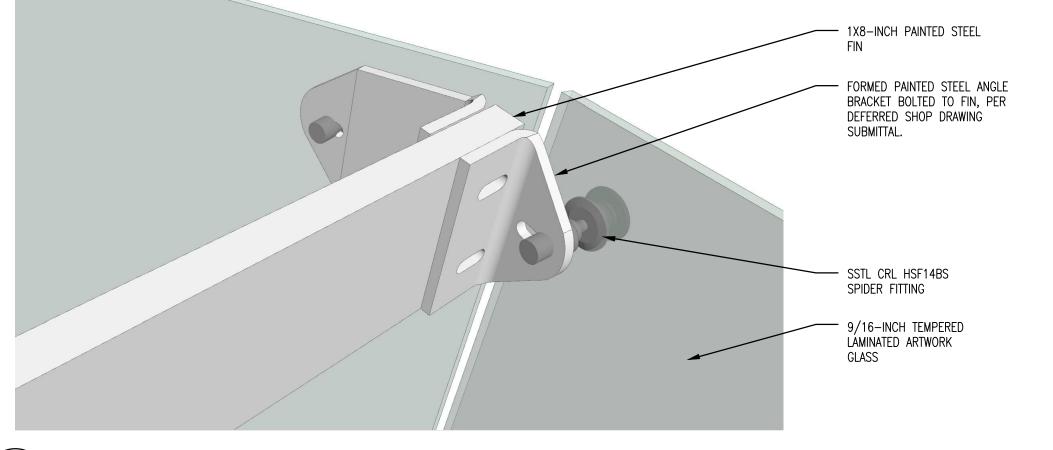
GLASS ATTACHMENT AT DOUBLE PANEL EDGE



GLASS ATTACHMENT AT SINGLE PANEL EDGE



GLASS ATTACHMENT AT DOUBLE PANEL INTERSECTION



4X4-INCH PAINTED

STEEL HSS CROSSBEAM BOLTED TO POST

- 4x8-inch Paitned Steel HSS Post

GLASS ATTACHMENT AT SINGLE PANEL INTERSECTION

NOTES:

1. FABRICATOR SHALL SUBMIT SHOP DRAWINGS TO GLASS ENGINEER FOR FINAL REVIEW AND APPROVAL OF GLASS COMPOSITION, SUPPORT SPECIFICATION, AND LAYOUT.



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CURTAIN CALL AREA B -ASSEMBLY AXONS

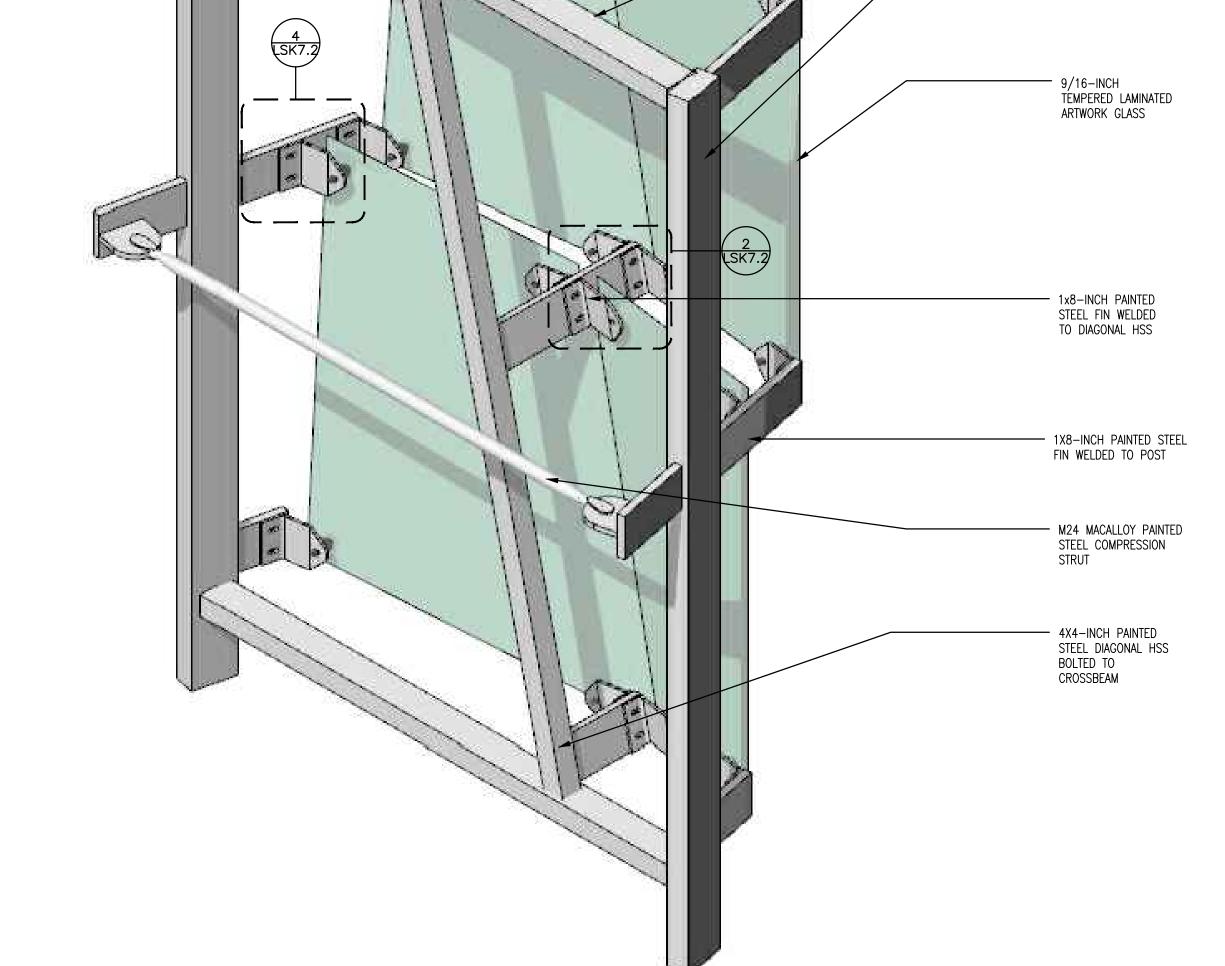
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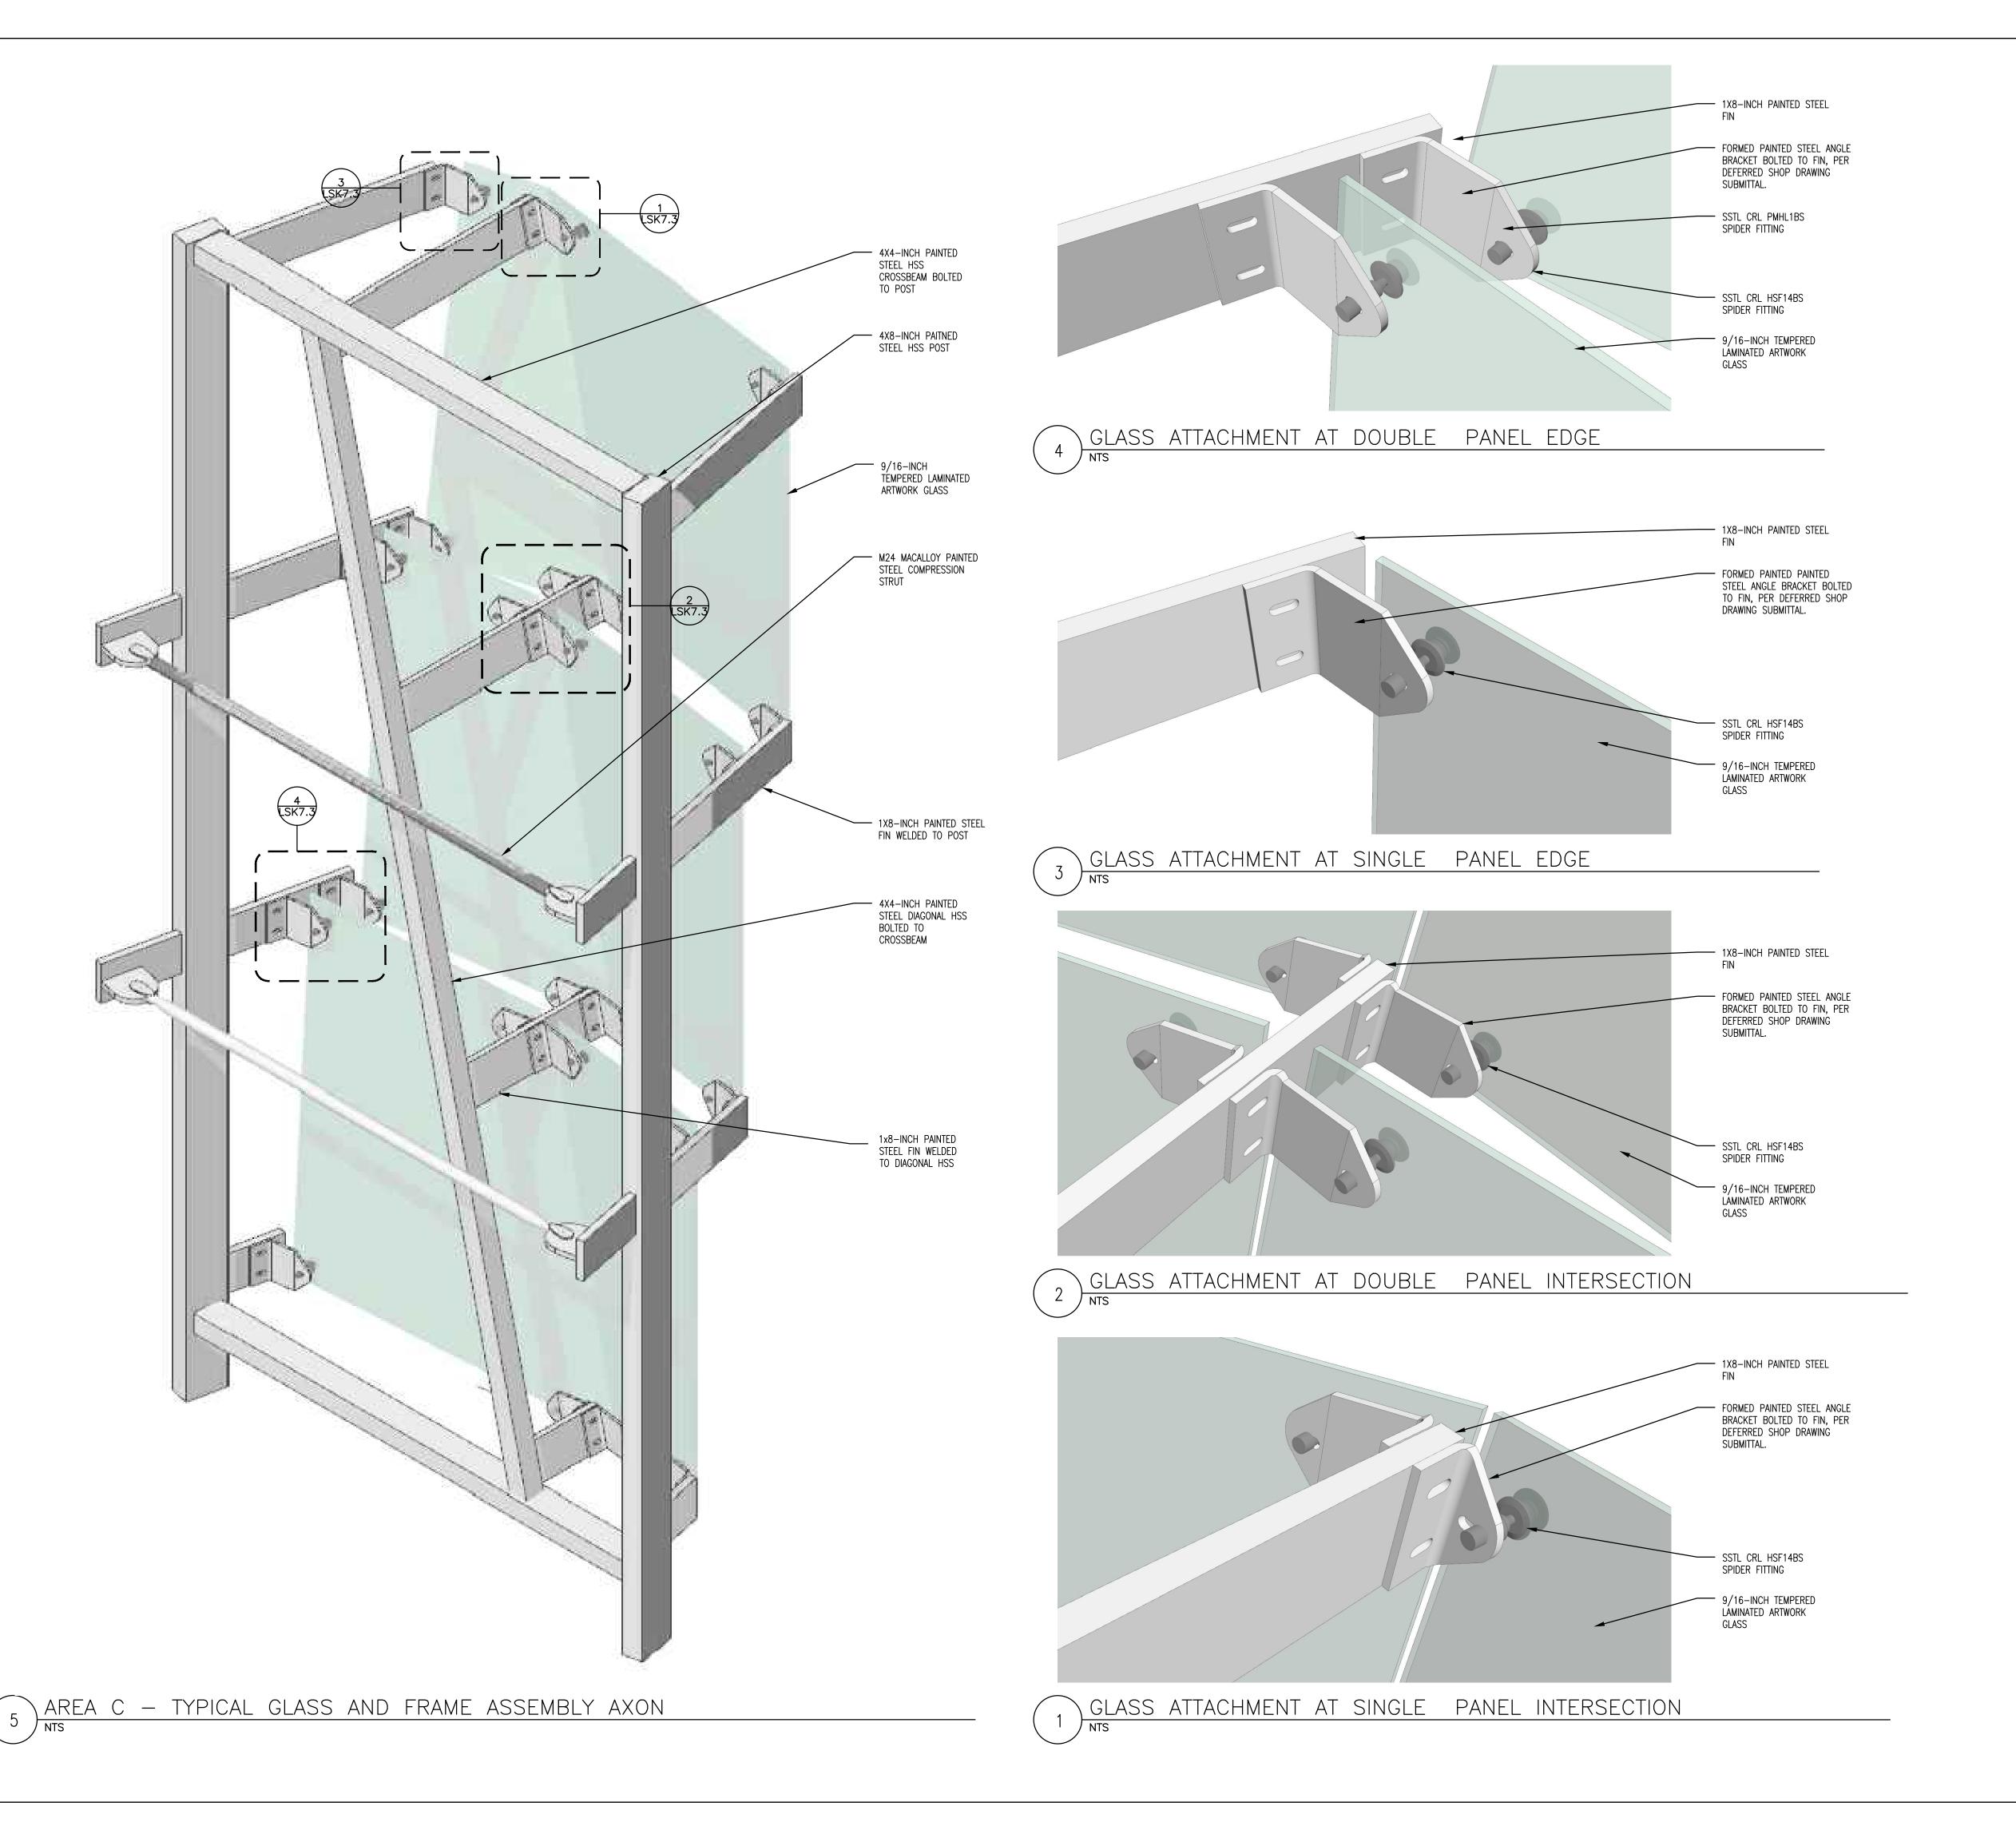
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AREA B - TYPICAL GLASS AND FRAME ASSEMBLY AXON



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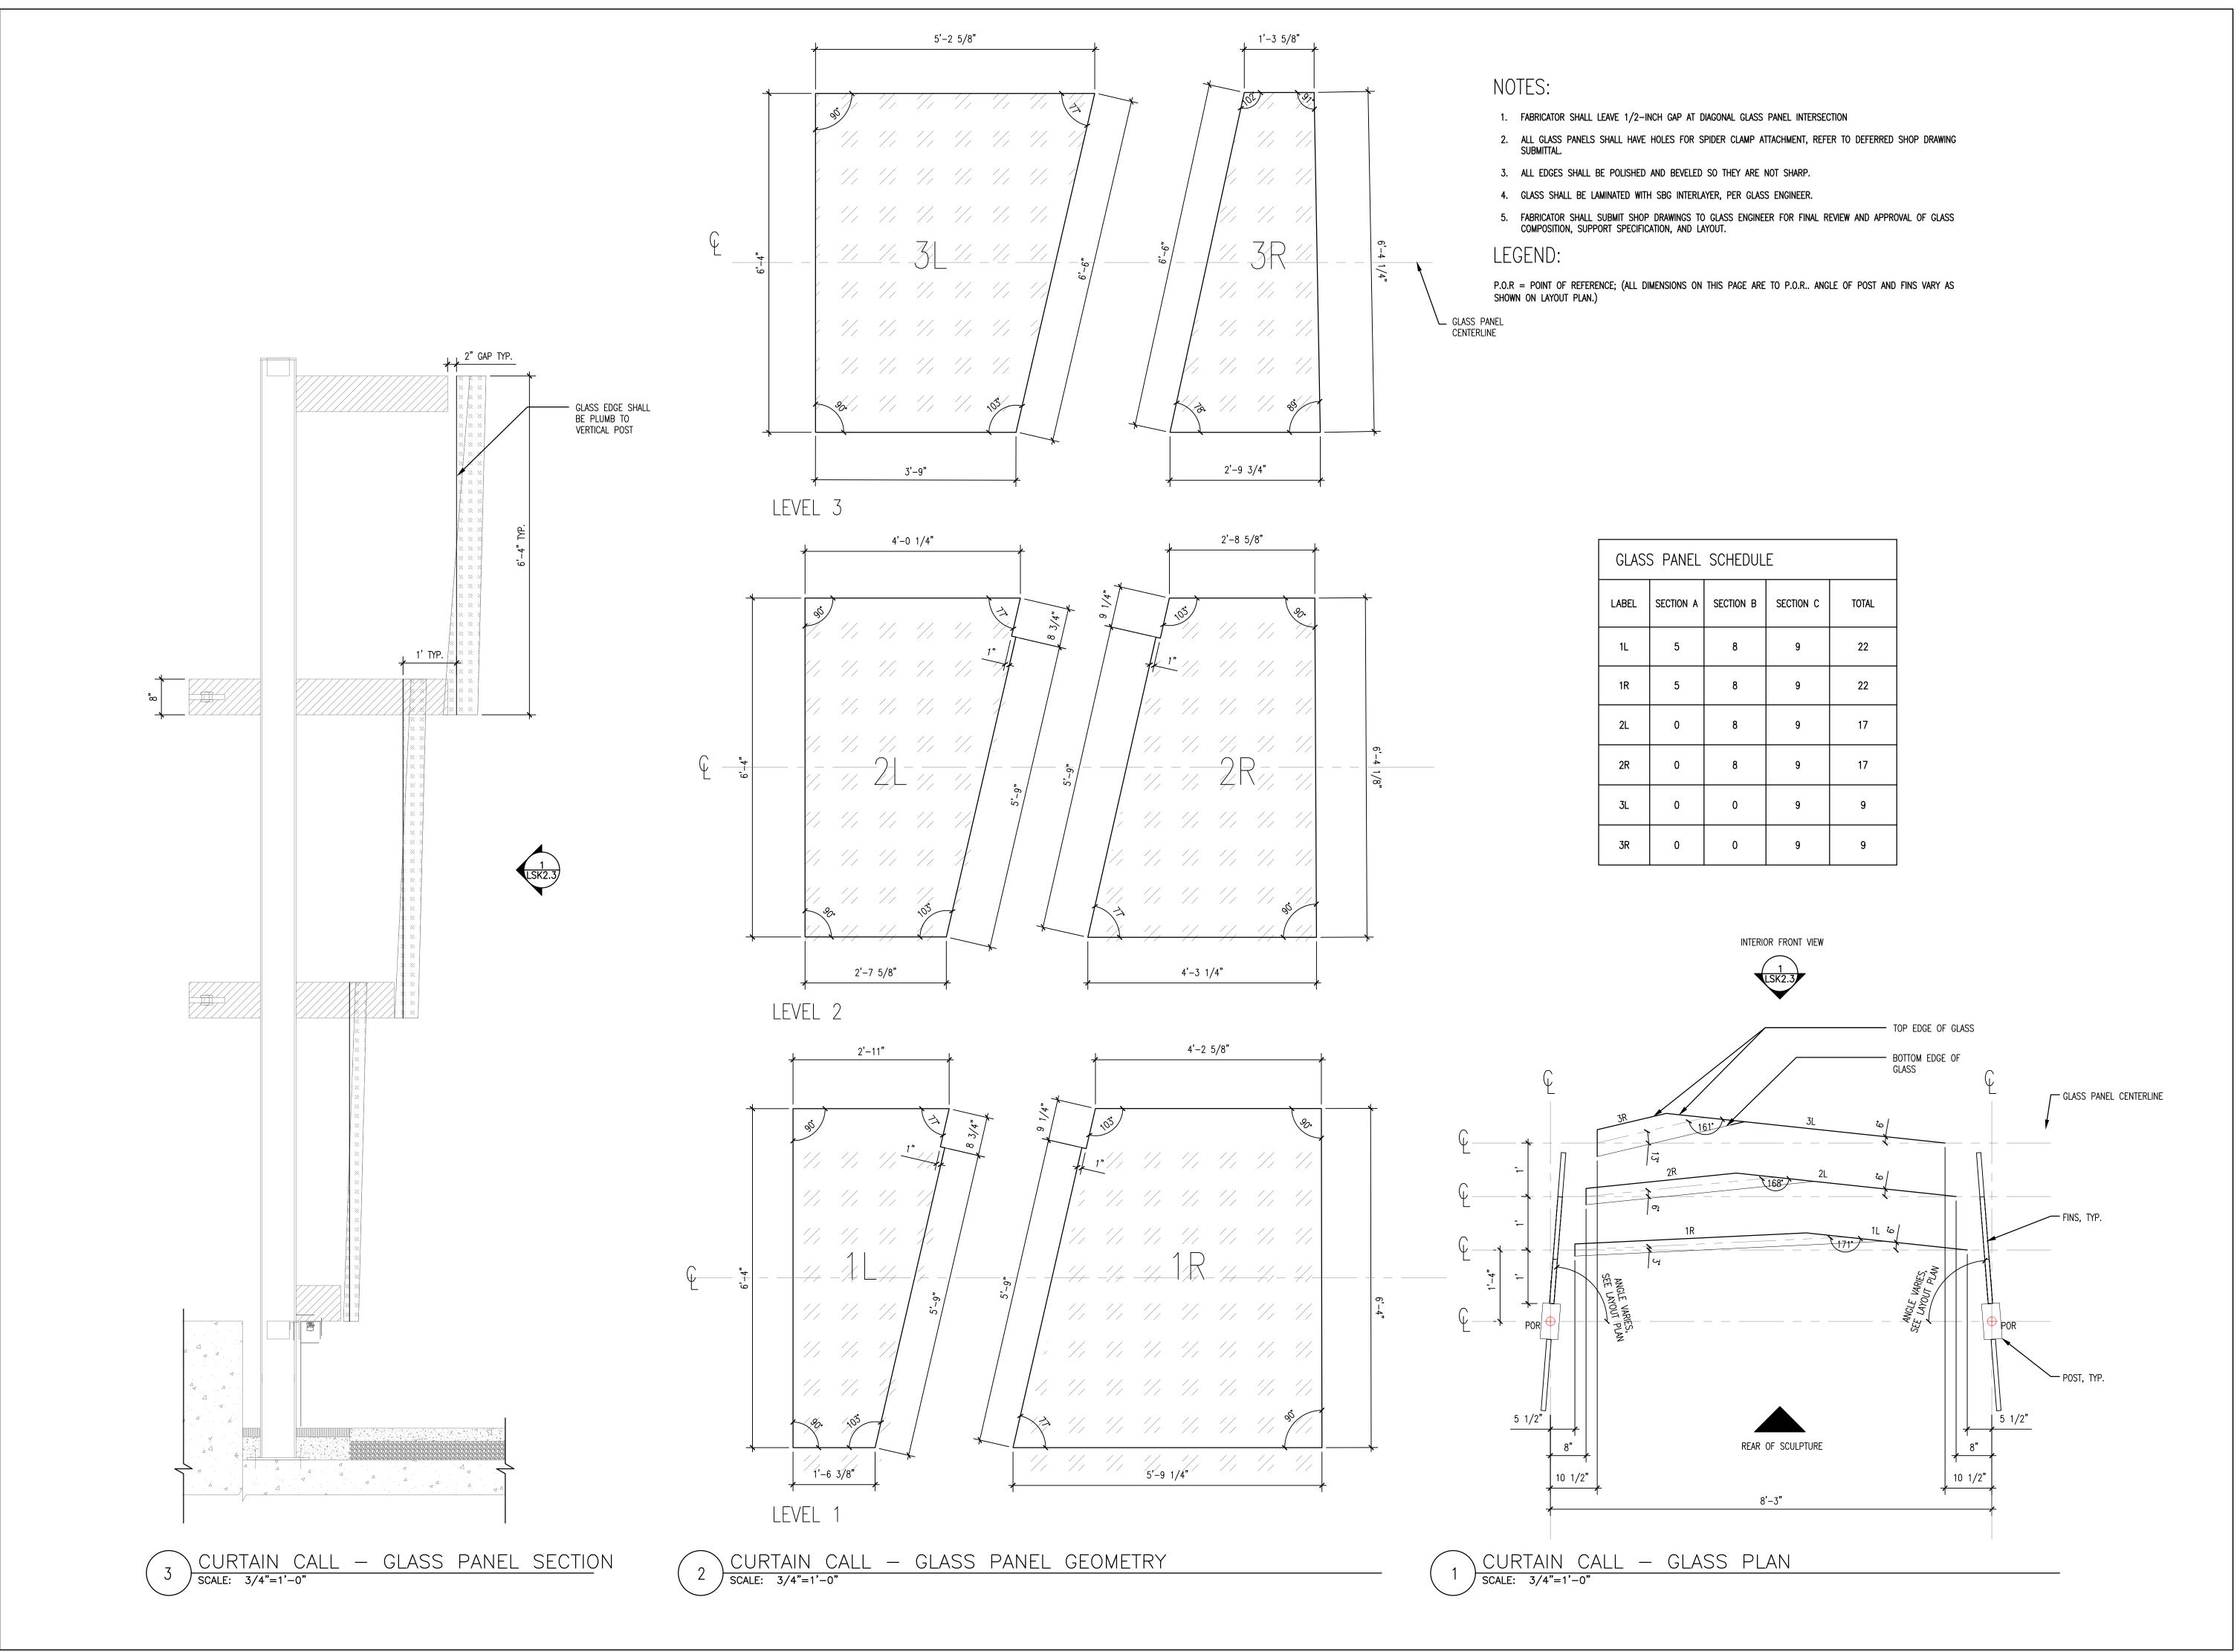
CURTAIN CALL AREA C -ASSEMBLY AXONS

Submission:

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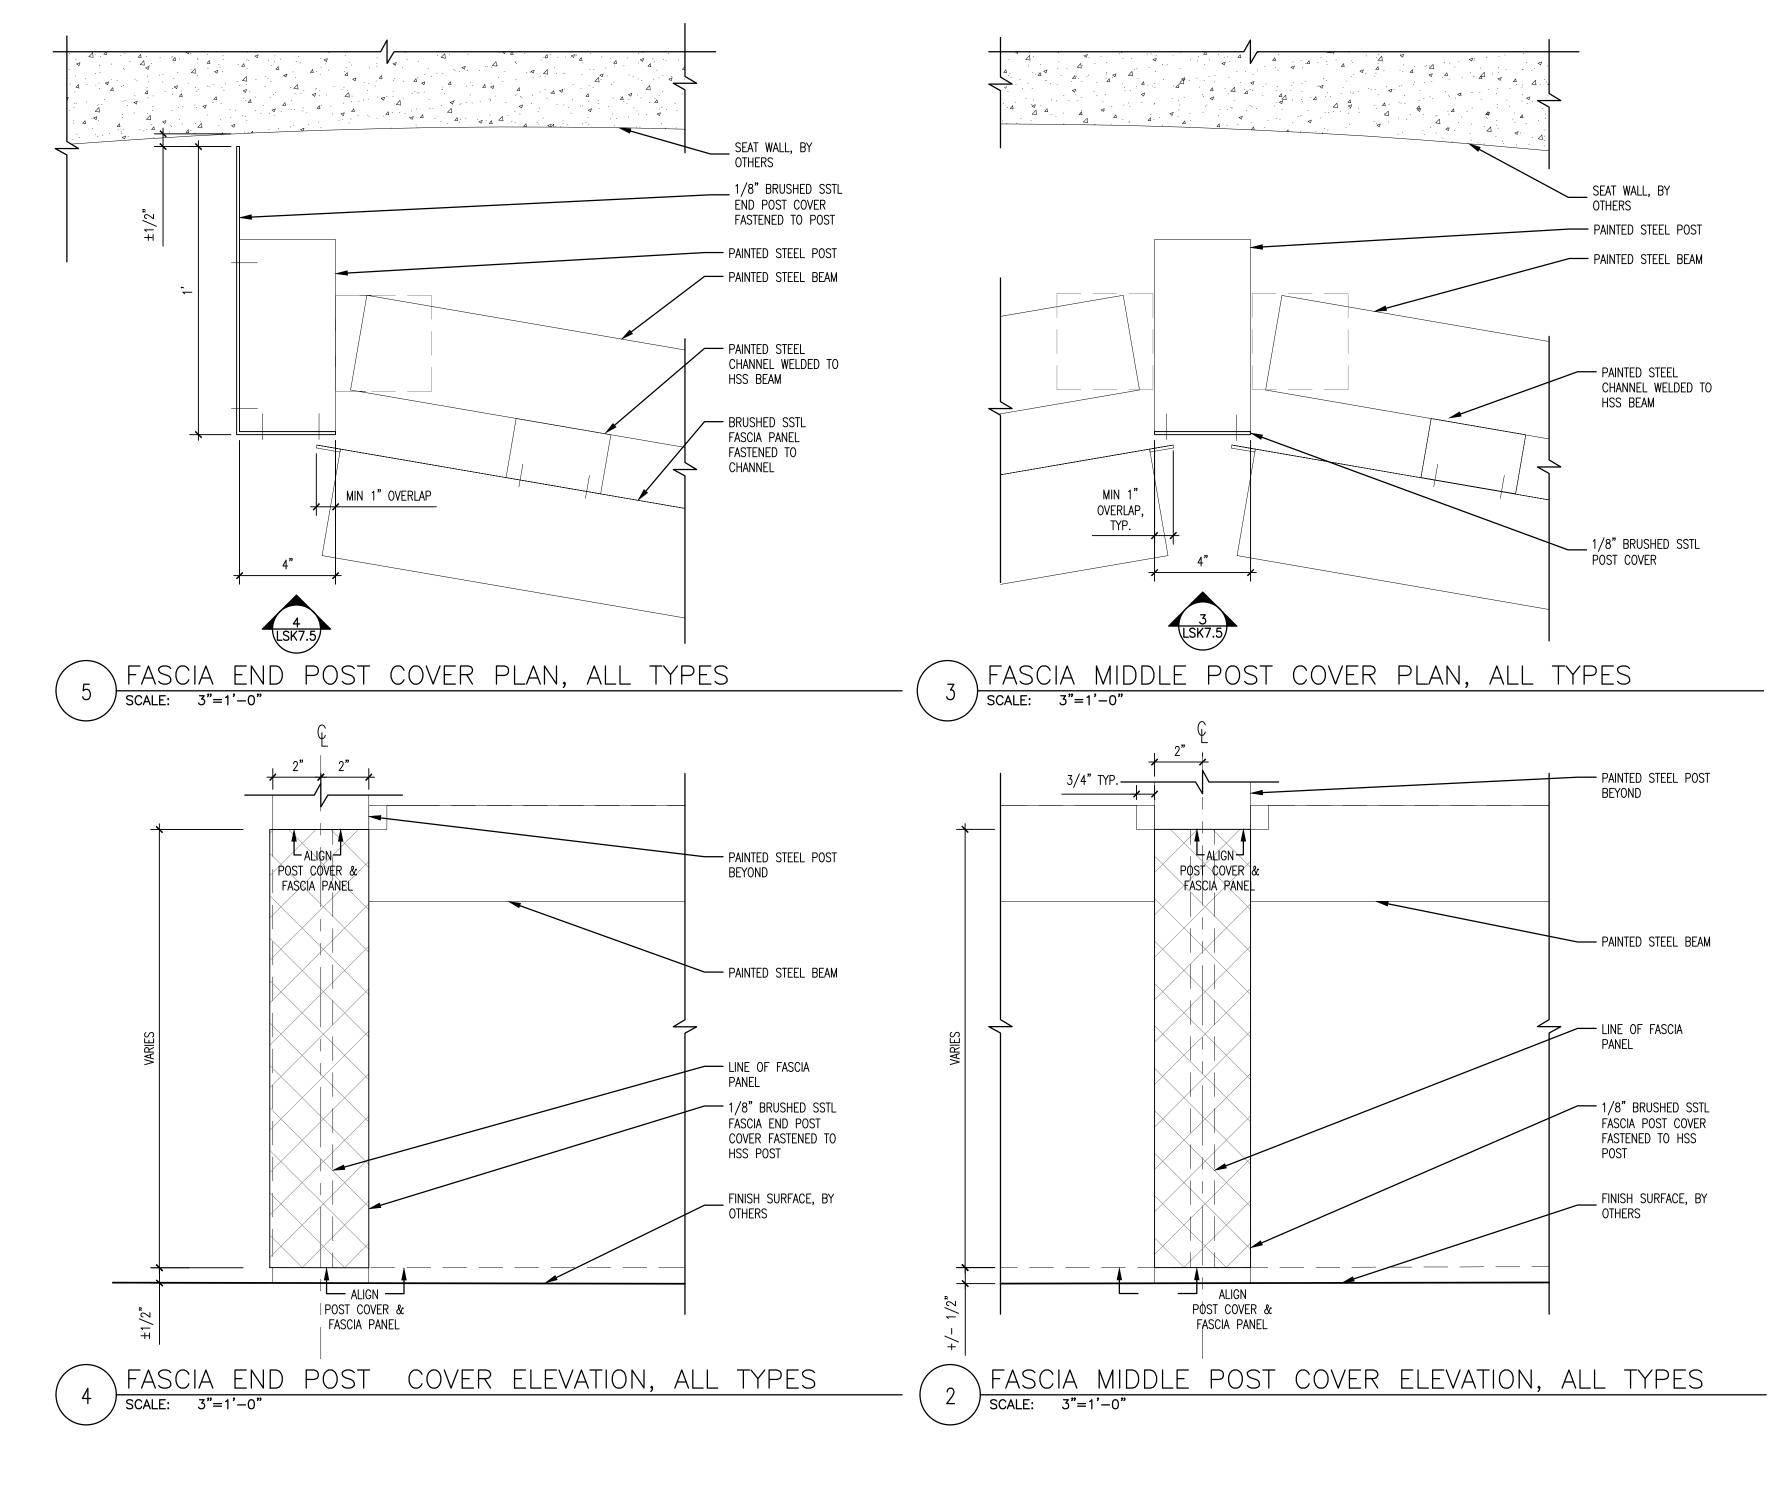
CURTAIN CALL -GLASS DETAILS

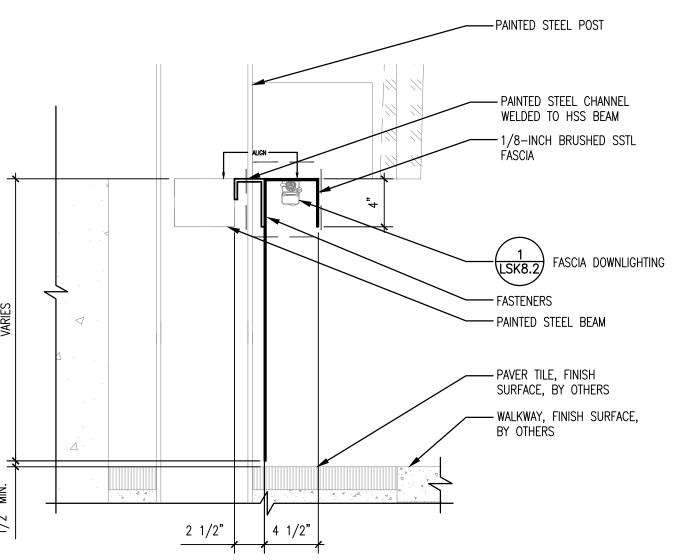
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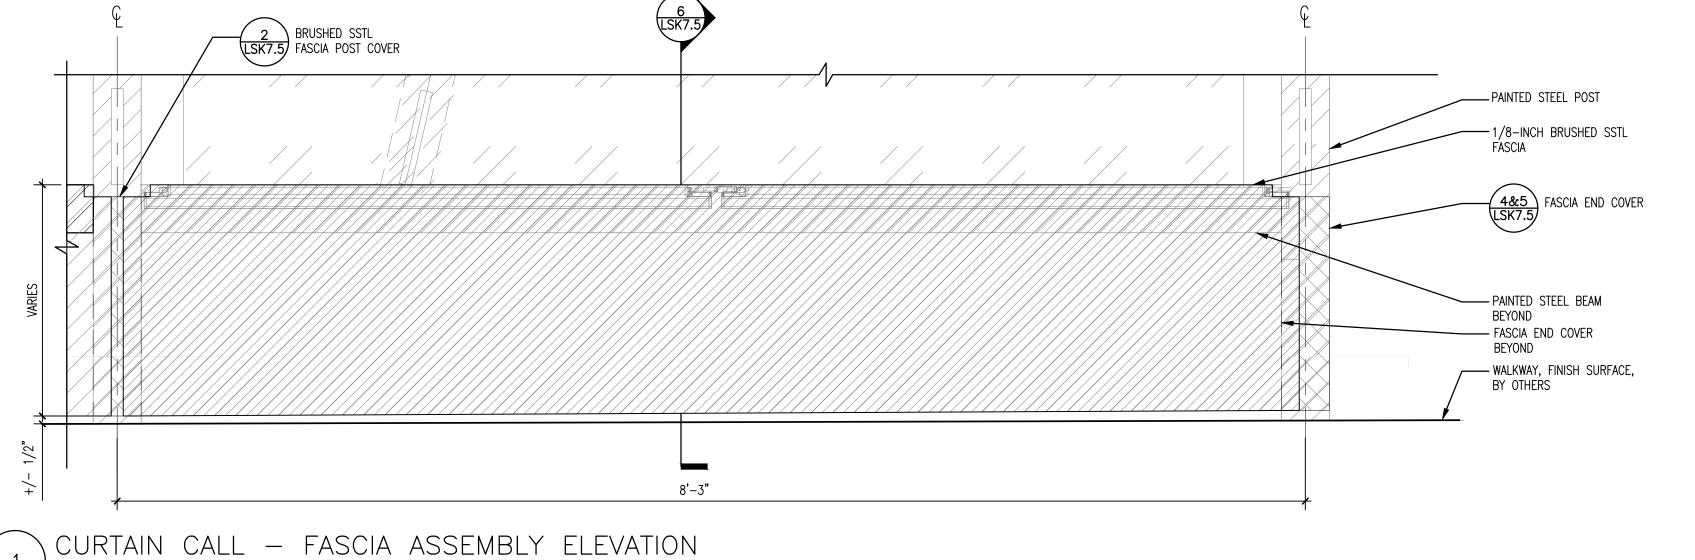
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LSK7.4







6 CURTAIN CALL — FASCIA PANEL SECTION TYPICAL SCALE: 1-1/2"=1'-0"

SCALE: 1-1/2"=1'-0"



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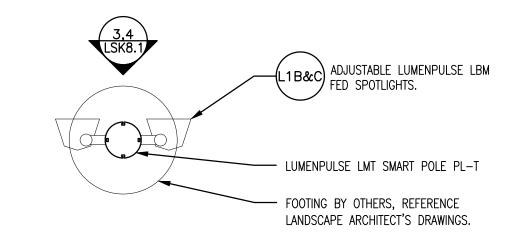
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CURTAIN CALL -FASCIA DETAILS

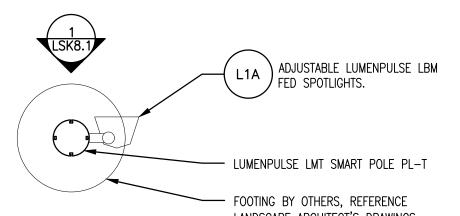
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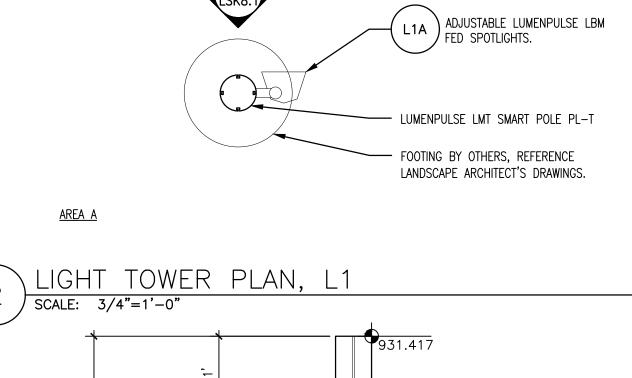
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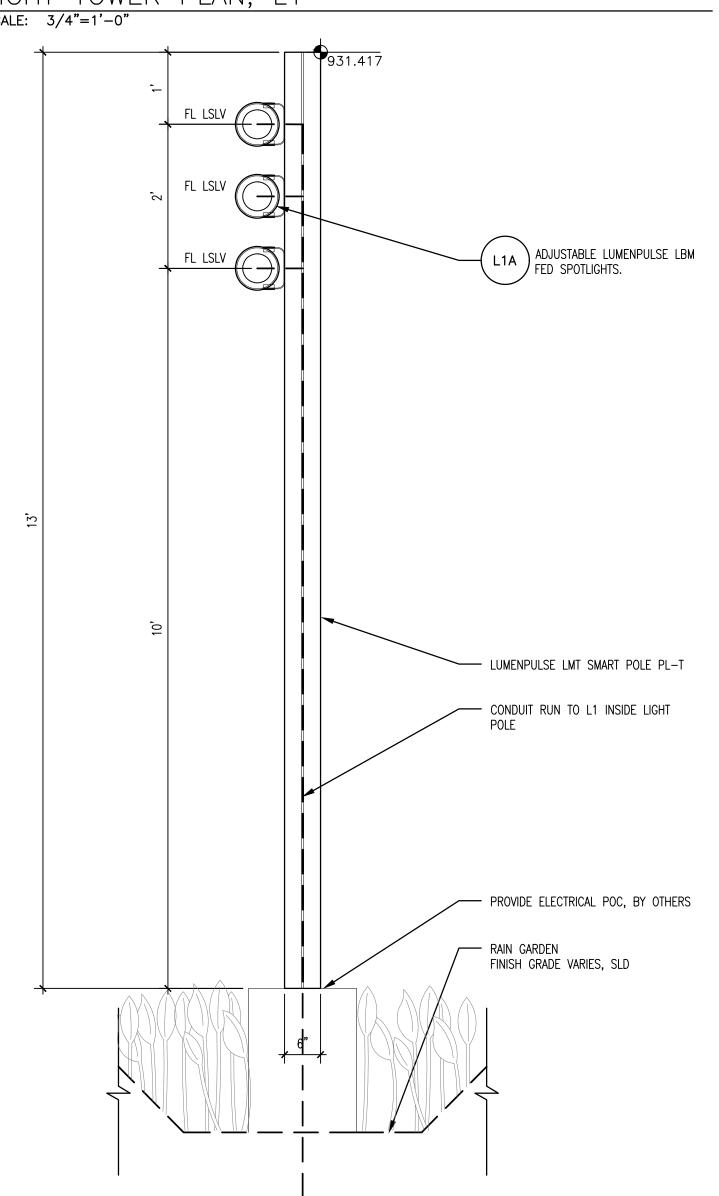


AREAS B AND C





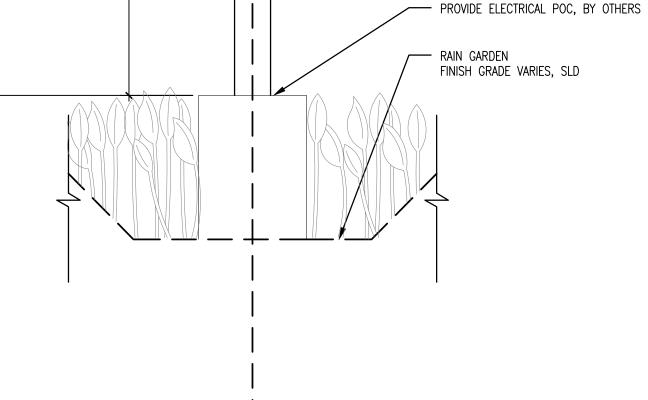
-(L1B) ADJUSTABLE LUMENPULSE LBM FED SPOTLIGHTS.



(L1C) ADJUSTABLE LUMENPULSE LBM FED SPOTLIGHTS. LUMENPULSE LMT SMART POLE PL-T - CONDUIT RUN TO L1 INSIDE LIGHT — PROVIDE ELECTRICAL POC, BY OTHERS - RAIN GARDEN FINISH GRADE VARIES, SLD

AREA C — LIGHT TOWER LEFT ELEVATION, L1

SCALE: 3/4"=1'-0"



— LUMENPULSE LMT SMART POLE PL—T

- CONDUIT RUN TO L1 INSIDE LIGHT

3 AREA B — LIGHT TOWER LEFT ELEVATION, L1 SCALE: 3/4"=1'-0"

AREA A — LIGHT TOWER ELEVATION, L1

SCALE: 3/4"=1'-0"

NOTES:

- FOR REFERENCE ONLY,
 INCORPORATE INTO LAQUATRA BONCI'S ELECTRICAL DRAWINGS FOR FINAL CONSTRUCTION DOCUMENTS.
- 2. ELECTRICAL STUB UP THROUGH CENTER OF FOOTING SHALL BE PROVIDED BY OTHERS.
- 3. COMMUNICATION STUB UP THROUGH CENTER OF FOOTING SHALL BE PROVIDED BY OTHERS.
- 4. FOOTING DESIGN BY OTHERS.
- 5. ELECTRICAL CONTRACTOR SHALL INSTALL ARTWORK LIGHT POLE AND CONNECT ARTWORK LIGHT FIXTURES.
- 6. REFER TO MANUFACTURER SKETCH.
- 7. REFER TO MATERIALS SCHEDULE FOR LIGHT FIXTURE TYPES & QUANTITIES.

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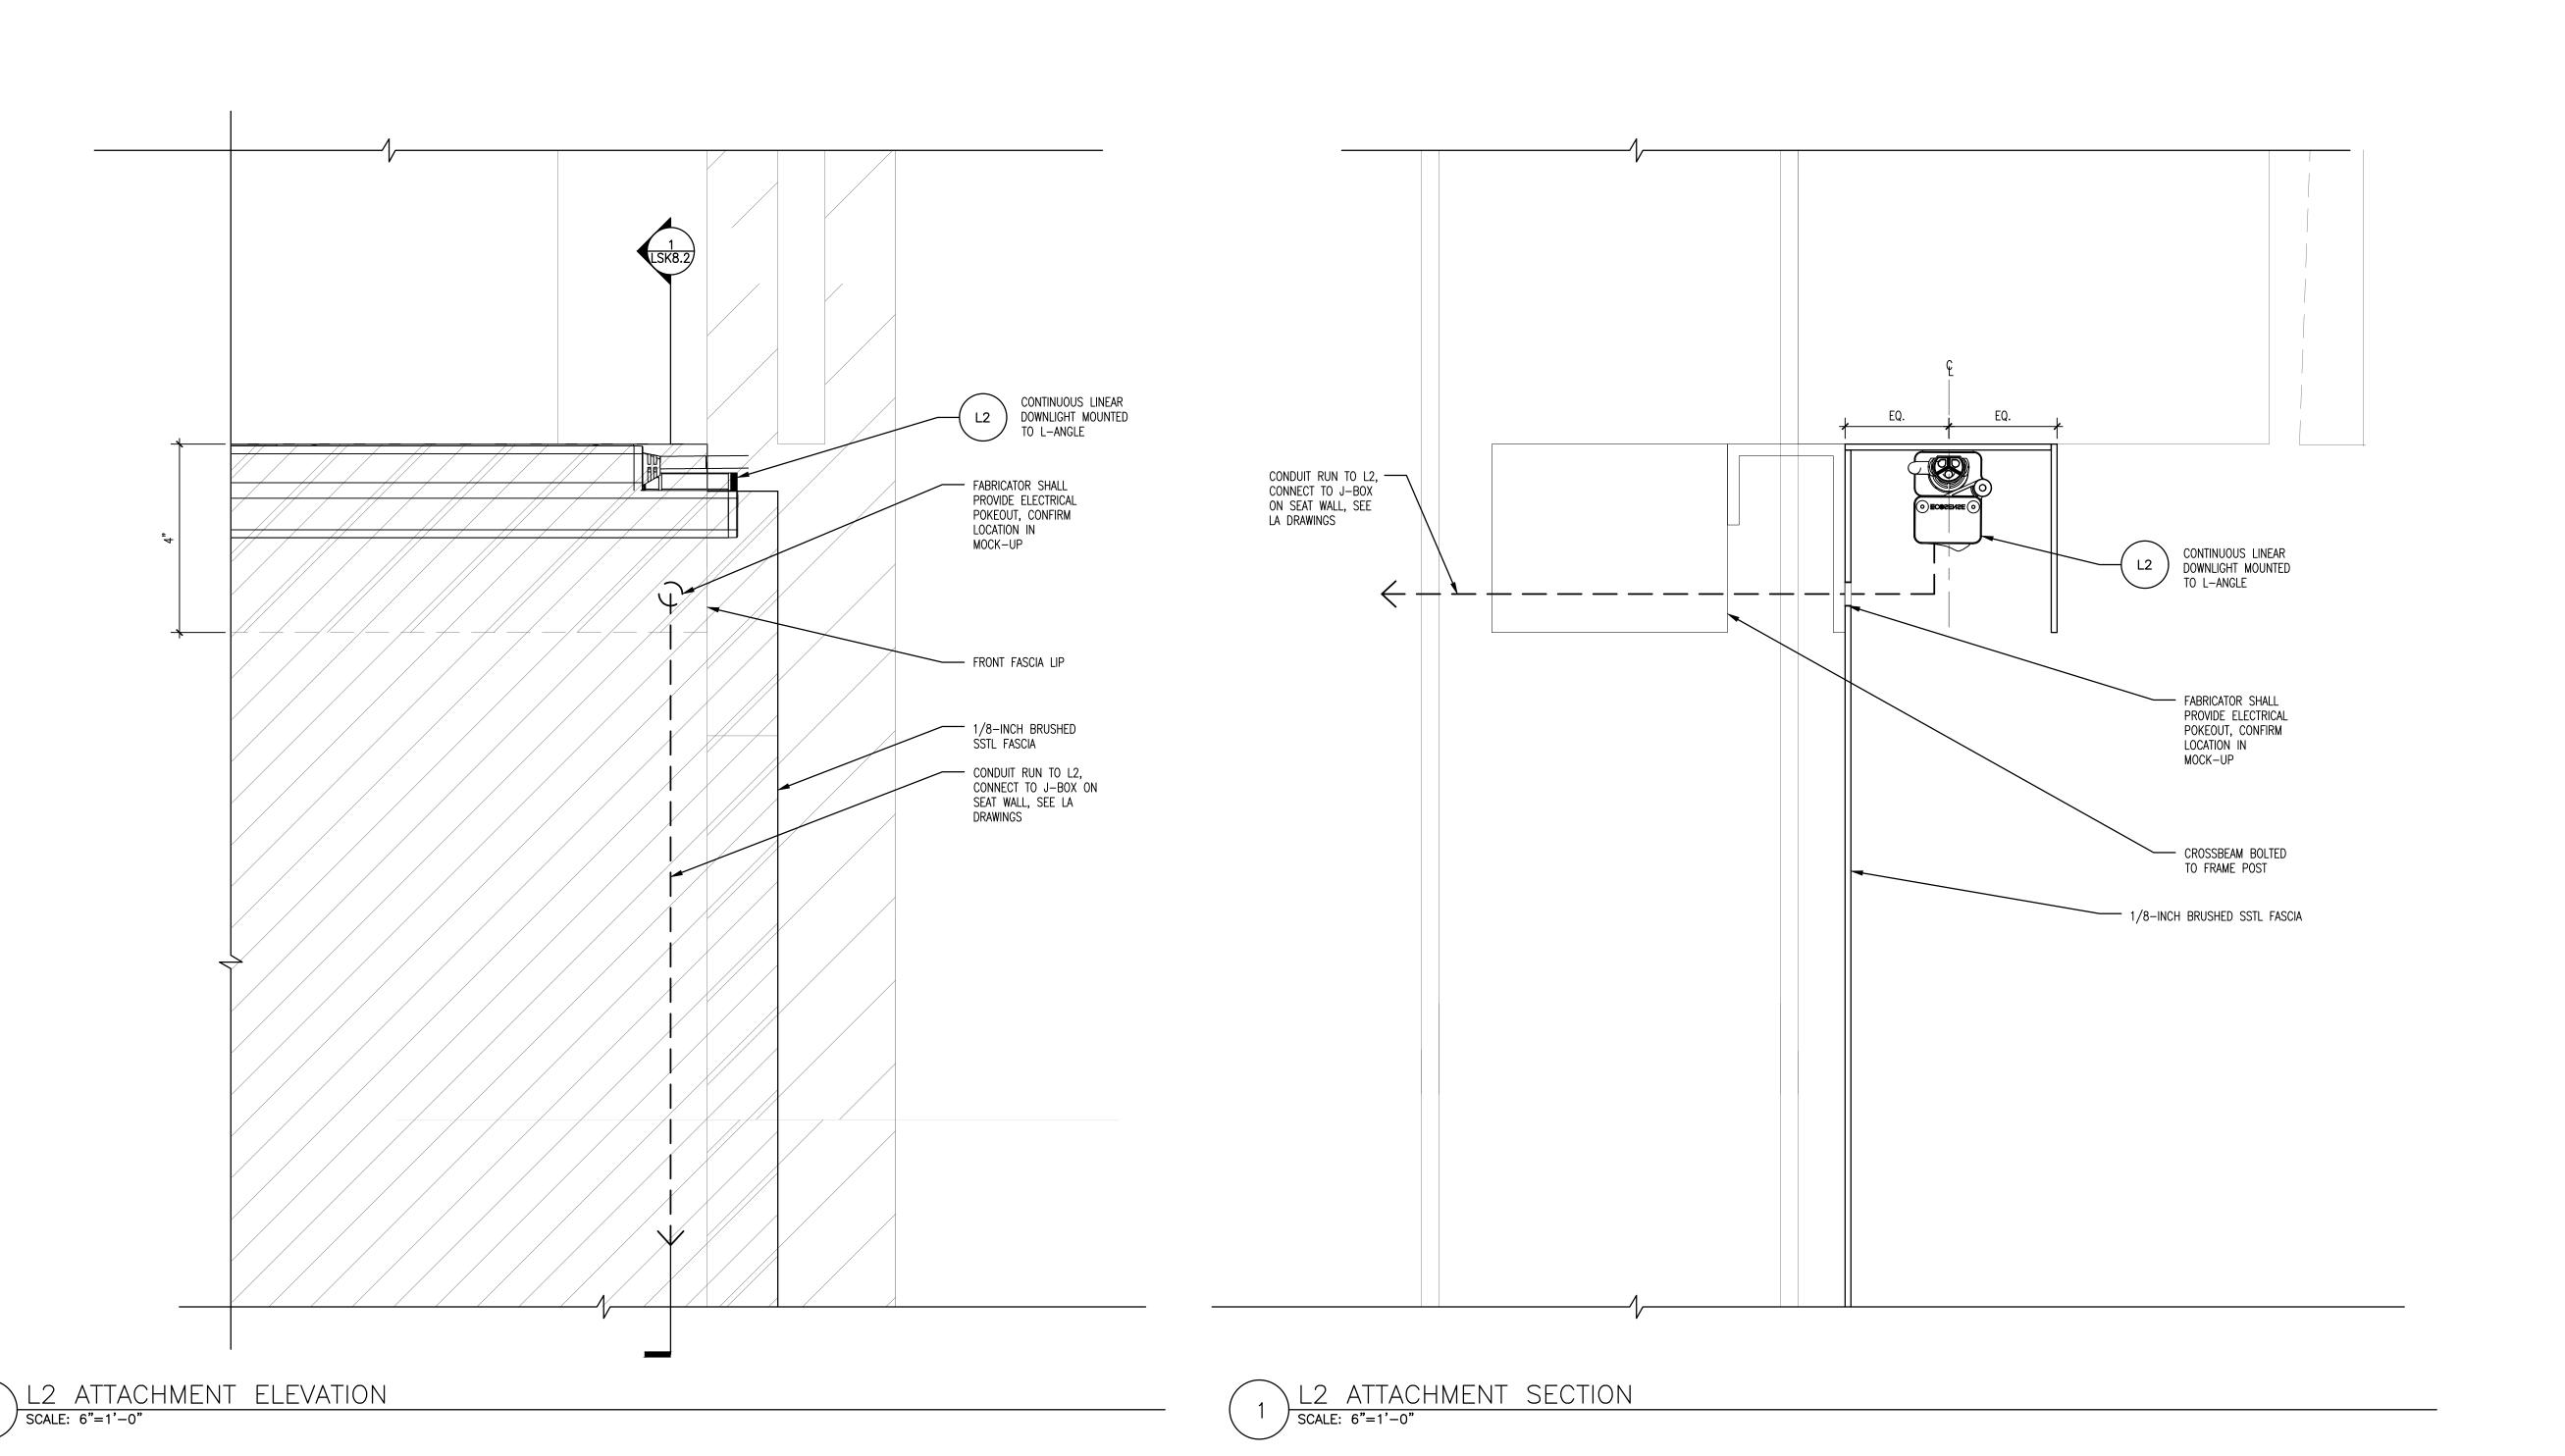
CURTAIN CALL LIGHT TOWER

Submission:

100% Construction Documents

Sheet Number:

- FOR REFERENCE ONLY, INCORPORATE INTO LAOR ELECTRICAL DRAWINGS FOR FINAL CONSTRUCTION DOCUMENTS.
- ELECTRICAL CONTRACTOR SHALL CONNECT ARTWORK LIGHT FIXTURES TO POWER CONNECTION AT ADJACENT J-BOX, SEE LA ELECTRICAL PLAN.
- 3. REFER TO MATERIALS SCHEDULE FOR LIGHT FIXTURE TYPES & QUANTITIES.





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Scale:

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CURTAIN CALL FASCIA LIGHTING

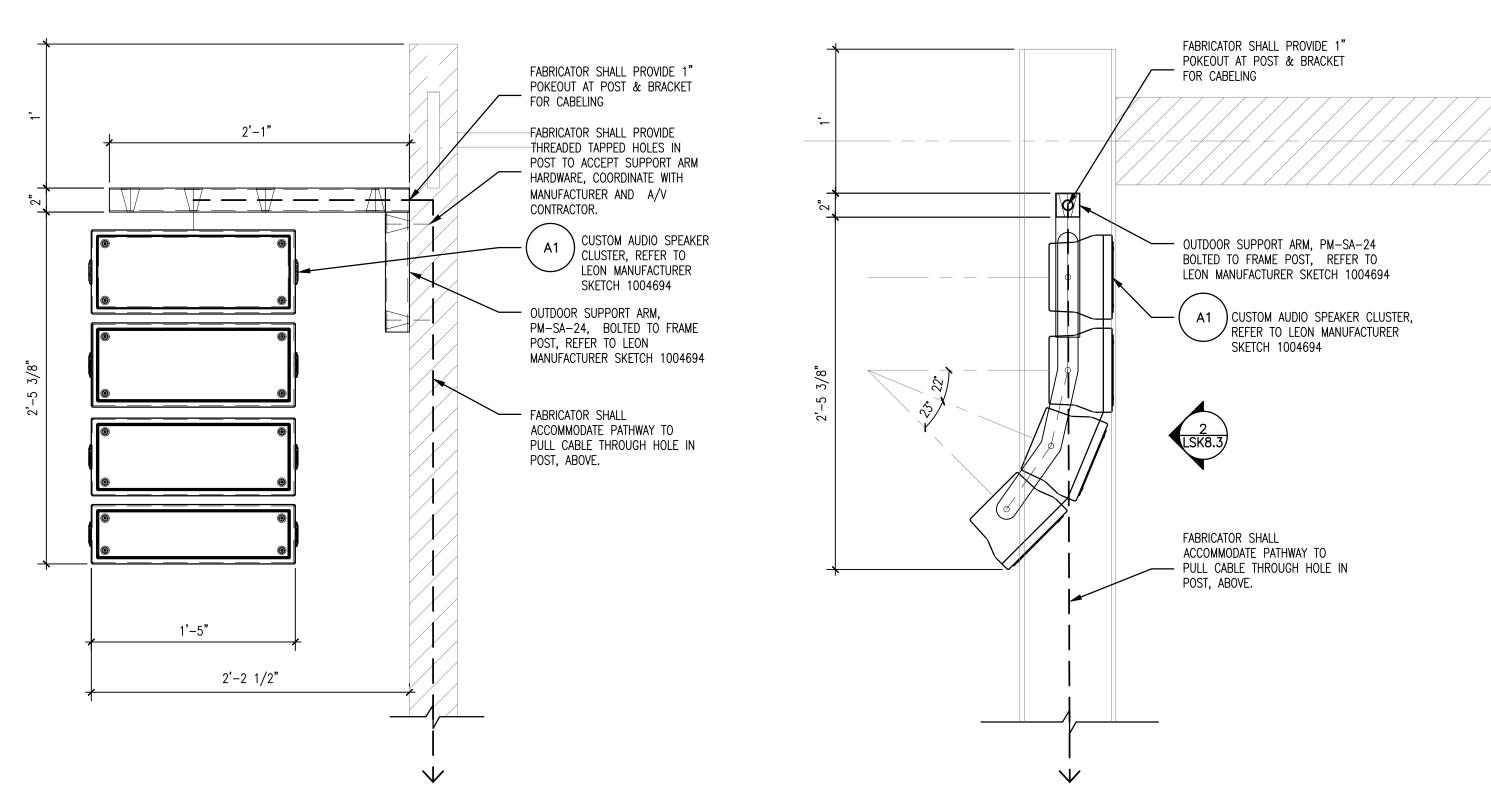
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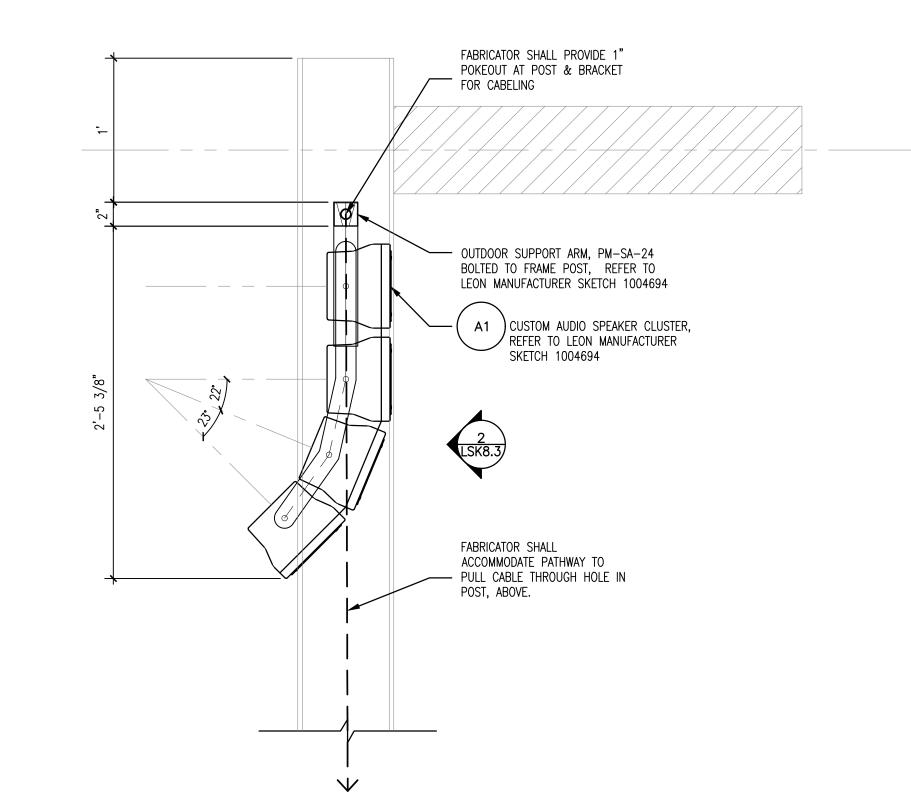
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LSK8.2

- 1. FOR REFERENCE ONLY, INCORPERATE INTO LAQUATRA BONCI'S ELECTRICAL DRAWINGS FOR FINAL CONSTRUCTION DOCUMENTS.
- 2. AUDIO SYSTEM DRAWINGS AND SPECIFICATIONS TO BE PROVIDED A A DEFERRED SUBMITTAL.
- 3. A/V CONTRACTOR SHALL REFER TO AUDIO SYSTEM DRAWINGS AND SPECIFICATIONS TO PROCURE AND INSTALL AUDIO ELECTRONIC COMPONENTS, TERMINATE CABLING, CONFIGURE, TEST AND COMMISSION THE AUDIO SYSTEM.
- 4. REFER TO MATERIALS SCHEDULE FOR LIGHT FIXTURE TYPES & QUANTITIES.





2 SPEAKER ATTACHMENT ELEVATION

SCALE: 1-1/2"=1'-0"

SPEAKER ATTACHMENT LEFT ELEVATION SCALE: 1-1/2"=1'-0"



95 South Tenth Street Pittsburgh, Pennsylvania 15203 www.laquatrabonci.com 412.488.8822



HOOD DESIGN STUDIO, Inc.

3016 FILBERT street studio 2 OAKLAND, CA 94608 510 . 595 0688 www.hooddesignstudio.com







Lower Hill-Curtain Call Pittsburgh, PA

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Drawn by: SS Checked by:

AD

Date: April 28, 2023

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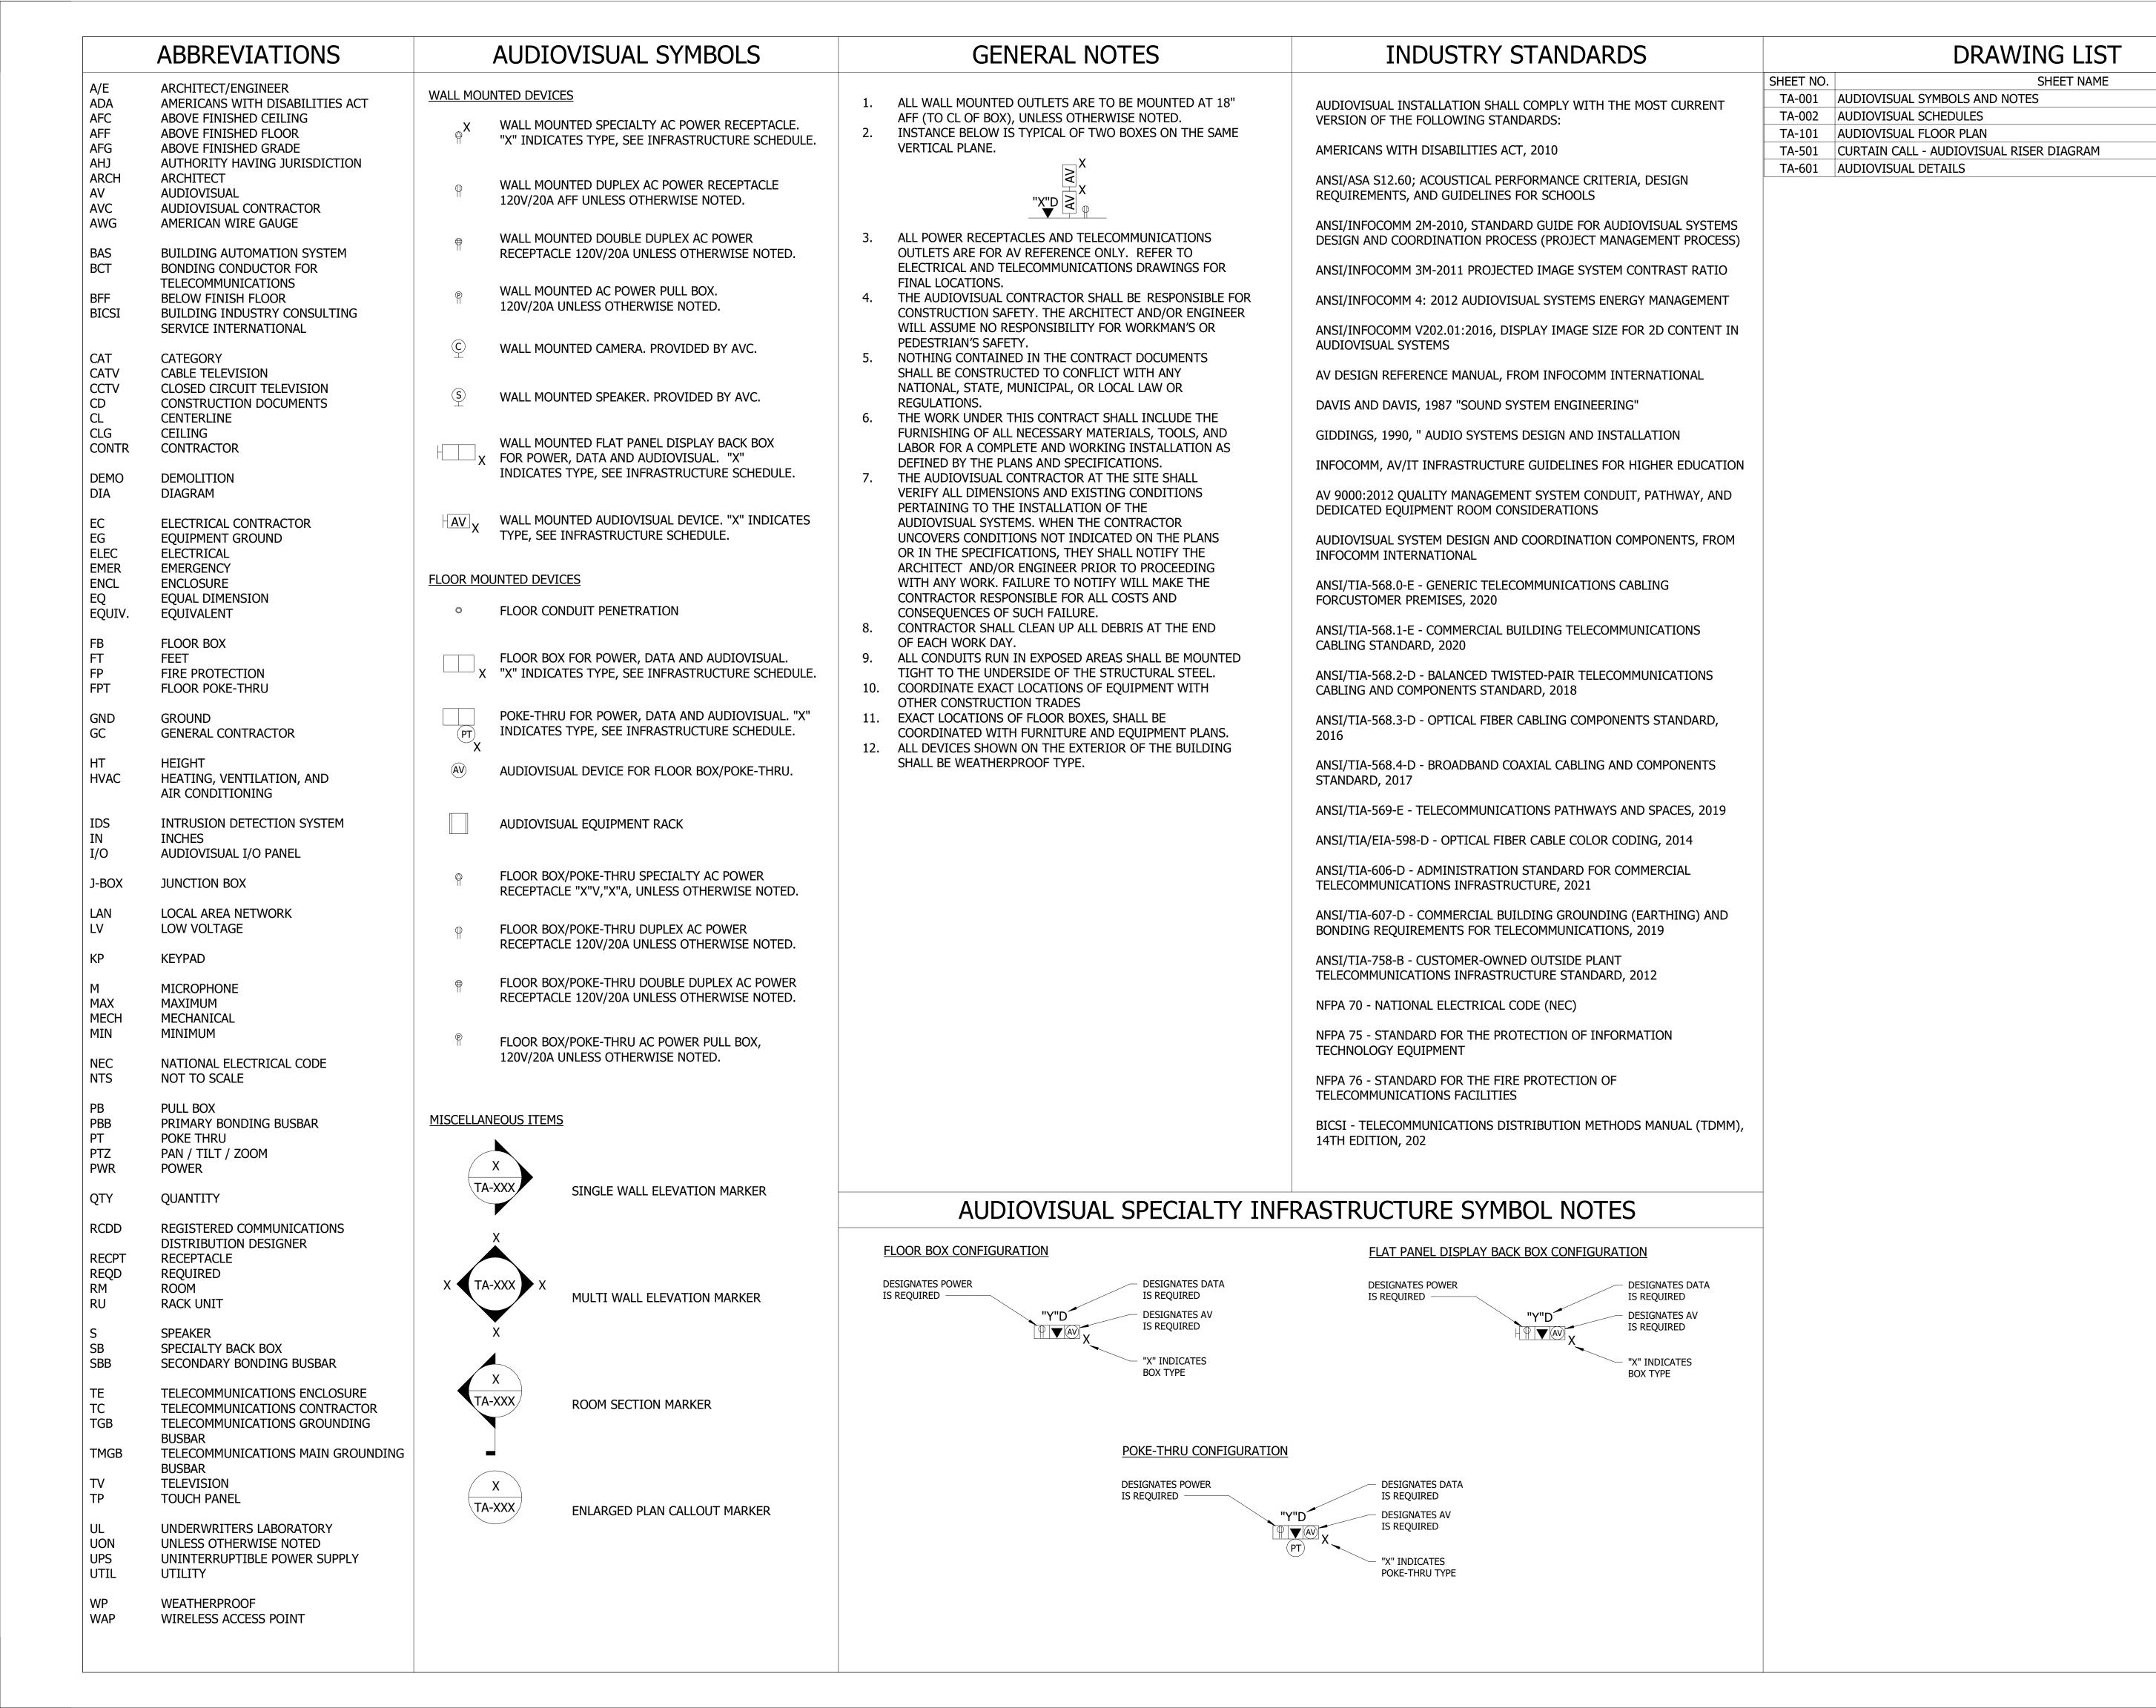
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CURTAIN CALL AUDIO SYSTEM ATTACHMENT

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AUDIOVISUAL SYMBOLS AND NOTES

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INFRASTRUCTURE TYPE SCHEDULE										
TYPE	FUNCTION	MANUFACTURER	MODEL	ENCLOSURE DESCRIPTION	MOUNTING STYLE	POWER REQUIREMENTS	DETAIL			
J1	24 x 24 OUTDOOR NEMA4 TEMP CONTROLLED ENCLOSURE W/ POWER	MIER	BW-124ACHT	NEMA 4 OUTDOOR ENCLOSURE - 2000BTU AC / 150W HEATER	SURFACE MOUNT - 24" ABOVE GRADE	120V/20A (x2) DUAL DUPLEX 5-20R	1/TA-601			
J2	SINGLE GANG NEMA 3R OUTDOOR JUNCTION BOX	HUBBELL/BELL OR EQUIV.	5387-0 OR EQUIV.	MID-SPAN PULL BOX W/COVER	SURFACE MOUNT TO WALL ADJACENT TO POST	-				

INFRASTRUCTURE SCHEDULE NOTES:

- 1. TELECOM OUTLETS THAT ARE SHOWN ON THE AUDIOVISUAL TA-SERIES INFRASTRUCTURE DRAWINGS ARE REPRESENTATIVE OF TELECOM CONNECTIVITY REQUIREMENTS IN SUPPORT OF THE AUDIOVISUAL SYSTEMS. THE LOCATION OF TELECOM OUTLETS ASSOCIATED WITH AUDIOVISUAL EQUIPMENT IN RELATION TO OTHER AUDIOVISUAL INFRASTRUCTURE MAY BE CRITICAL. REFER TO THE STRUCTURED CABLING SYSTEM SPECIFICATIONS AND TT-SERIES DRAWINGS FOR ADDITIONAL INFORMATION.
- 2. TECHNICAL POWER RECEPTACLES, INCLUDING THOSE WITHIN COMPOUND FLOOR BOXES, WALL BOXES, OR CEILING BOXES, ARE PROVIDED BY ELECTRICAL CONTRACTOR AND APPEAR ON THE ELECTRICAL DRAWINGS. THESE TECHNICAL POWER RECEPTACLES ALSO APPEAR ON THE AUDIOVISUAL TA-SERIES INFRASTRUCTURE DRAWINGS FOR COORDINATION AND LOCATION PURPOSES. THE LOCATION OF TECHNICAL POWER RECEPTACLES IN RELATION TO OTHER AUDIOVISUAL INFRASTRUCTURE MAY BE CRITICAL. REFER TO THE ELECTRICAL DRAWINGS FOR COMPLETE POWER LAYOUTS AND CIRCUITING INFORMATION.







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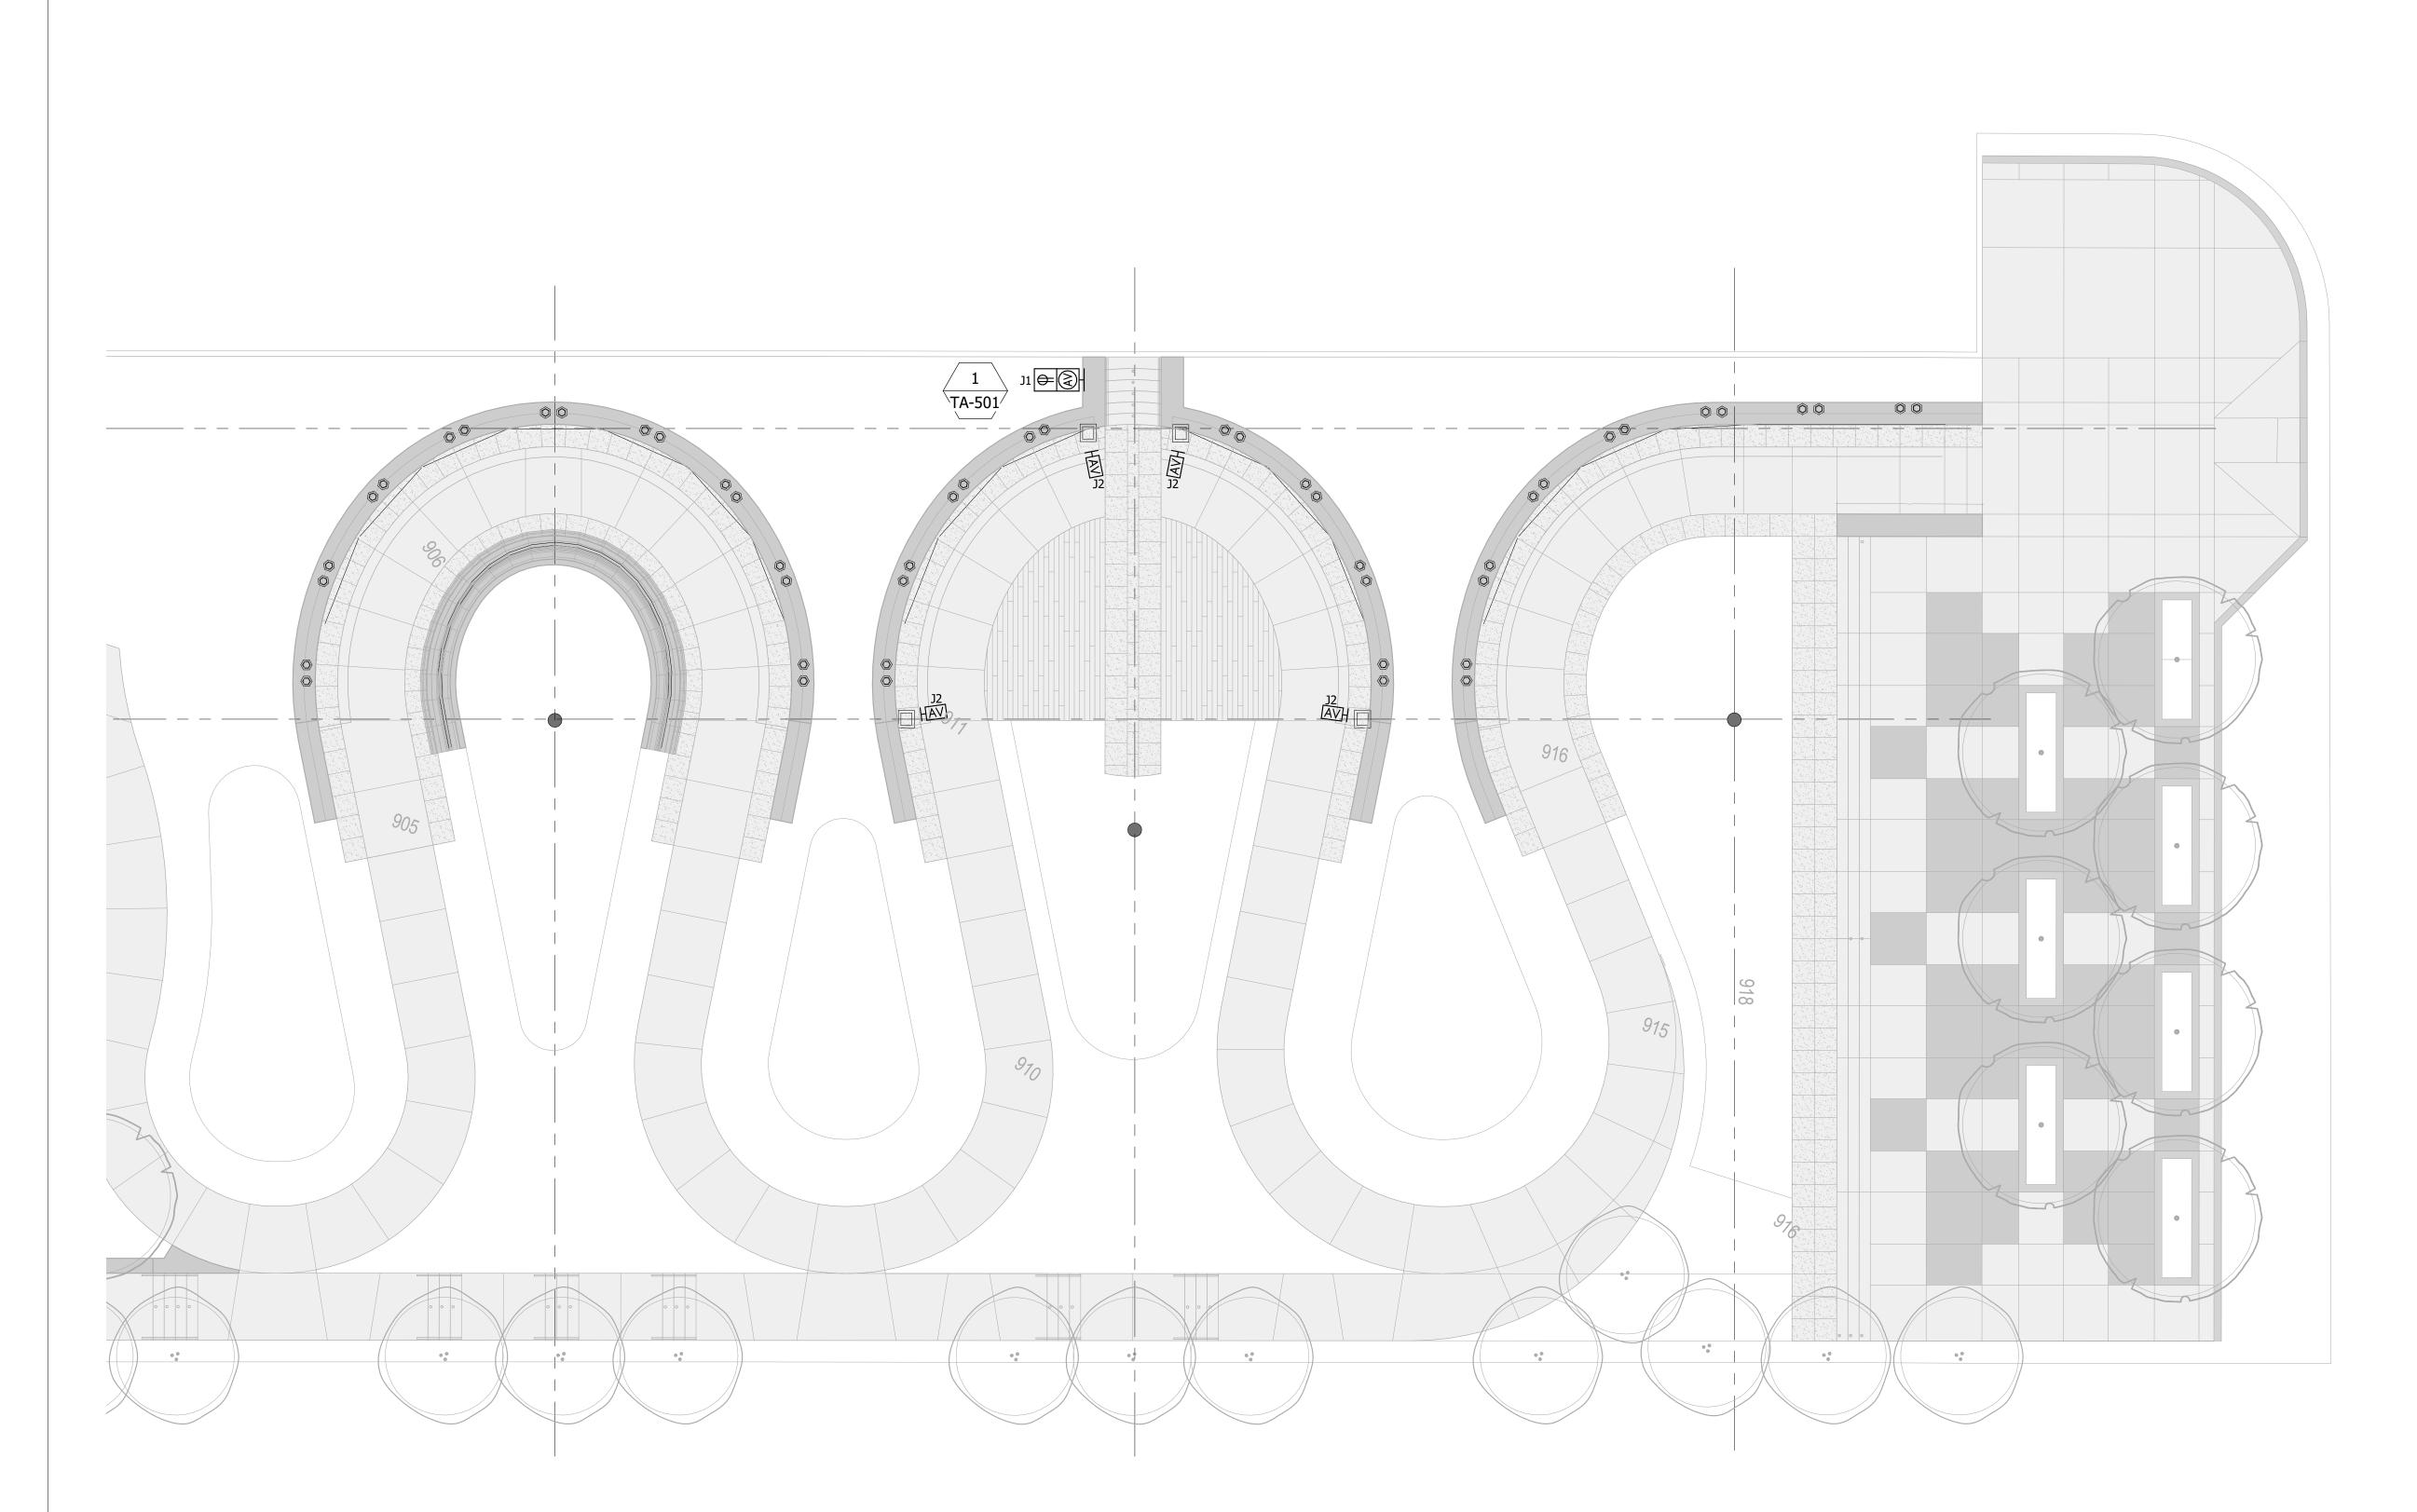
AUDIOVISUAL SCHEDULES

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TA-002



1 Level 1 AV Infrastructure Plan Scale: 1/8" = 1'-0"







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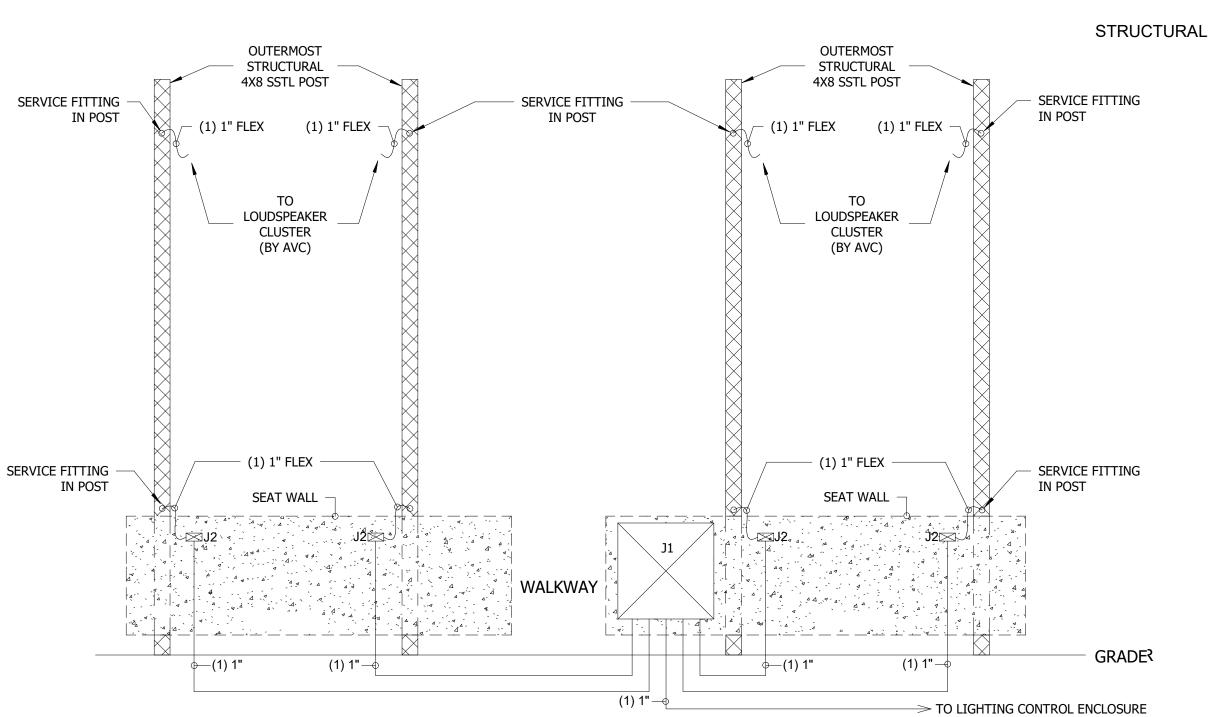
AUDIOVISUAL FLOOR PLAN

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Sheet Number:

ΓA-101



J1 BOX MOUNTED TO EXTERIOR SIDE OF SEAT WALL. SEE PLANS FOR LOCATION.
 J2 BOXES MOUNTED TO INTERIOR SIDE OF SEAT WALL. SEE PLANS FOR LOCATION.

1 RISER DIAGRAM - CURTAIN CALL AREA B Scale: 1/2" = 1'-0"







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Detail

1/TA-601

DESCRIPTION

1. ALL CONDUIT RUNS SHALL BE STEEL, THIN-WALL ELECTRICAL METALLIC TUBING (EMT)

TERMINATE ALL CONDUIT STUBS ABOVE ACCESSIBLE CEILING IN INDICATED SPACES.

COMPLY WITH INDUSTRY STANDARDS AND BEST PRACTICES IN CONDUIT ROUTING

MULTIPLE BENDS REGARDLESS OF WHAT IS INDICATED IN THE RISER DIAGRAMS. 6. CONTRACTOR SHALL COMPLY WITH INDUSTRY STANDARDS AND BEST PRACTICES IN

REGARD TO APPLICATION APPROPRIATE PRODUCTS FOR OUTDOOR OR DIRECT BURIAL

PROVIDING APPROPRIATE QUANTITY OF PULL BOXES ALONG ANY PATH WITH

UNLESS OTHERWISE INDICATED. (ALSO REFER TO NOTE 6 BELOW)

NYLON BUSHINGS SHALL BE PROVIDED ON ALL CONDUIT STUBS.

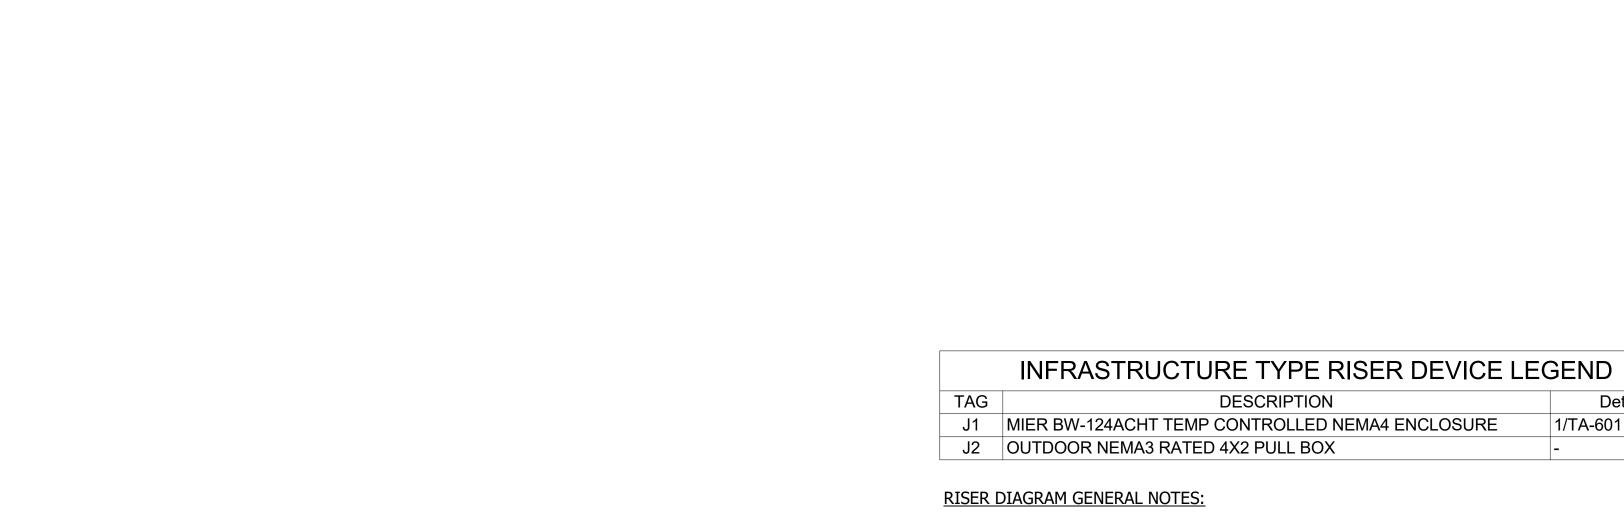
PROVIDE PULL STRING IN ALL CONDUIT RUNS.

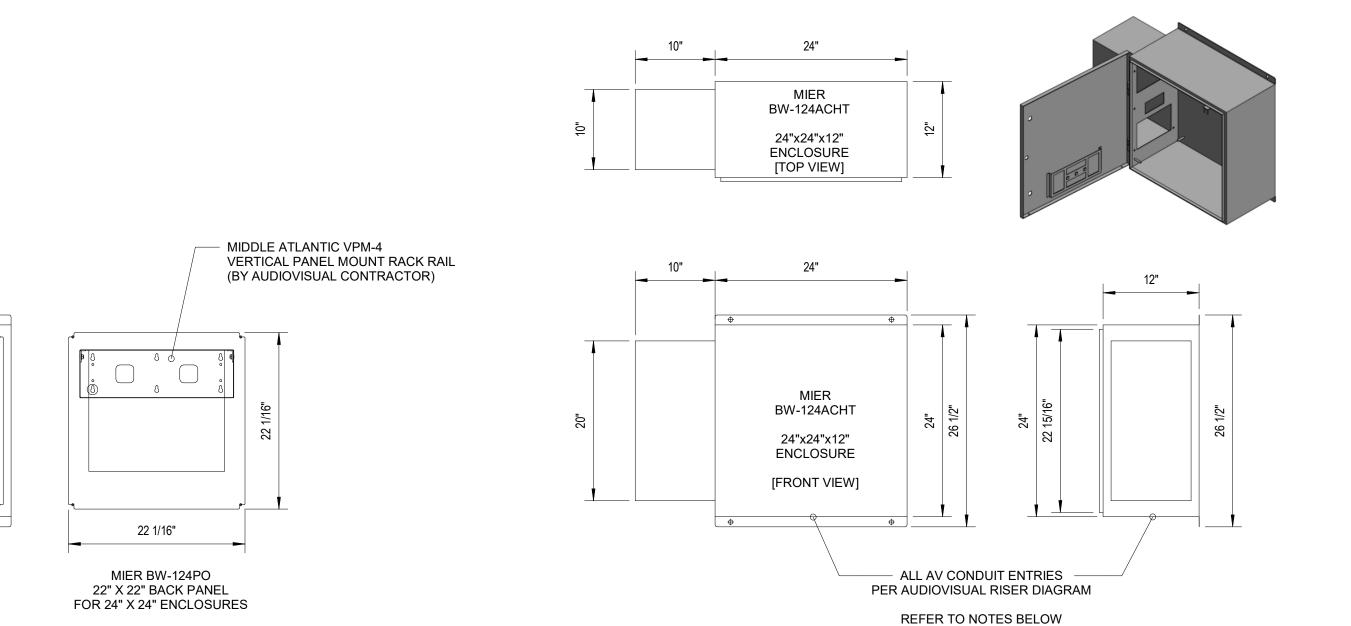
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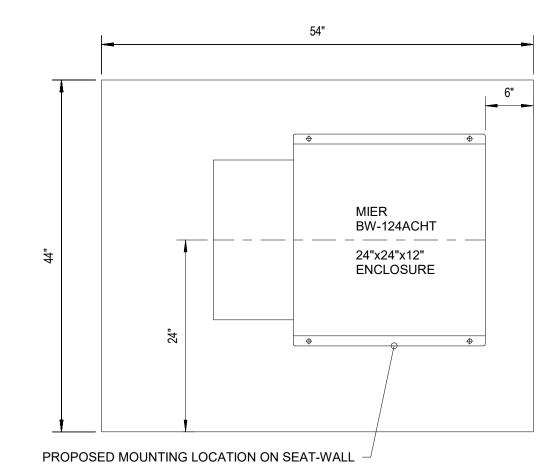
AUDIOVISUAL RISER DIAGRAM Submission:

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NOTES ON INSTALLER OR END-USER MODIFICATION TO NEMA RATED ENCLOSURES:

INSTALLERS OR END-USERS OF ELECTRICAL ENCLOSURES OFTEN MODIFY THE ENCLOSURE TO MEET THEIR INSTALLATION APPLICATIONS. TYPICAL MODIFICATIONS INCLUDE CUTTING HOLES IN THE ENCLOSURE TO RUN POWER AND CABLE INTO THE ENCLOSURE OR FOR AN ANTENNA. IN ORDER TO KEEP THE NEMA RATING INTEGRITY OF THE ENCLOSURE, AND PROTECT THE EQUIPMENT MOUNTED WITHIN, MIER PRODUCTS' ENGINEERING TEAM RECOMMENDS ANY RGS FITTING HOLES OR MODIFICATIONS BE SEALED WITH LIQUID-TIGHT CONDUIT FITTINGS. MOST INSTALLERS REMEMBER TO DO THIS AROUND THE OUTSIDE OF THE HOLES THEY CREATE, BUT YOU MUST ALSO REMEMBER TO SEAL THE INSIDE OF THE HOLE AS "GROUND CONDENSATION" MAY COME UP THROUGH WIRING CONDUIT RUNNING INTO THE GROUND, OR RAIN AND MOISTURE DROPLETS MAY TRAVEL THROUGH PVC OR PIPE COMING INTO THE ENCLOSURE FROM ABOVE, ALLOWING MOISTURE INSIDE THE ENCLOSURE. MIER RECOMMENDS ALL HOLES BE CUT INTO THE BOTTOM OF THE ENCLOSURE, SO THE ENTIRE UNIT CAN ACT AS A RAIN/SNOW/MOISTURE SHIELD. INSTALLERS OR END-USERS MAY TEST THEIR MODIFICATIONS IN THE FIELD WITH THE PROLONGED DIRECT WATER SPRAY METHOD. WE RECOMMEND INSTALLERS OR END-USERS PERFORM INSPECTIONS OF ALL MODIFICATIONS OVER TIME TO MAKE CERTAIN THEIR MODIFICATIONS CONTINUE TO MEET THE REQUIRED NEMA CRITERIA.

• MIER'S UL RECOGNIZED ENCLOSURE HEATERS WITH THERMOSTATS MAY BE ADDED INSIDE MIER'S NEMA 4, NEMA 4X OR NEMA 6/6P ENCLOSURES AND KEEP COMPONENTS WARM IN COLDER CLIMATES, AND RETAIN THE NEMA RATING

• MIER'S UL LISTED AND NEMA 4 THERMOSTATICALLY CONTROLLED AIR-CONDITIONERS ARE ADDED TO MIER'S ACE AND ACHT SERIES ENCLOSURES AND KEEP THE NEMA RATING

• WHEN INSTALLERS USE FITTINGS OR OTHER ACCESSORIES WITH AN OUTDOOR ENCLOSURE, THE ENTIRE ENCLOSURE DROPS TO THE LOWEST RATING OF THE FITTING OR ACCESSORY.

DO NOT MOUNT ENCLOSURES EQUIPPED WITH AIR-CONDITIONERS ON WALLS OF APARTMENTS, OFFICES, CONDOS OR HOMES DUE TO SLIGHT VIBRATION FROM THE AC.

NOTES ON MAINTENANCE OF NEMA RATED ENCLOSURES: ENCLOSURES WITH FILTERS FOR AIR-CONDITIONERS, FANS, OR VENTS SHOULD BE PROPERLY MAINTAINED AND CLEANED PER THE MANUFACTURER'S GUIDELINES. ENCLOSURES WITH GASKETS SHOULD BE PERIODICALLY INSPECTED TO MAKE CERTAIN THE GASKETS REMAIN IN GOOD CONDITION AND CONTINUE TO SEAL.

1 TEMPERATURE CONTROLLED OUTDOOR ENCLOSURE DETAIL Scale: 1" = 1'-0"

BW-124PO BACK PANEL W/ VPM-4 VERTICAL PANEL MOUNT RACK RAIL

SHOWN MOUNTED WITHIN MEIR BW-124ACHT ENCLOSURE





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GENERAL NOTES

1.0 DESIGN CRITERIA

- 1.1 Design Codes: a. IBC 2018 b. ANSI/ASCE-7 2016
- 1.2 Live Loads: a. Lateral Live load
- 1.3 Snow Load: Not applicable for this configuration.
- 1.4 Wind Load: a. Wind Risk Category b. Basic wind speed (3 sec. gust) 110 mph
 - c. Wind Exposure category d. Components & Cladding per ASCE-7 16 psf min.

2.0 STRUCTURAL STEEL

2.1 Structural steel work shall be in accordance with the AISC "Specifications for the Design, Fabrication and Erection of Structural Steel for Buildings" (ASD – 15th Edition) and the "Code of Standard Practice for Steel Buildings and Bridges".

- 2.2 Structural steel shall conform to the following:
 - a. Channels, angles, plates and miscellaneous connection material: ASTM A36 with a minimum yield strength of 36,000 psi, u.n.o. b. Steel Tubing: ASTM A500, Grade B, with a minimum yield strength of 46,000 psi for square and rectangular and 42,000 psi for round.
 - c. Steel sheet and miscellaneous connection material: Type 316 Stainless Steel alloy with a minimum yield strength of 42,000 psi,
- 2.3 Anchor bolts shall be Type 316 Stainless Steel, u.n.o.
- 2.4 Structural Steel Fabricator shall provide for vertical and horizontal field adjustment of support assemblies.
- 2.5 The Structural Steel Fabricator, and/or General Contractor, shall verify existing dimensions and conditions at the site. Any discrepancy found shall be reported to the Architect prior to preparation of shop drawings. Shop drawings shall include field measurements and conditions.
- 2.6 Cuts, holes, coping, etc. shall be shown on the shop drawings and made in the shop.

3.0 STRUCTURAL STEEL CONNECTIONS

- 3.1 All steel details and connections shall be in accordance with the requirements of "Specification for Structural Steel Building" and "Code of Standard Practice for Steel Buildings and Bridges" (ASD – 15th Edition).
- 3.2 For connection design and detailing, set connection work point at intersection of member centerlines, u.n.o.
- 3.3 Welding shall be in accordance with the "Structural Welding Code ANSI/AWS D1.1", American Welding Society, latest edition. Use E70XX electrodes.
- 3.4 Field welded surfaces shall be cleaned, ground smooth, and coated with appropriate primer/paint as specified.

4.0 POST INSTALLED ANCHORS

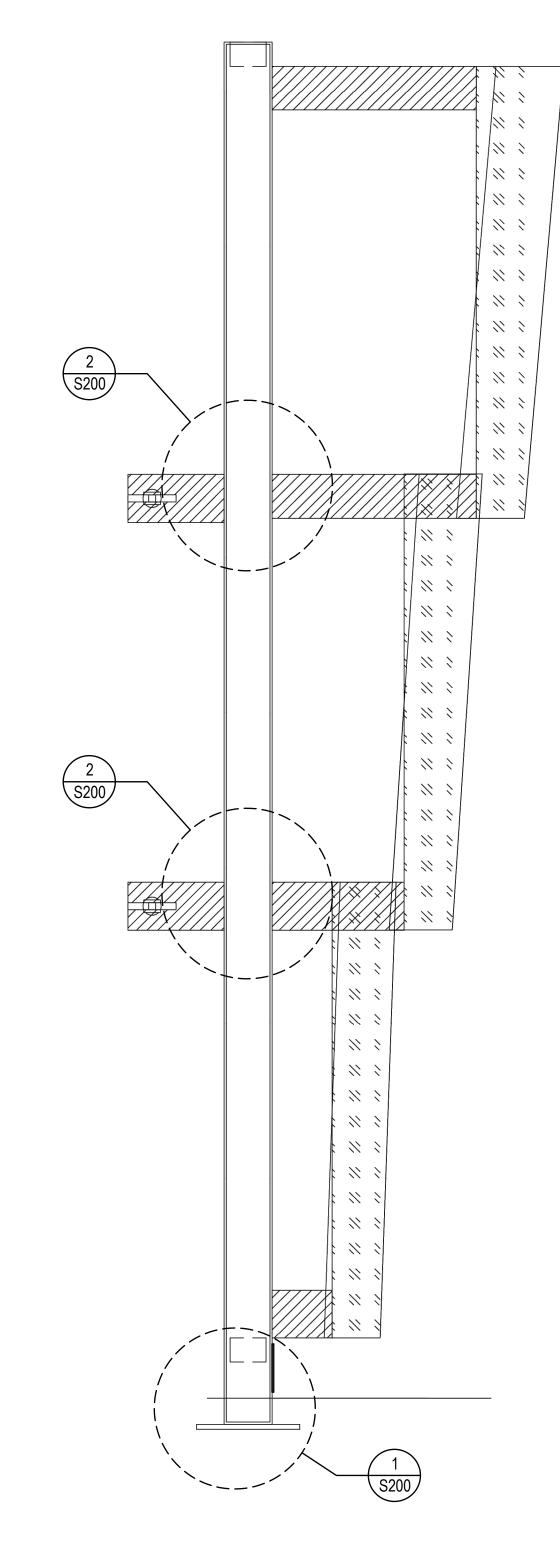
- 4.1 Post installed anchors shall be used only where specified on structural drawings.
- 4.2 The installation of post installed anchors for missing or misplaced cast in place anchors shall be approved by the engineer of record (EOR).
- 4.3 Anchors shall be installed in strict accordance with manufacturer's printed installation instructions in conjunction with edge distance, spacing and embedment depths as indicated on the drawings.
- 4.4 The contractor shall arrange for a manufacturer's field representative to provide installation training for all products to be used, prior to the commencement of work. Only trained installers shall perform post installed anchor installation. A record of training shall be kept on site and be made available to the EOR/IOR as requested.
- 4.5 Concrete adhesive anchors must be installed in concrete aged a minimum of 21 days (ACI 318-11 D.2.2).

5.0 SPECIAL INSPECTIONS FOR KSS SCOPE

- 5.1 INSPECTION AGENCY:
 - a. Inspection agency or individual shall be retained by the owner or contractor to conduct the inspections and testing outlined below and as defined in Chapter 17 of the International Building Code b. Special Inspectors shall keep records of all inspections and tests
 - and submit records to the Architect.


STRUCTURAL STEEL

- Material Certificates of Compliance Periodic Welding – Fillet welds < 5/16" Periodic Inspection of steel frame connections
- ANCHOR BOLTS
- Anchor bolt placement Post-installed anchors
- Periodic Periodic Periodic



CURTAIN CALL - TYPICAL UNIT SECTION



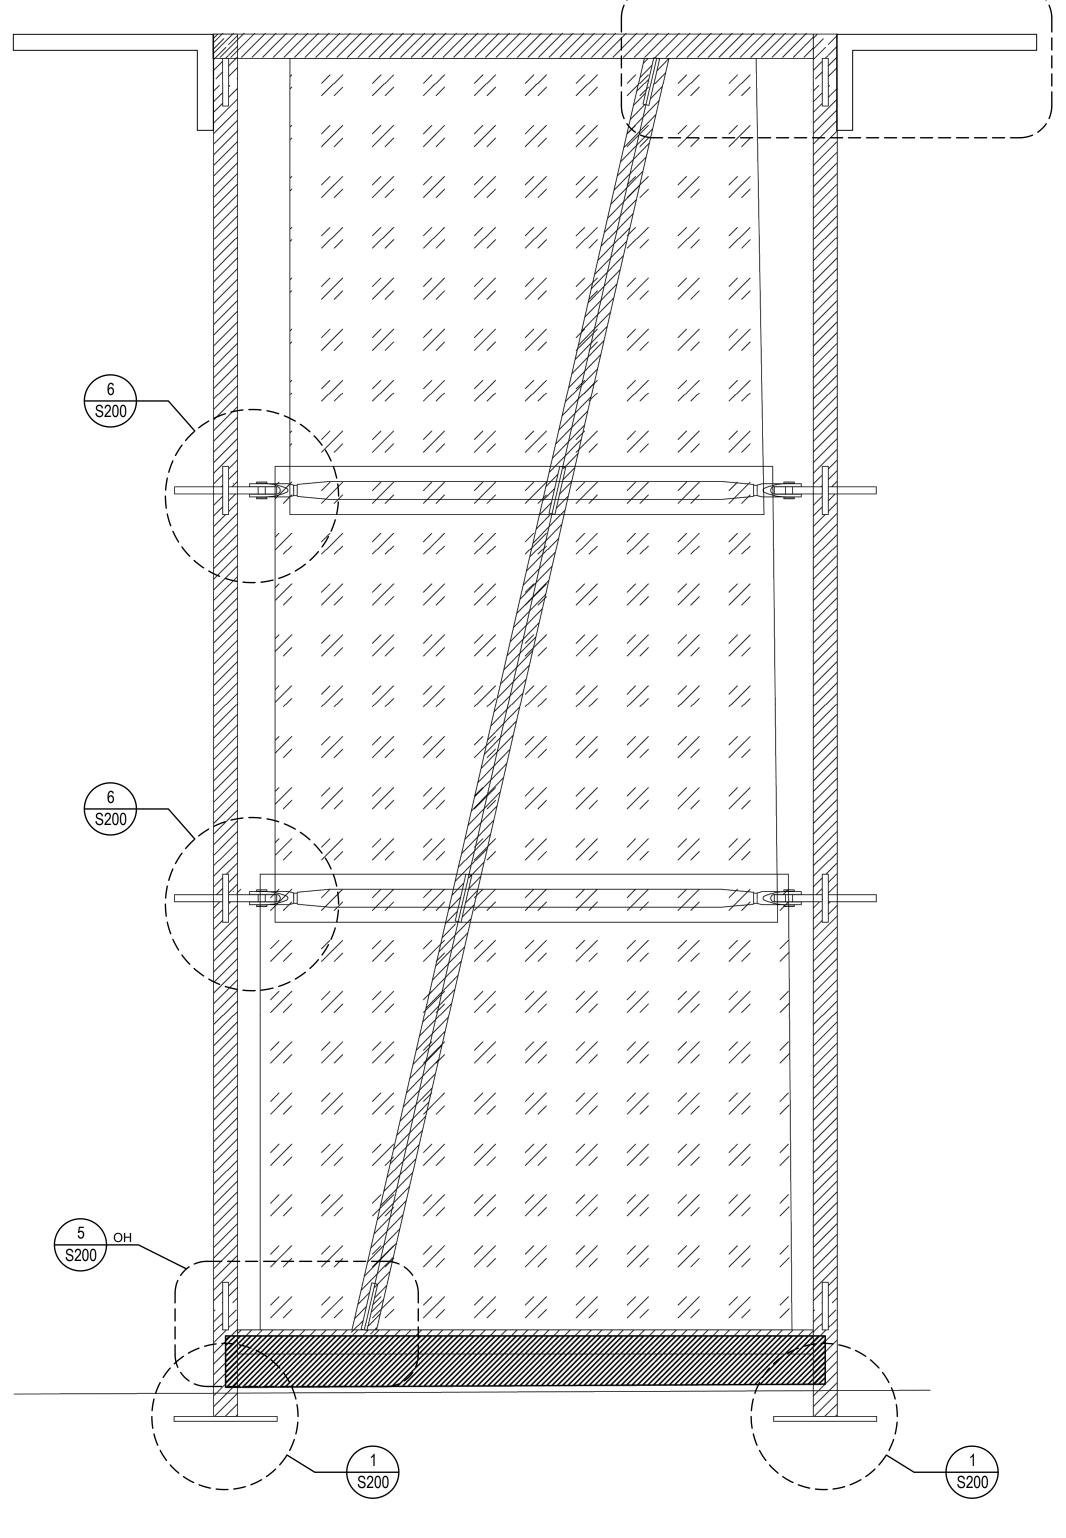

CURTAIN CALL - TYPICAL UNIT ELEVATION B







\ Keystone Structural

Lower Hill-Curtain Call Pittsburgh, PA



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Curtain Call - Structure Overview

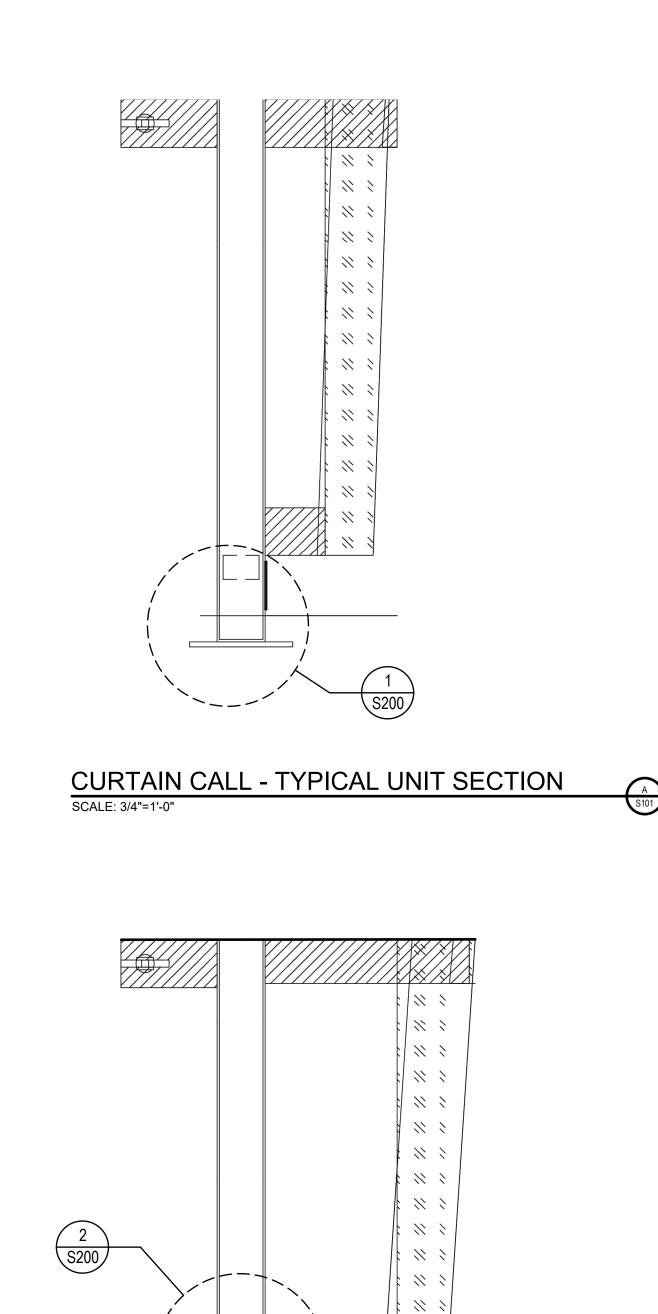
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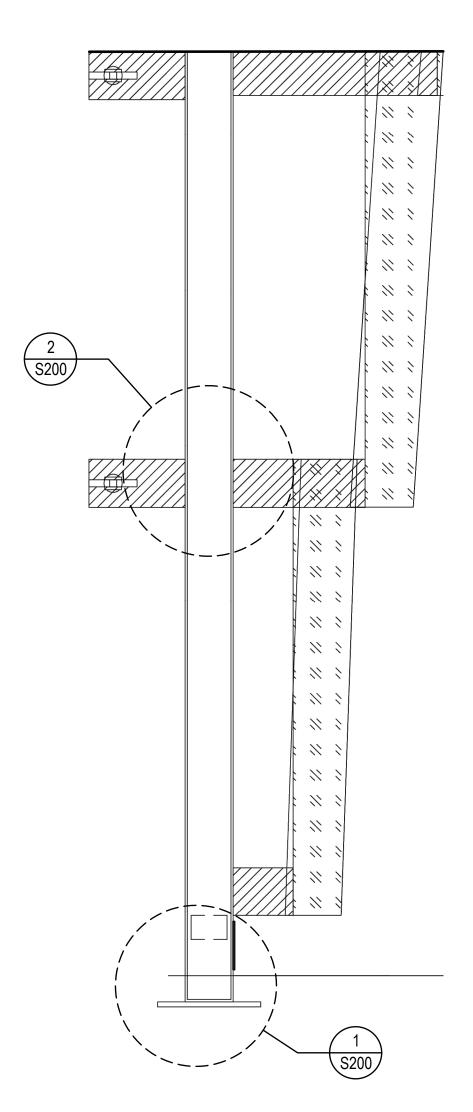
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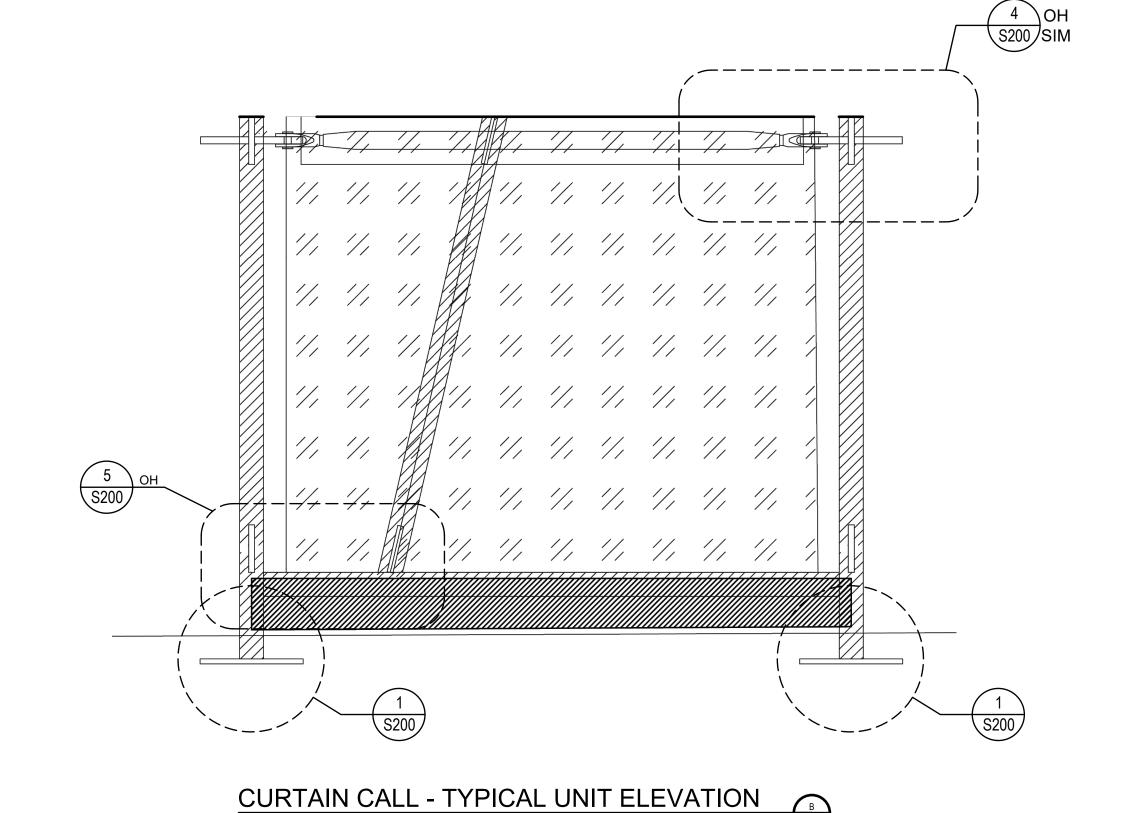
express written consent of owner.

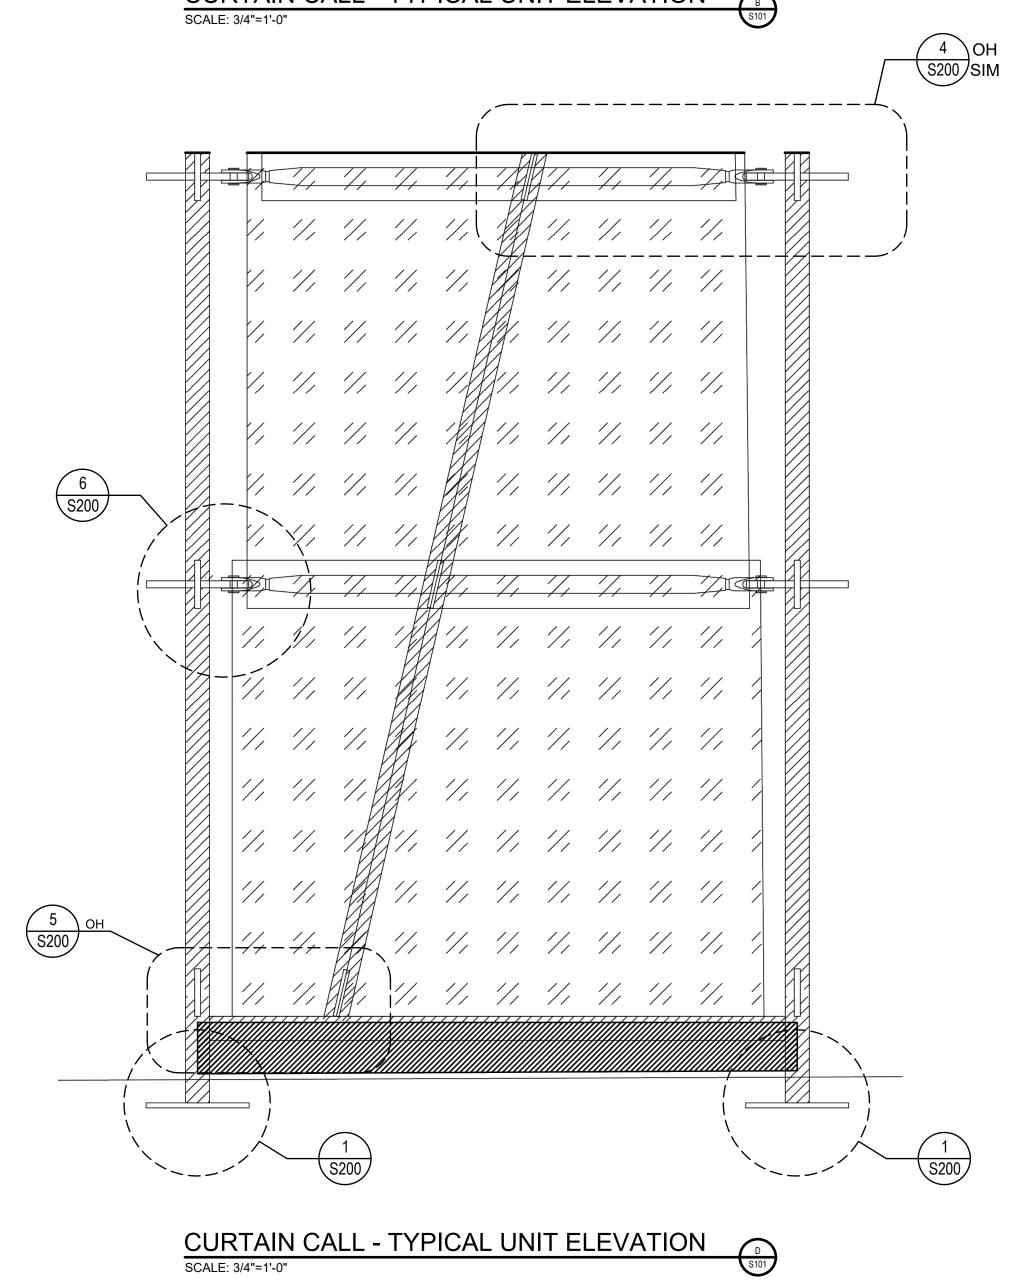
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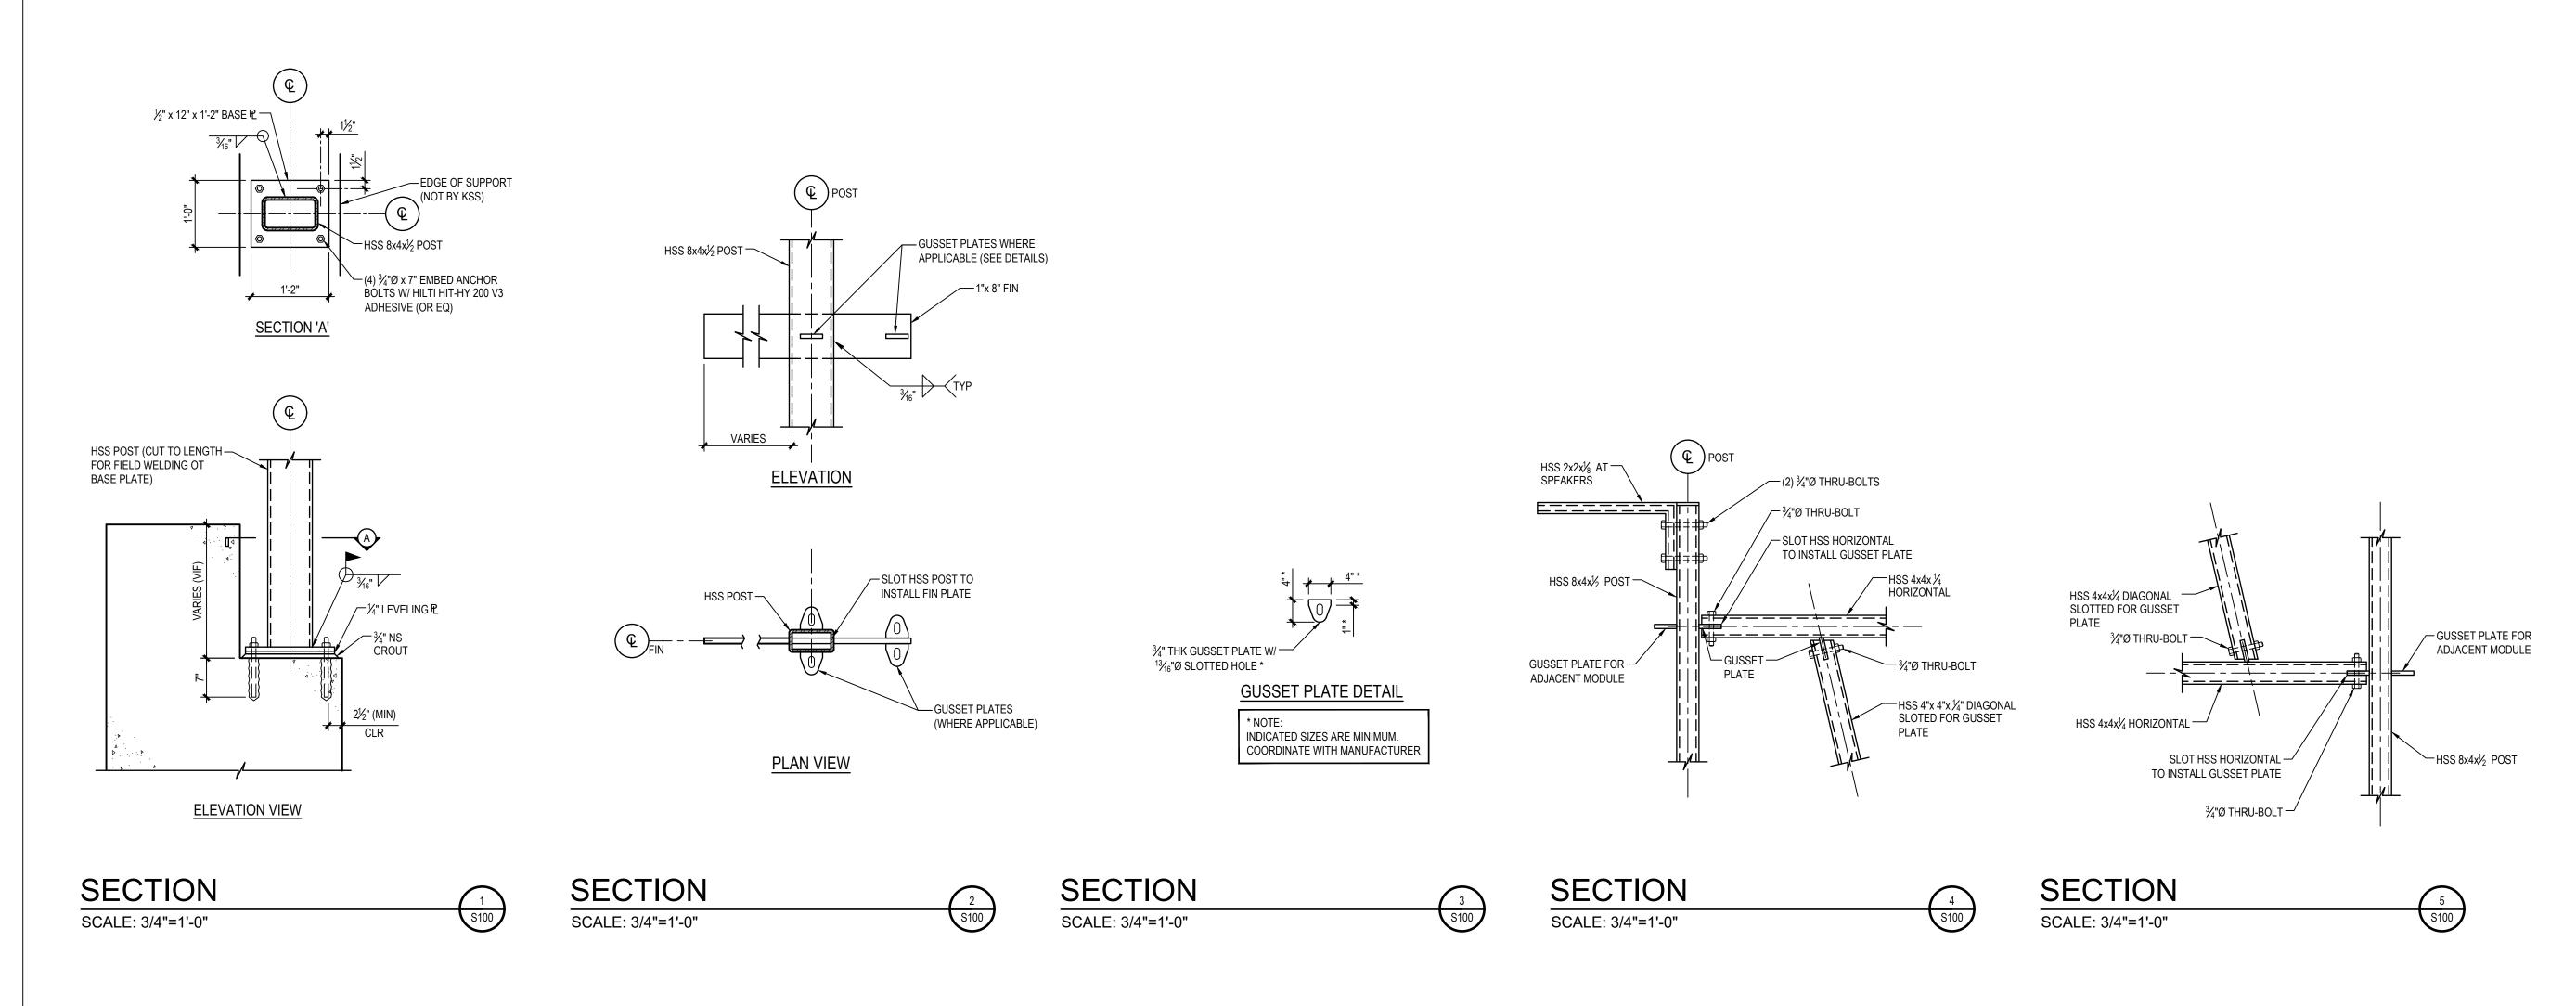
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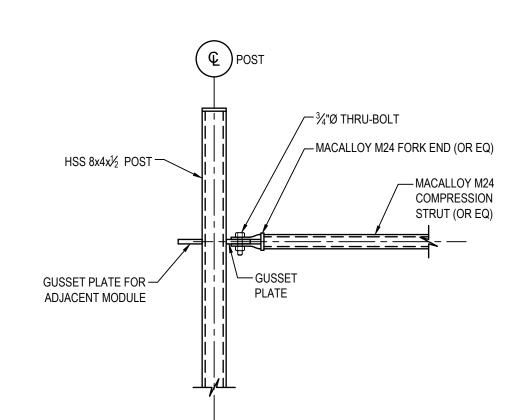
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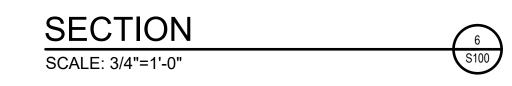
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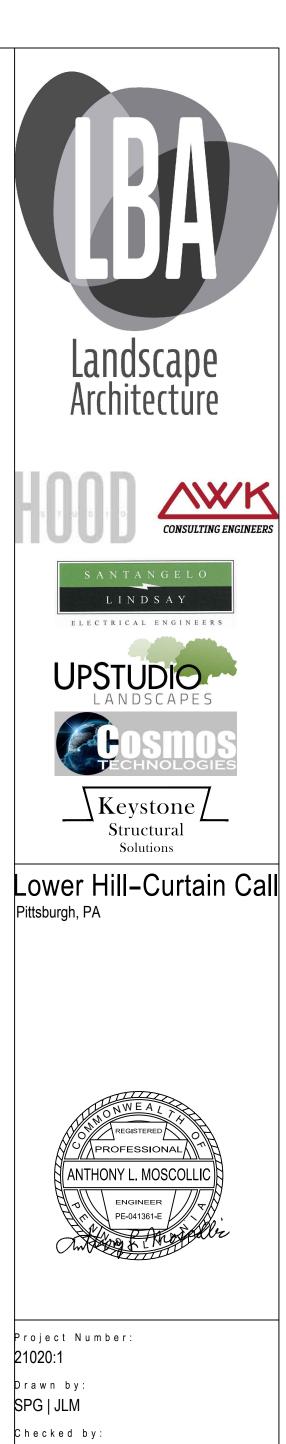
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Curtain Call - Structure Details

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